

WILLIAMS
& DEAN
ASSOCIATED
ARCHITECTS

E I G H T E E N
CORPORATE HILL DRIVE
LITTLE ROCK, AR 72205
P 501-224-1900
F 501-224-0873

MONROW BOUTIQUE
THE VILLAGE at HENDRIX

CONWAY, ARKAINSAAS

SHEET TITLE

**FLOOR PLAN AND
REFLECTED CEILING
PLAN**

REVISION: :DATE



1 21 SEPT 2012




8 SEPT 2012 :ISSUE
DATE

2-096 :PROJECT
NUMBER

SHEET NUMBER

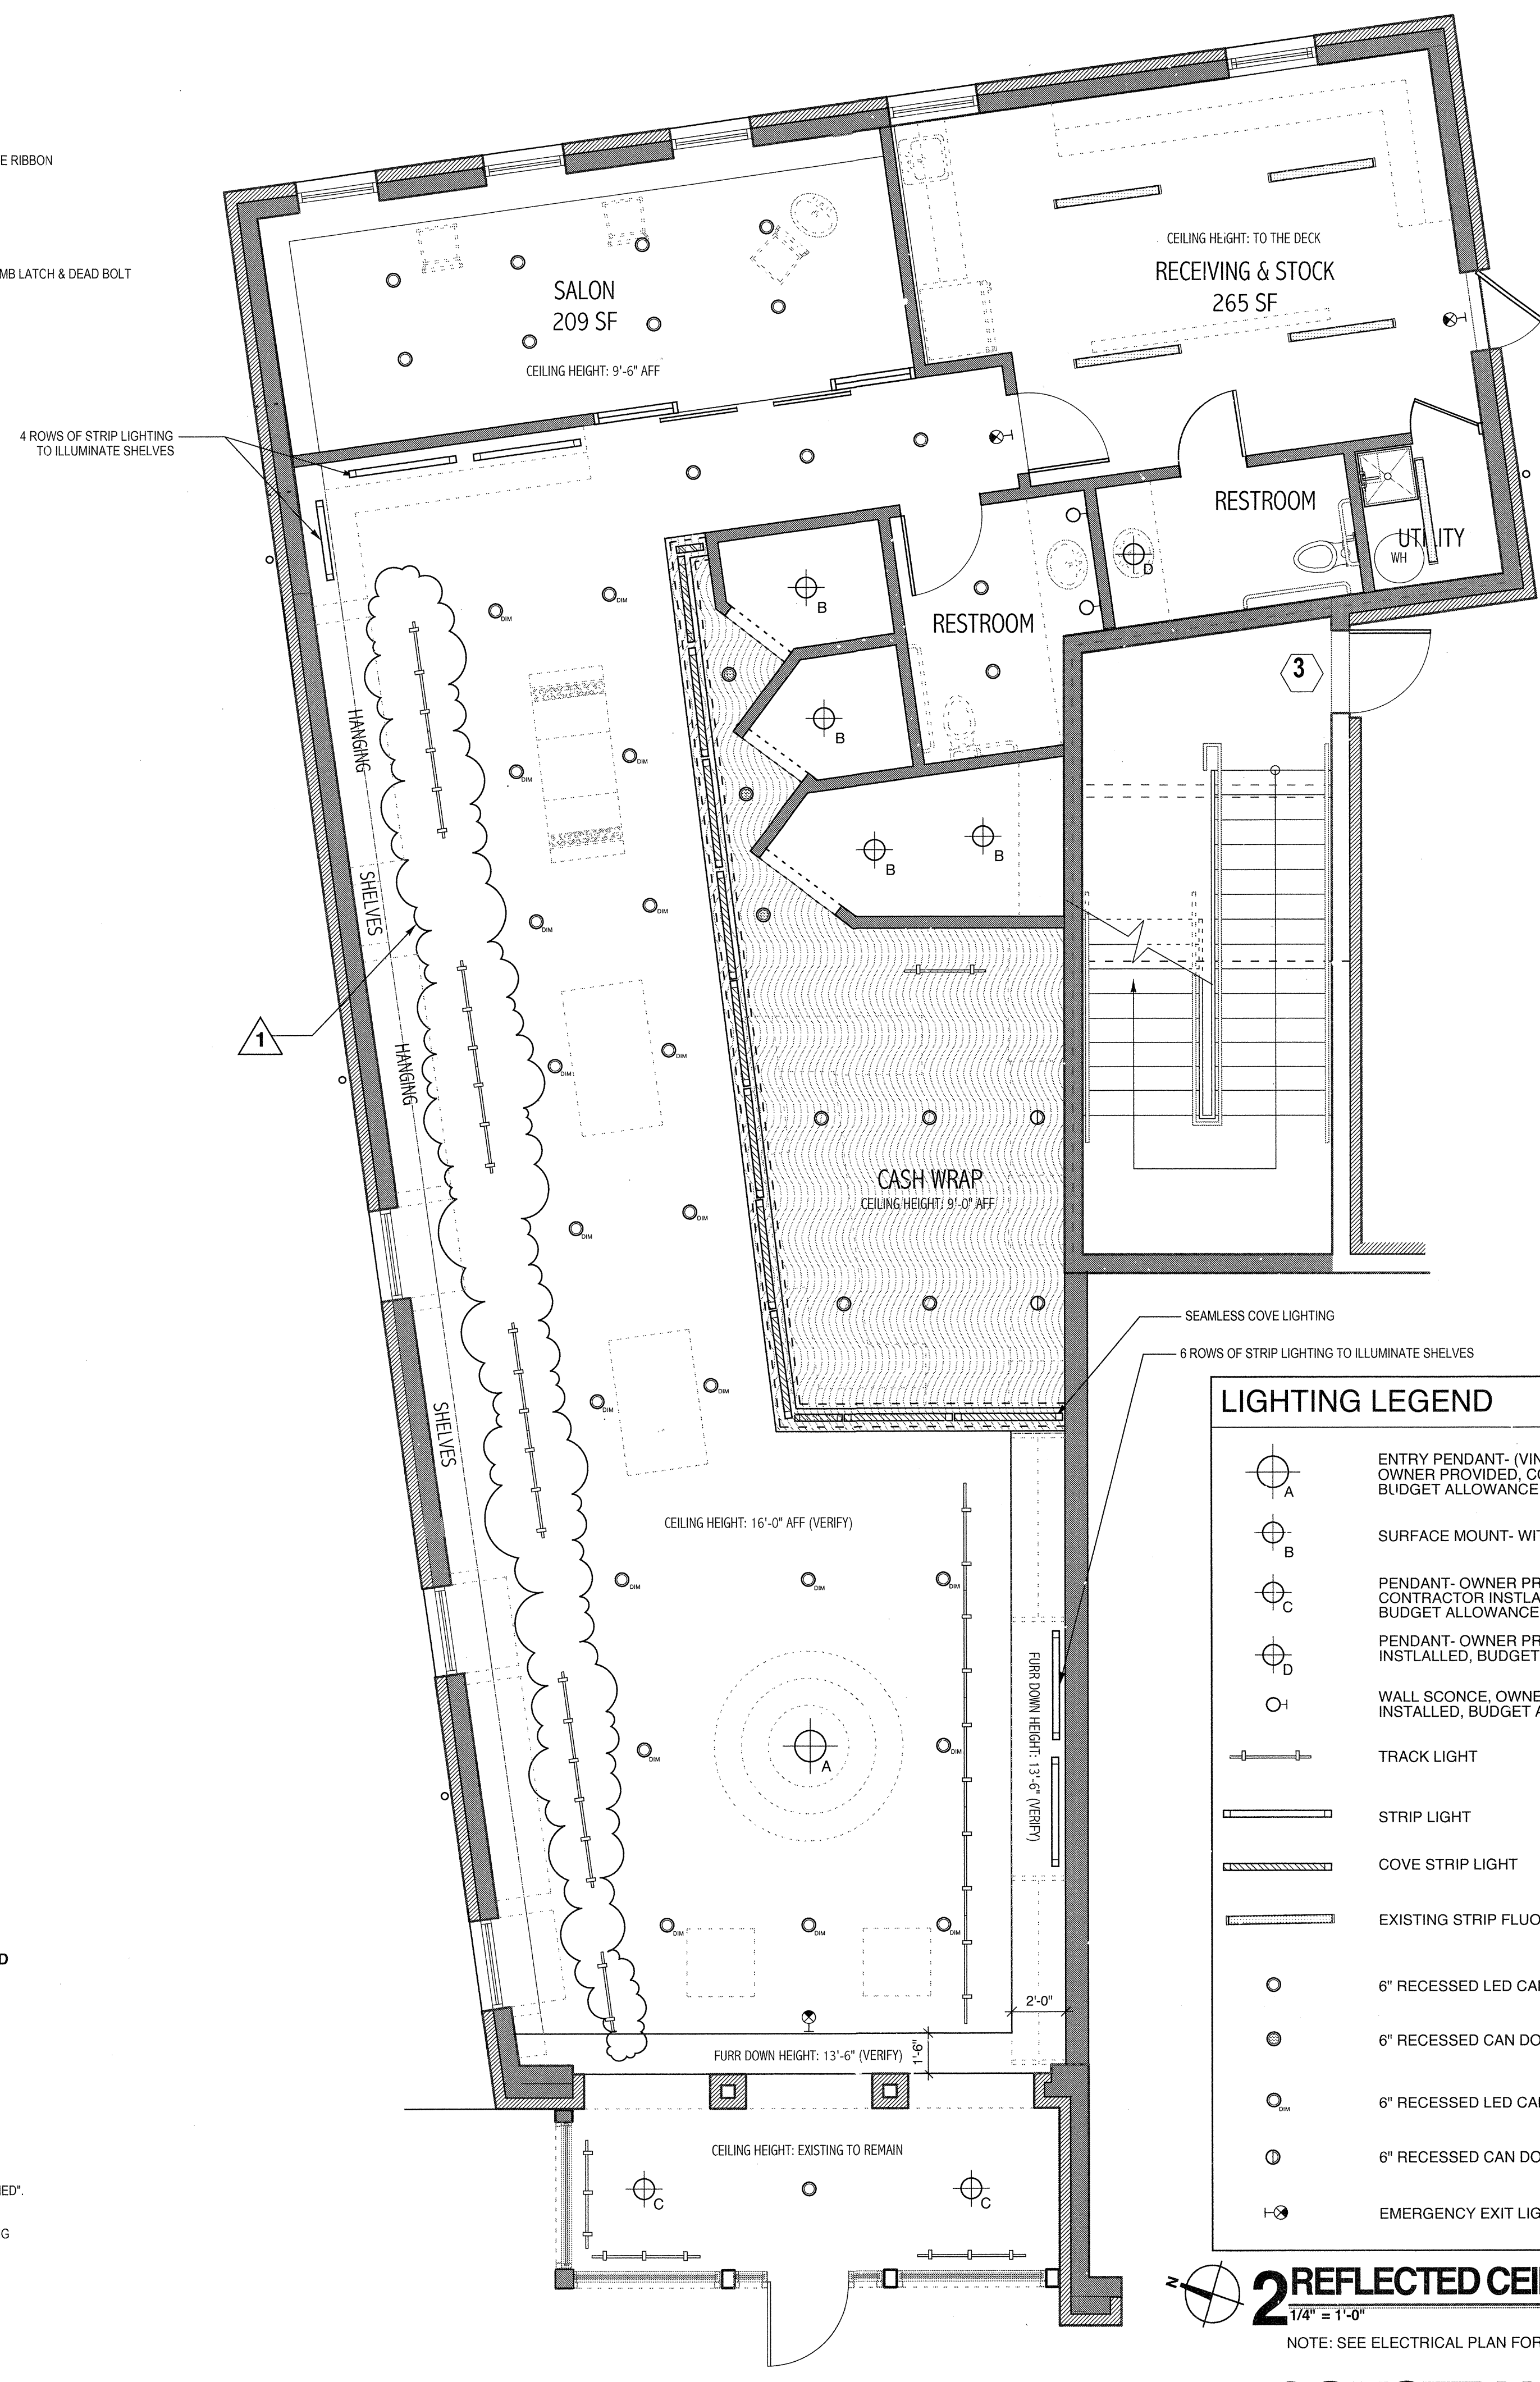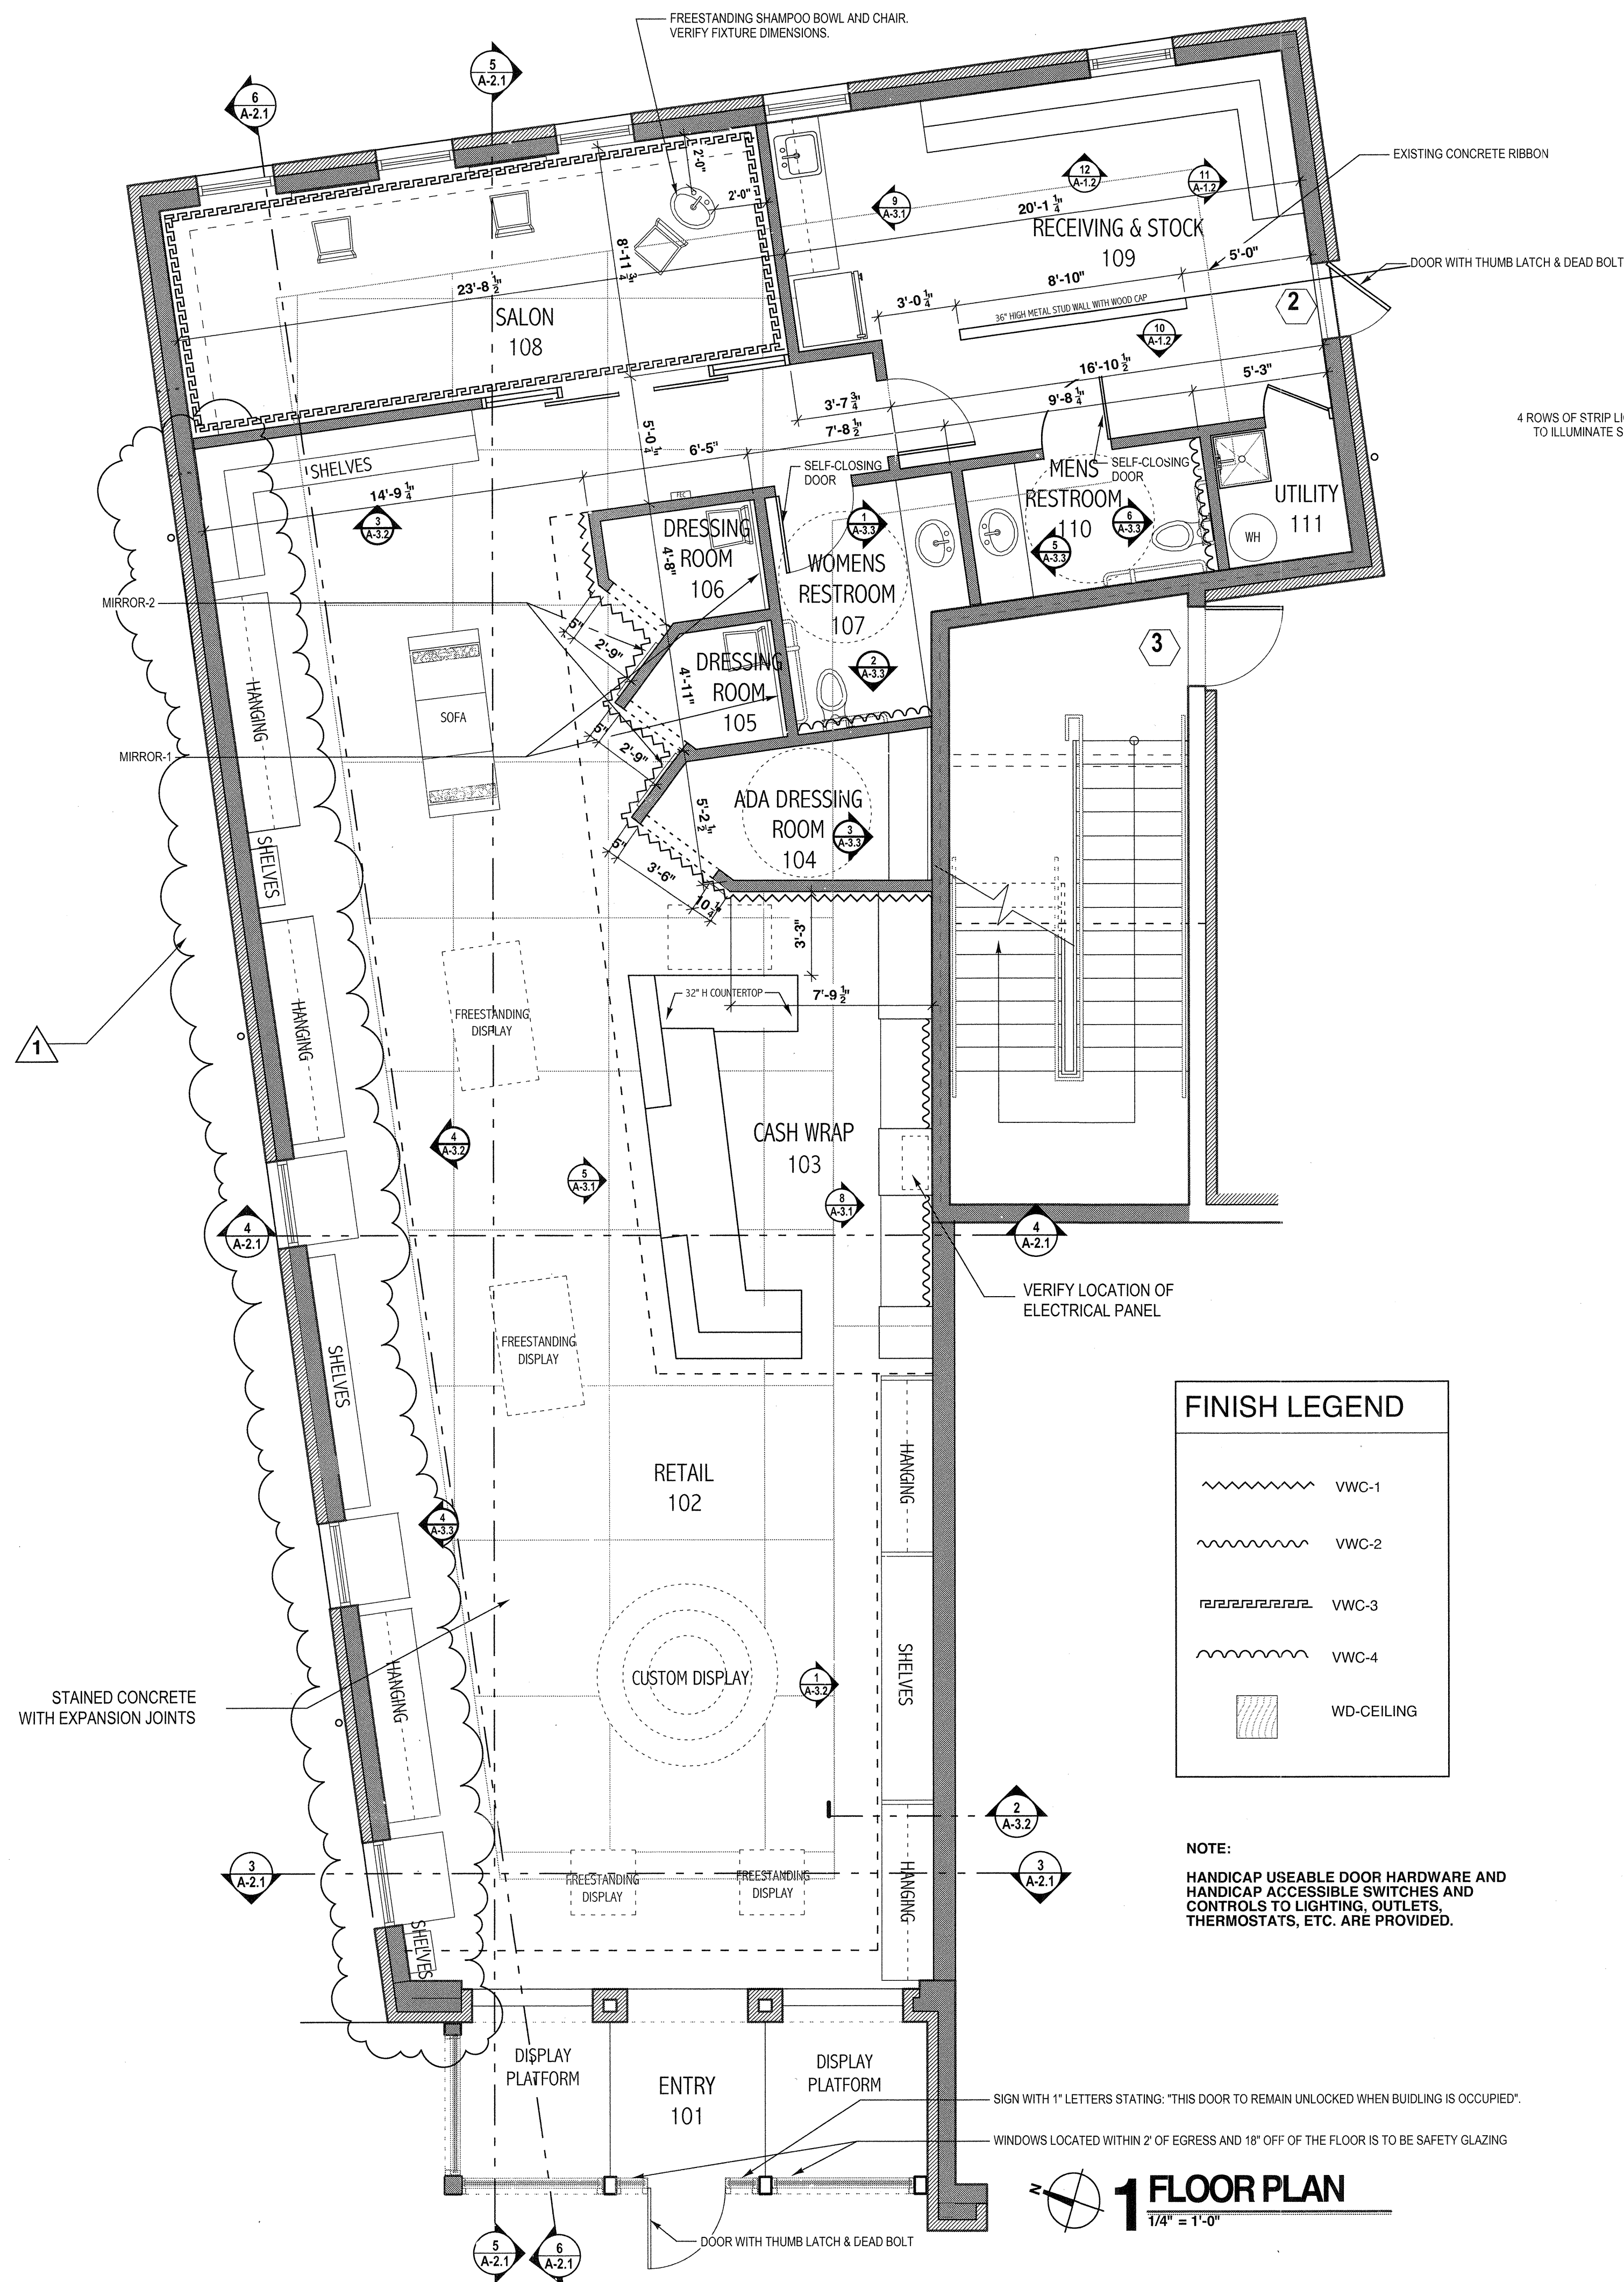

LIGHTING LEGEND

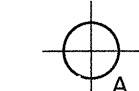

ENTRY PENDANT- (VINTAGE CHANDELIER)
OWNER PROVIDED, CONTRACTOR INSTALLED,
BUDGET ALLOWANCE \$600




SURFACE MOUNT- WITH DIFFUSER




PENDANT- OWNER PROVIDED,
CONTRACTOR INSTALLED,
BUDGET ALLOWANCE \$250




PENDANT- OWNER PROVIDED, CONTRACTOR
INSTALLED, BUDGET ALLOWANCE, \$150

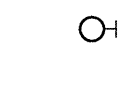


WALL SCONE, OWNER PROVIDED, CONTRACTOR
INSTALLED, BUDGET ALLOWANCE \$150

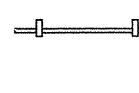


TRACK LIGHT

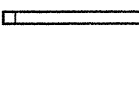

STRIP LIGHT

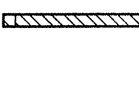

COVE STRIP LIGHT

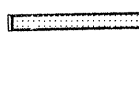

EXISTING STRIP FLUORESCENT PENDANT LIGHTS



6" RECESSED LED CAN DOWNLIGHT



6" RECESSED CAN DOWNLIGHT- WITH DIFFUSER







2 REFLECTED CEILING PLAN

NOTE: SEE ELECTRICAL PLAN FOR ADDITIONAL FIXTURES

CONSTRUCTION SET A-1.1

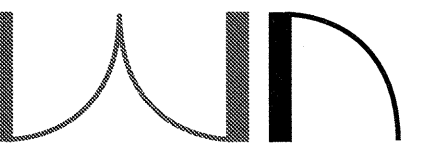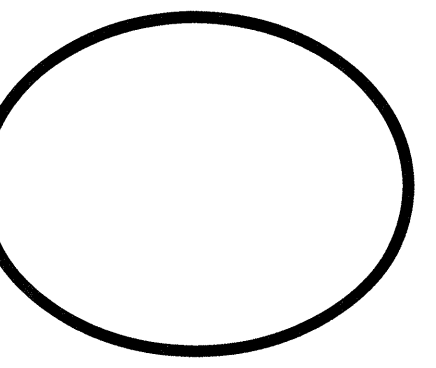

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THE VILLAGE at HENDRIX

CONWAY, ARKANSAS

SHEET TITLE
INTERIOR & EXTERIOR
ELEVATIONS

REVISION: DATE

1 21 SEPT 2012











18 SEPT 2012 ISSUE DATE

12-096 PROJECT NUMBER

SHEET NUMBER

A-2.1

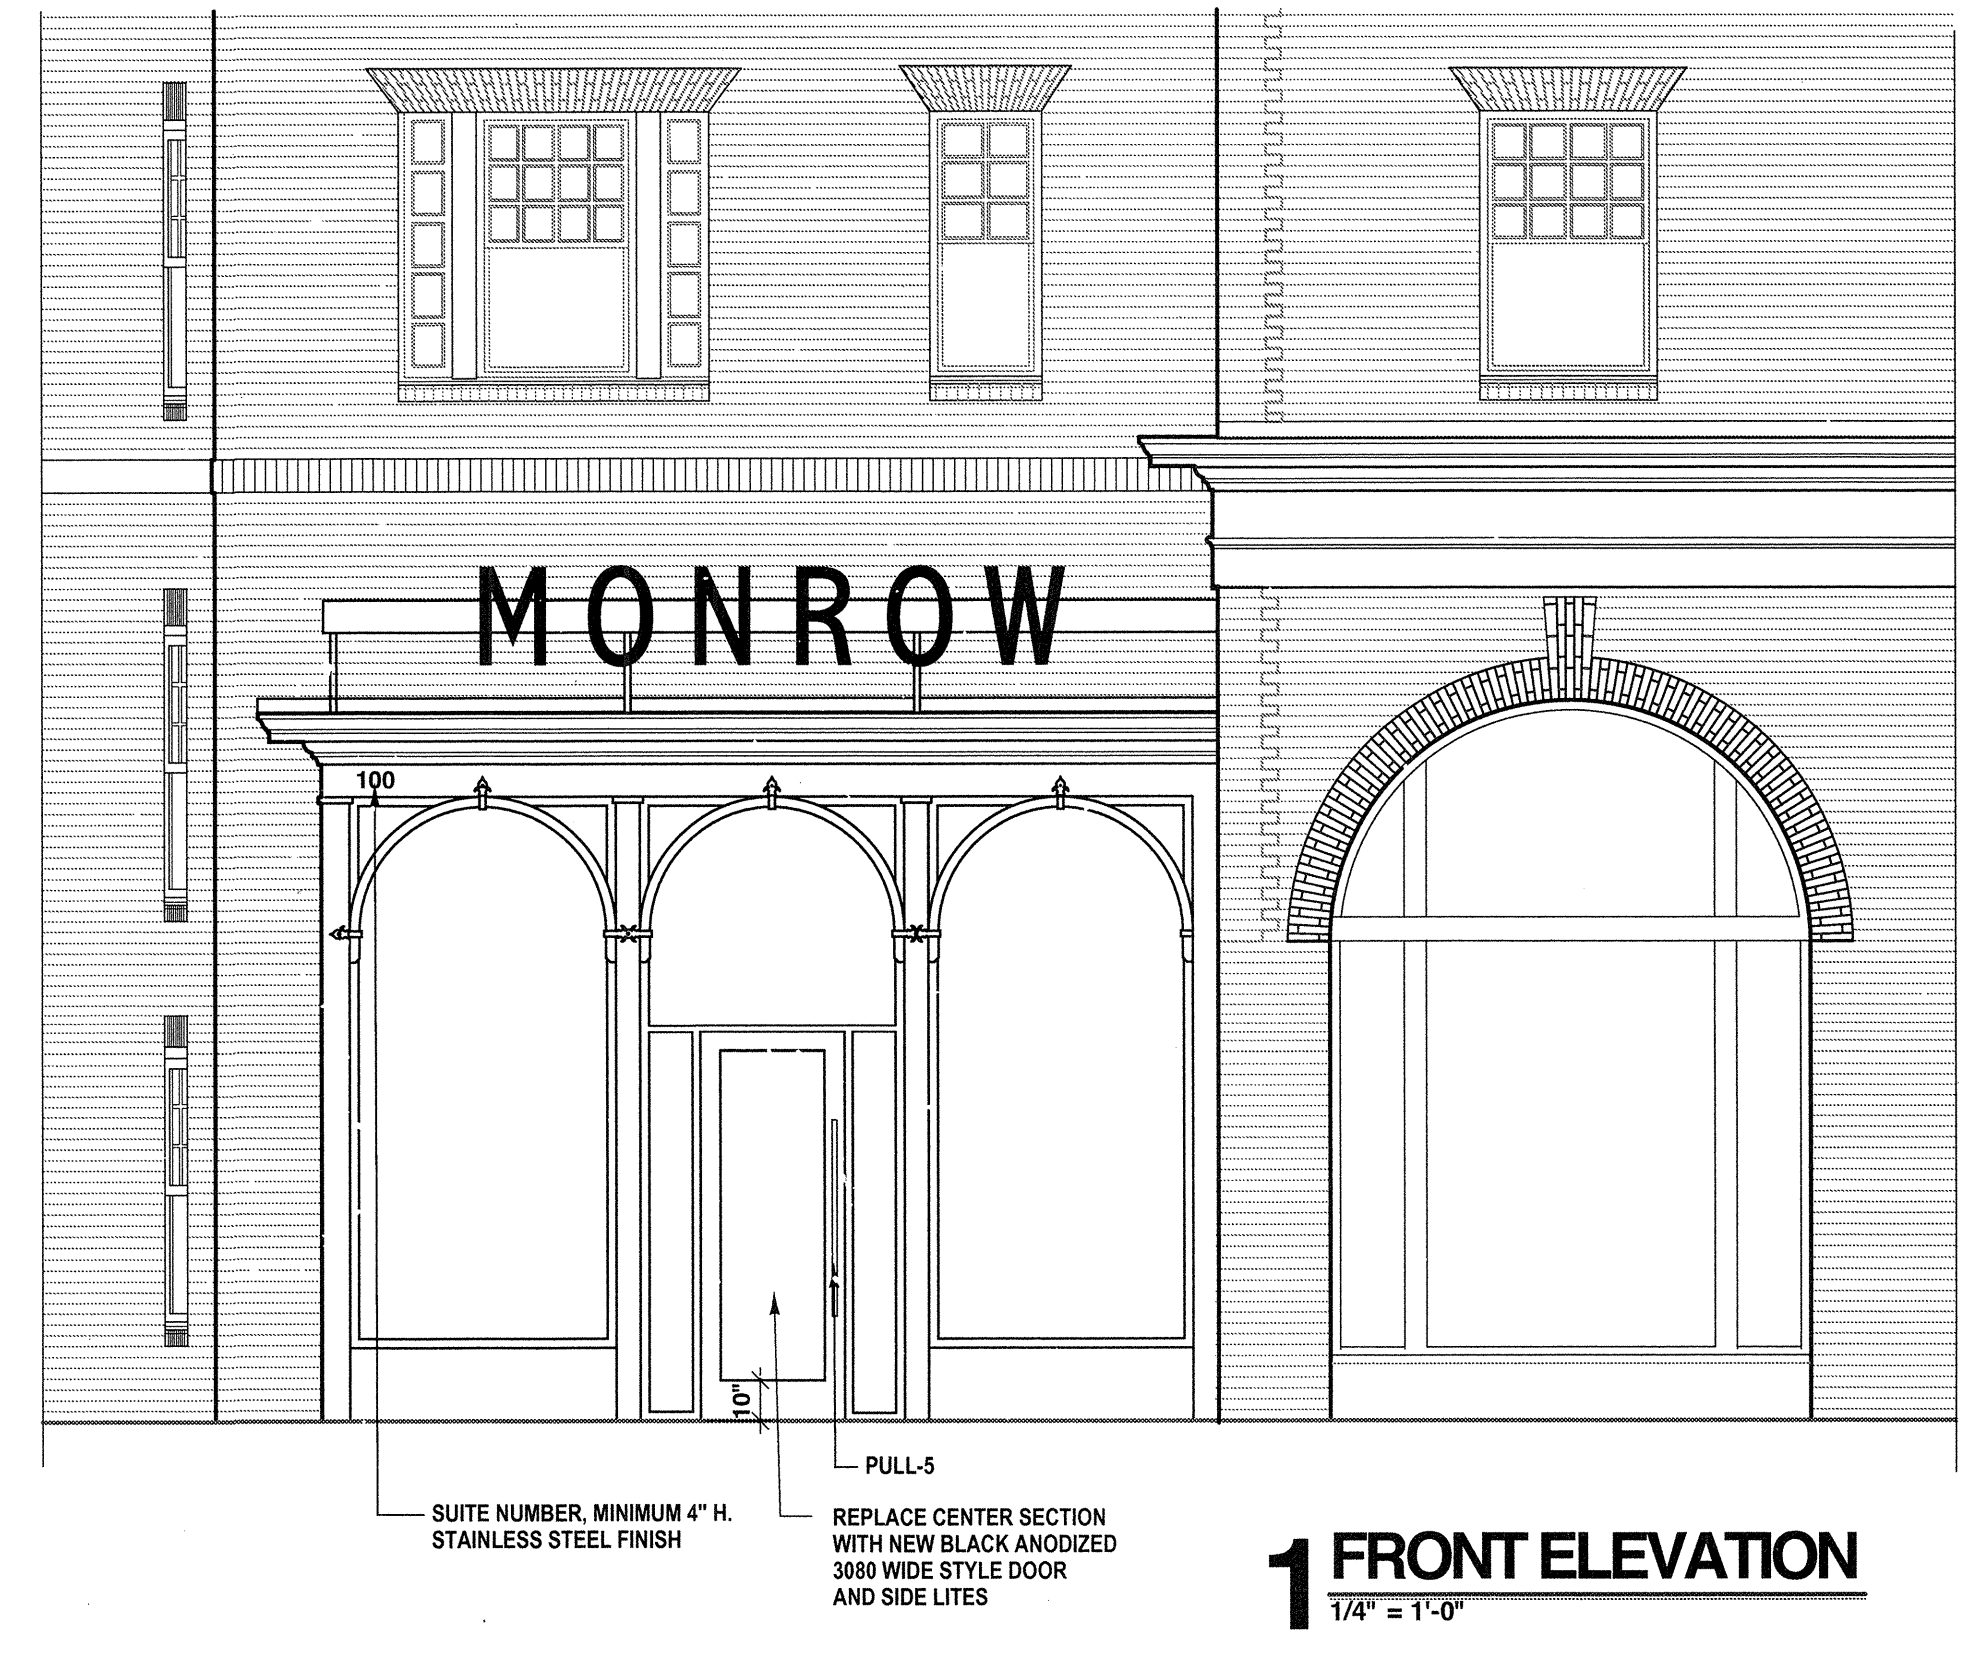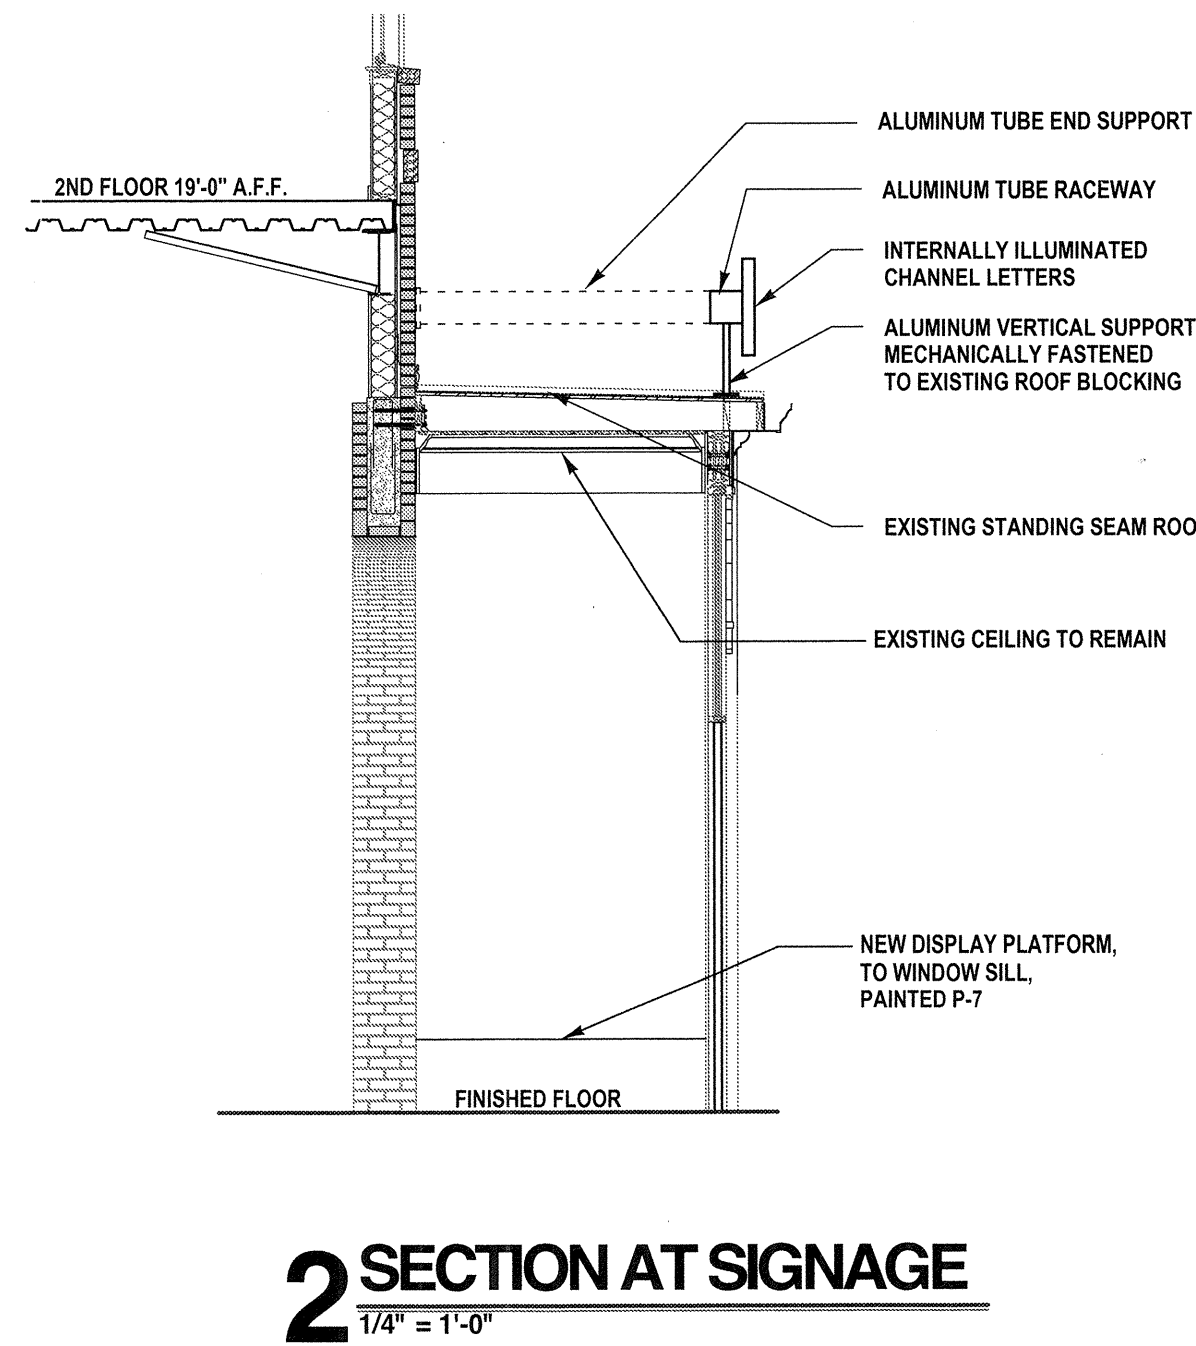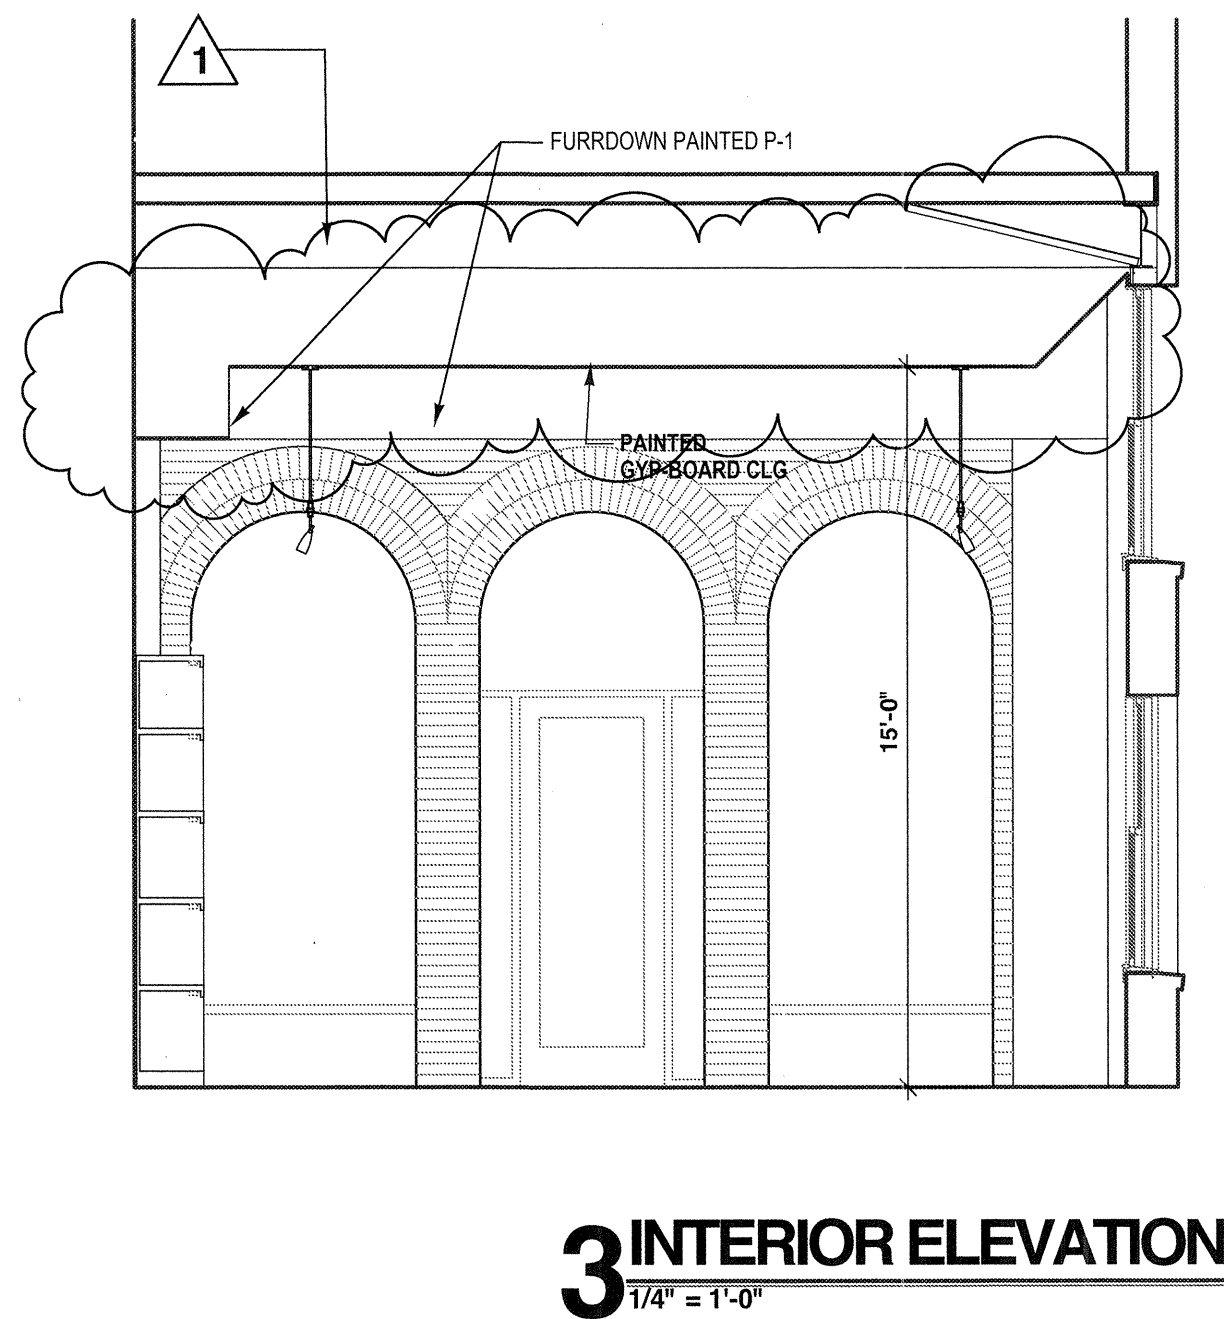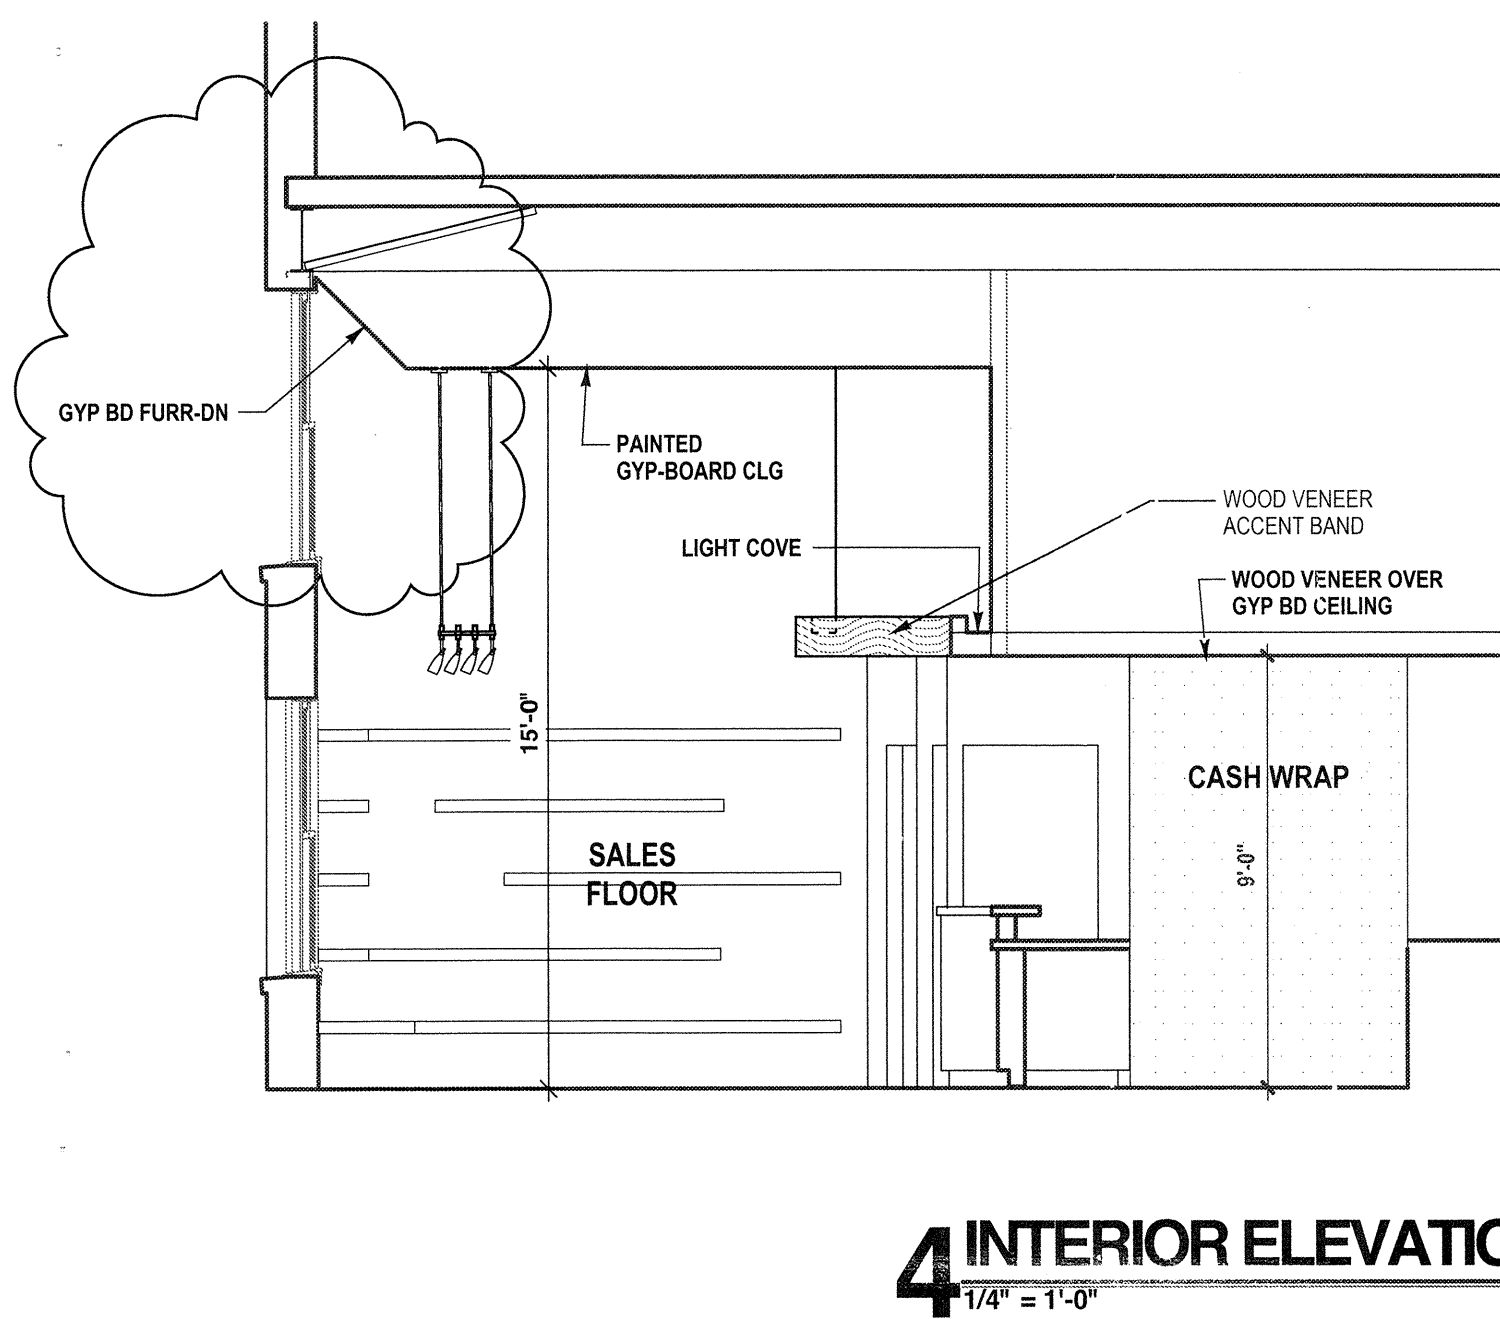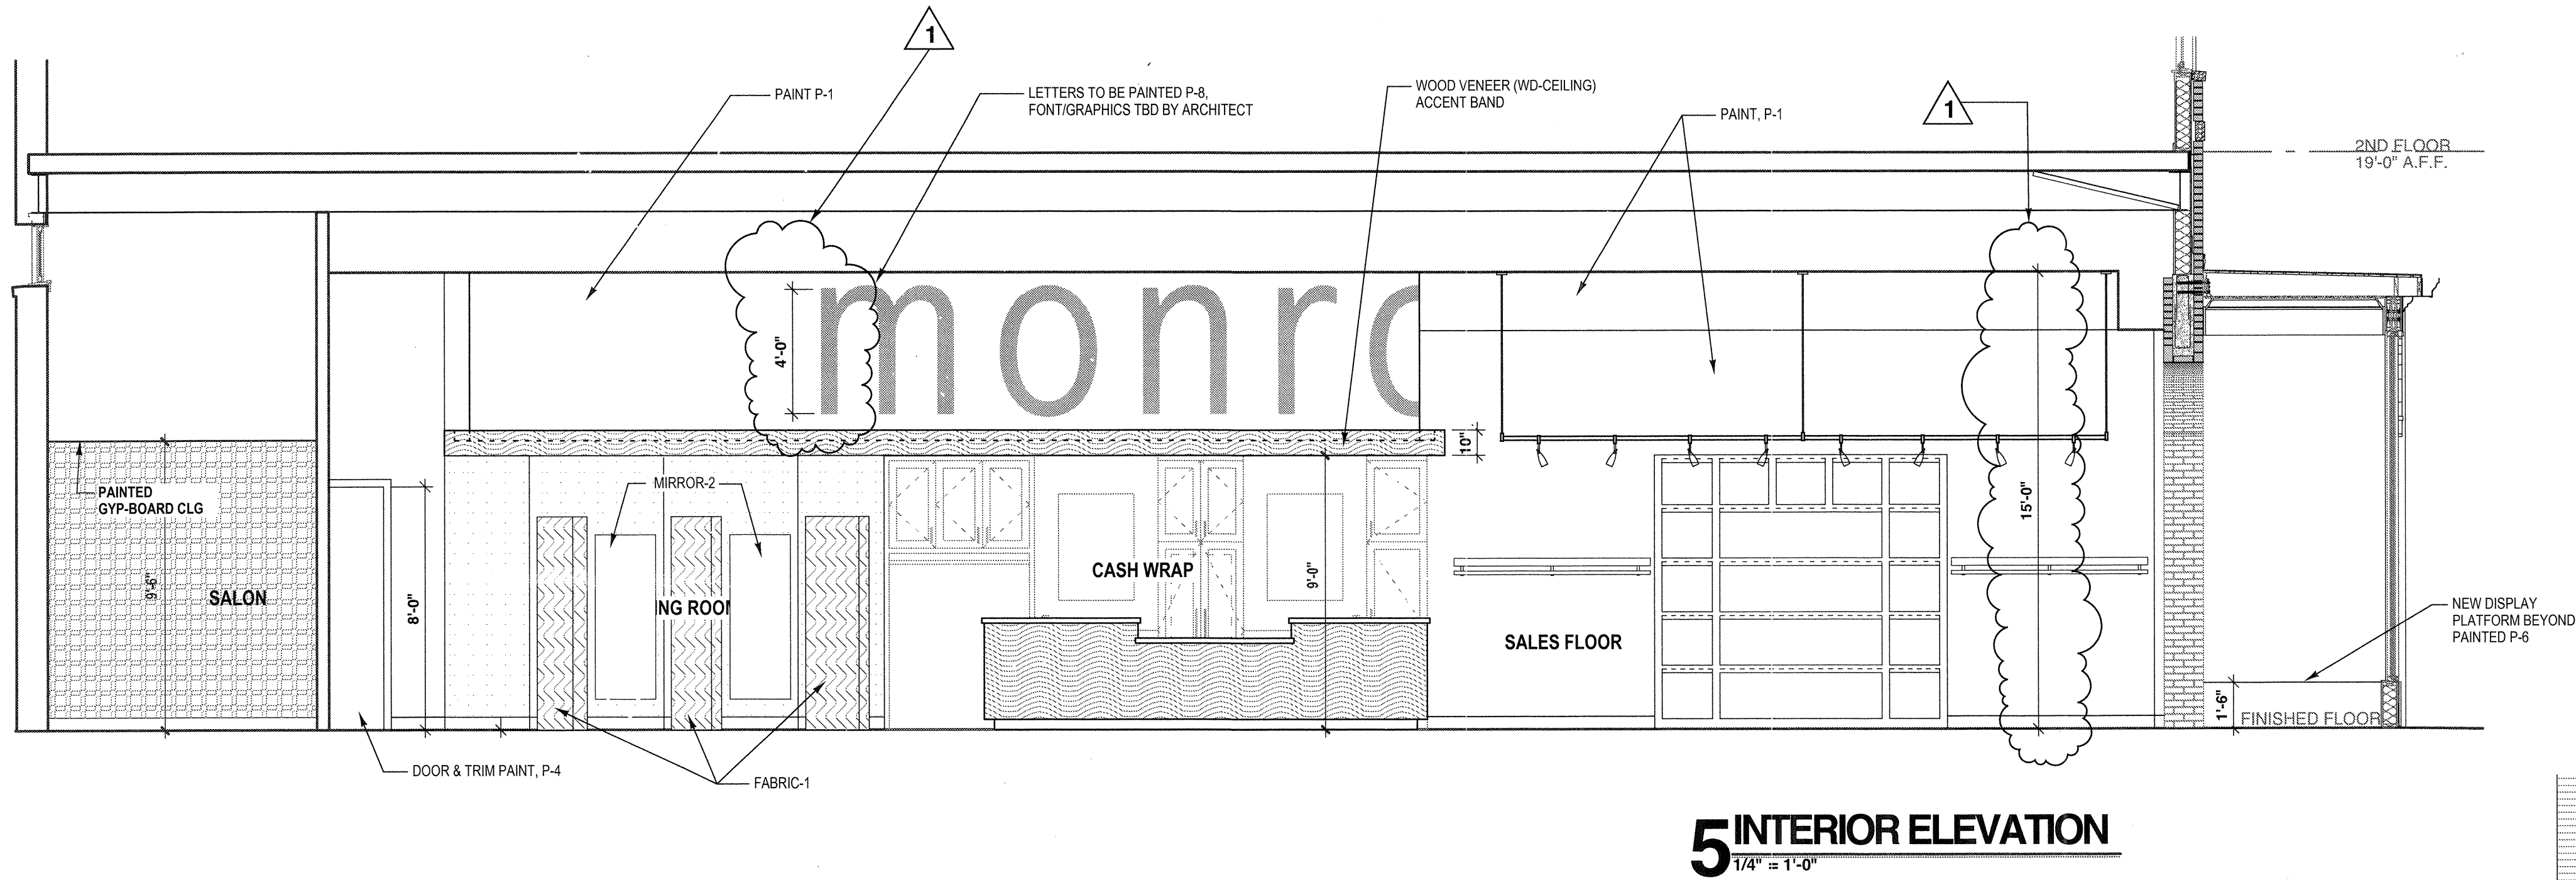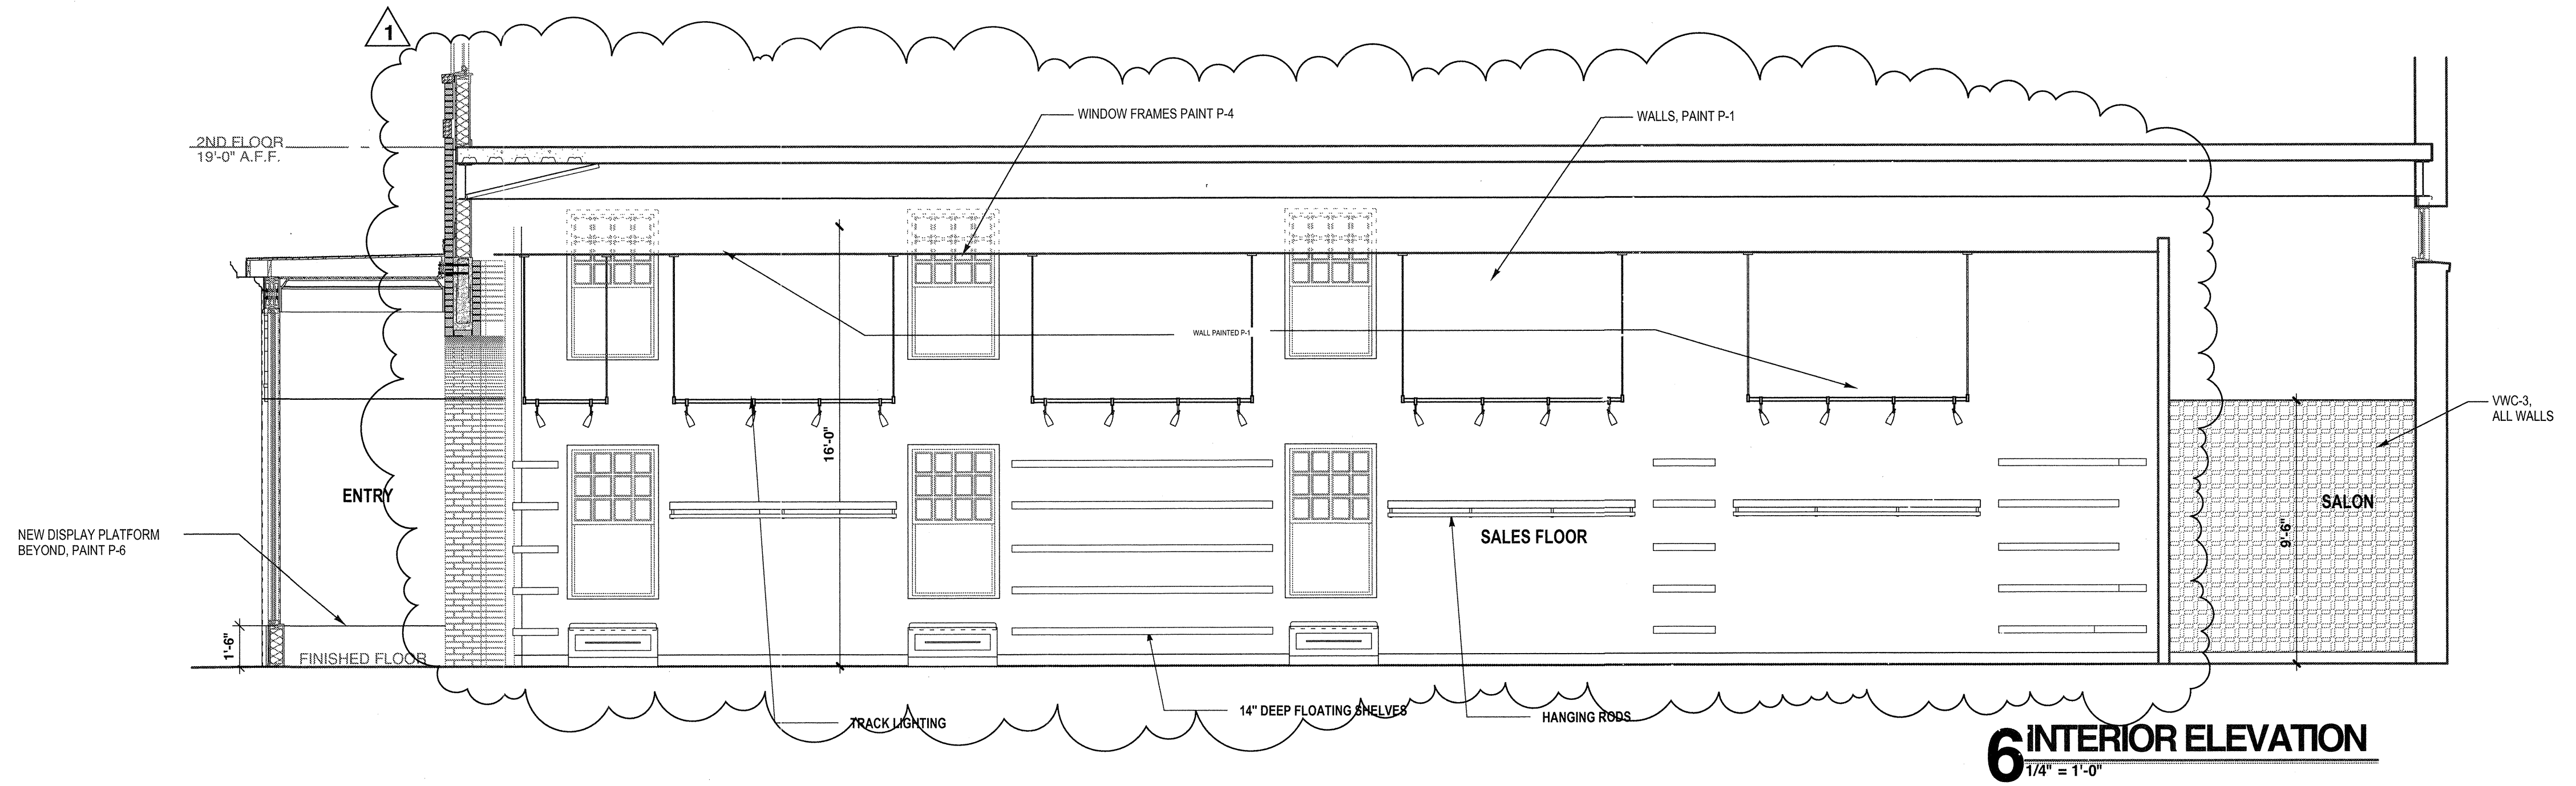

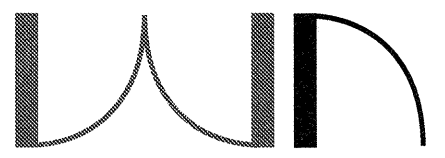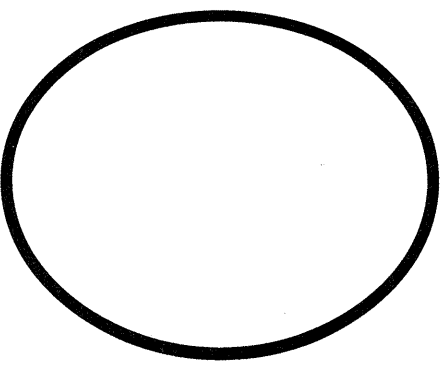


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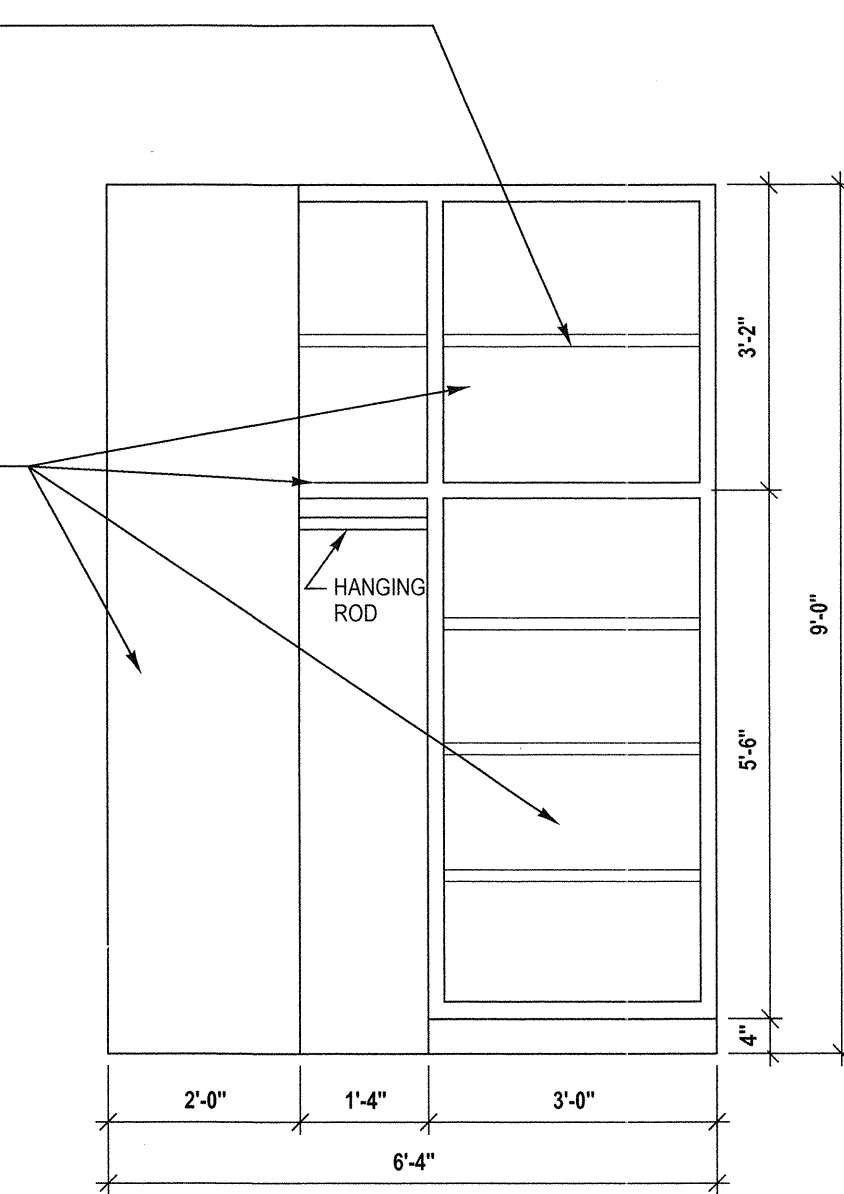
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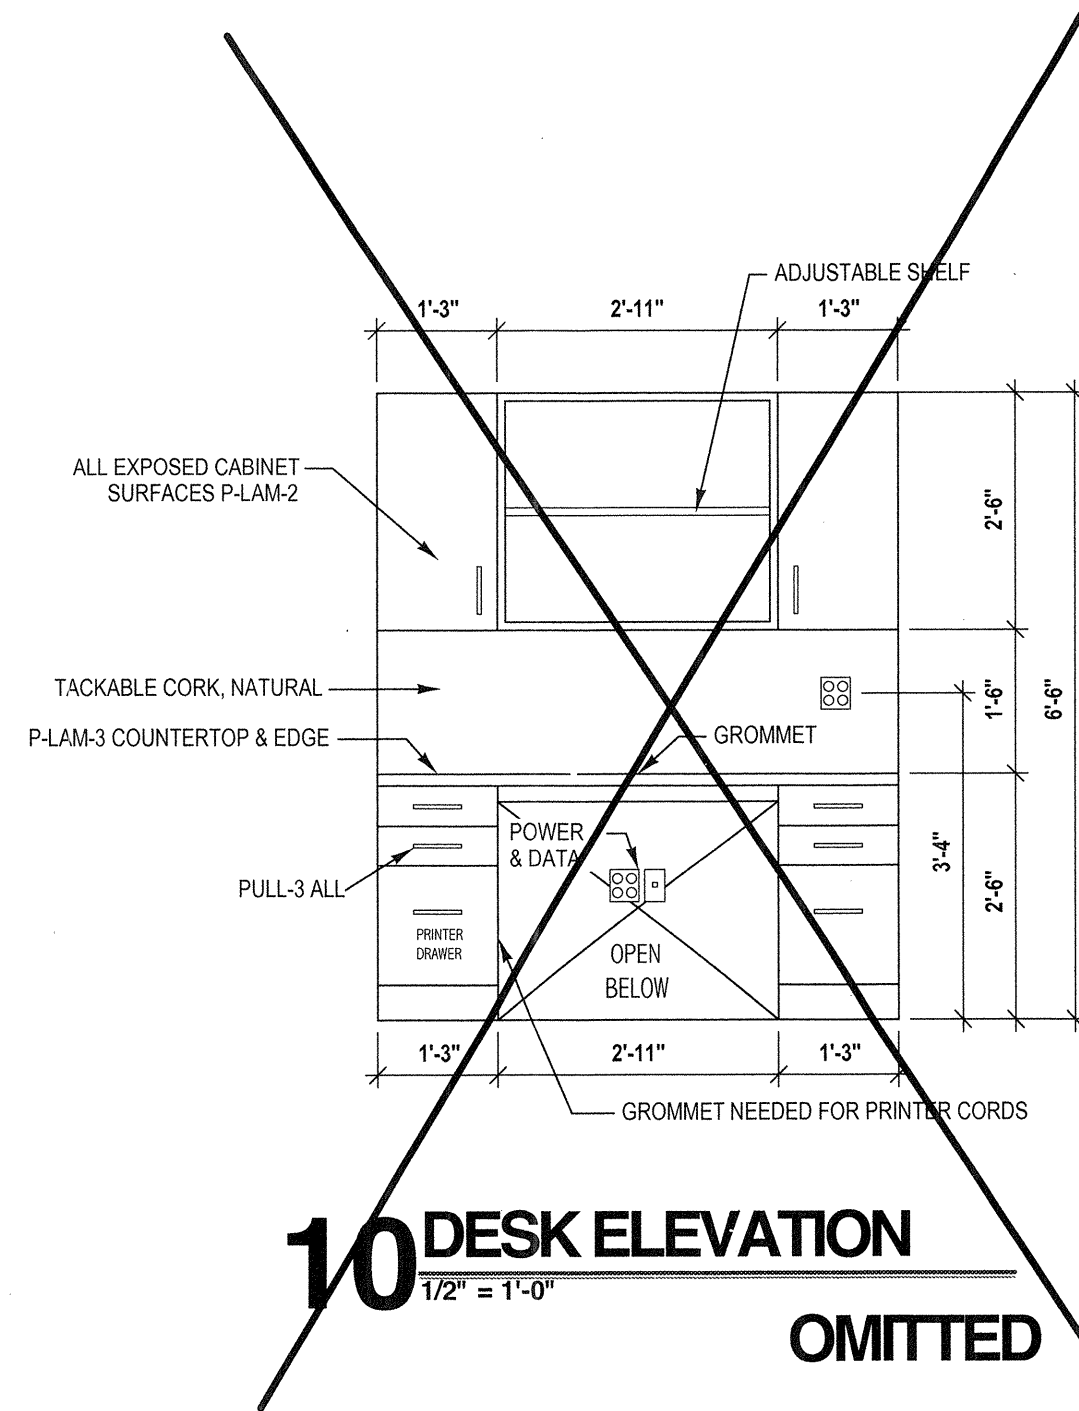
CONWAY, ARKANSAS




12 STOCK SHELVING ELEVATION
1/2" = 1'-0"

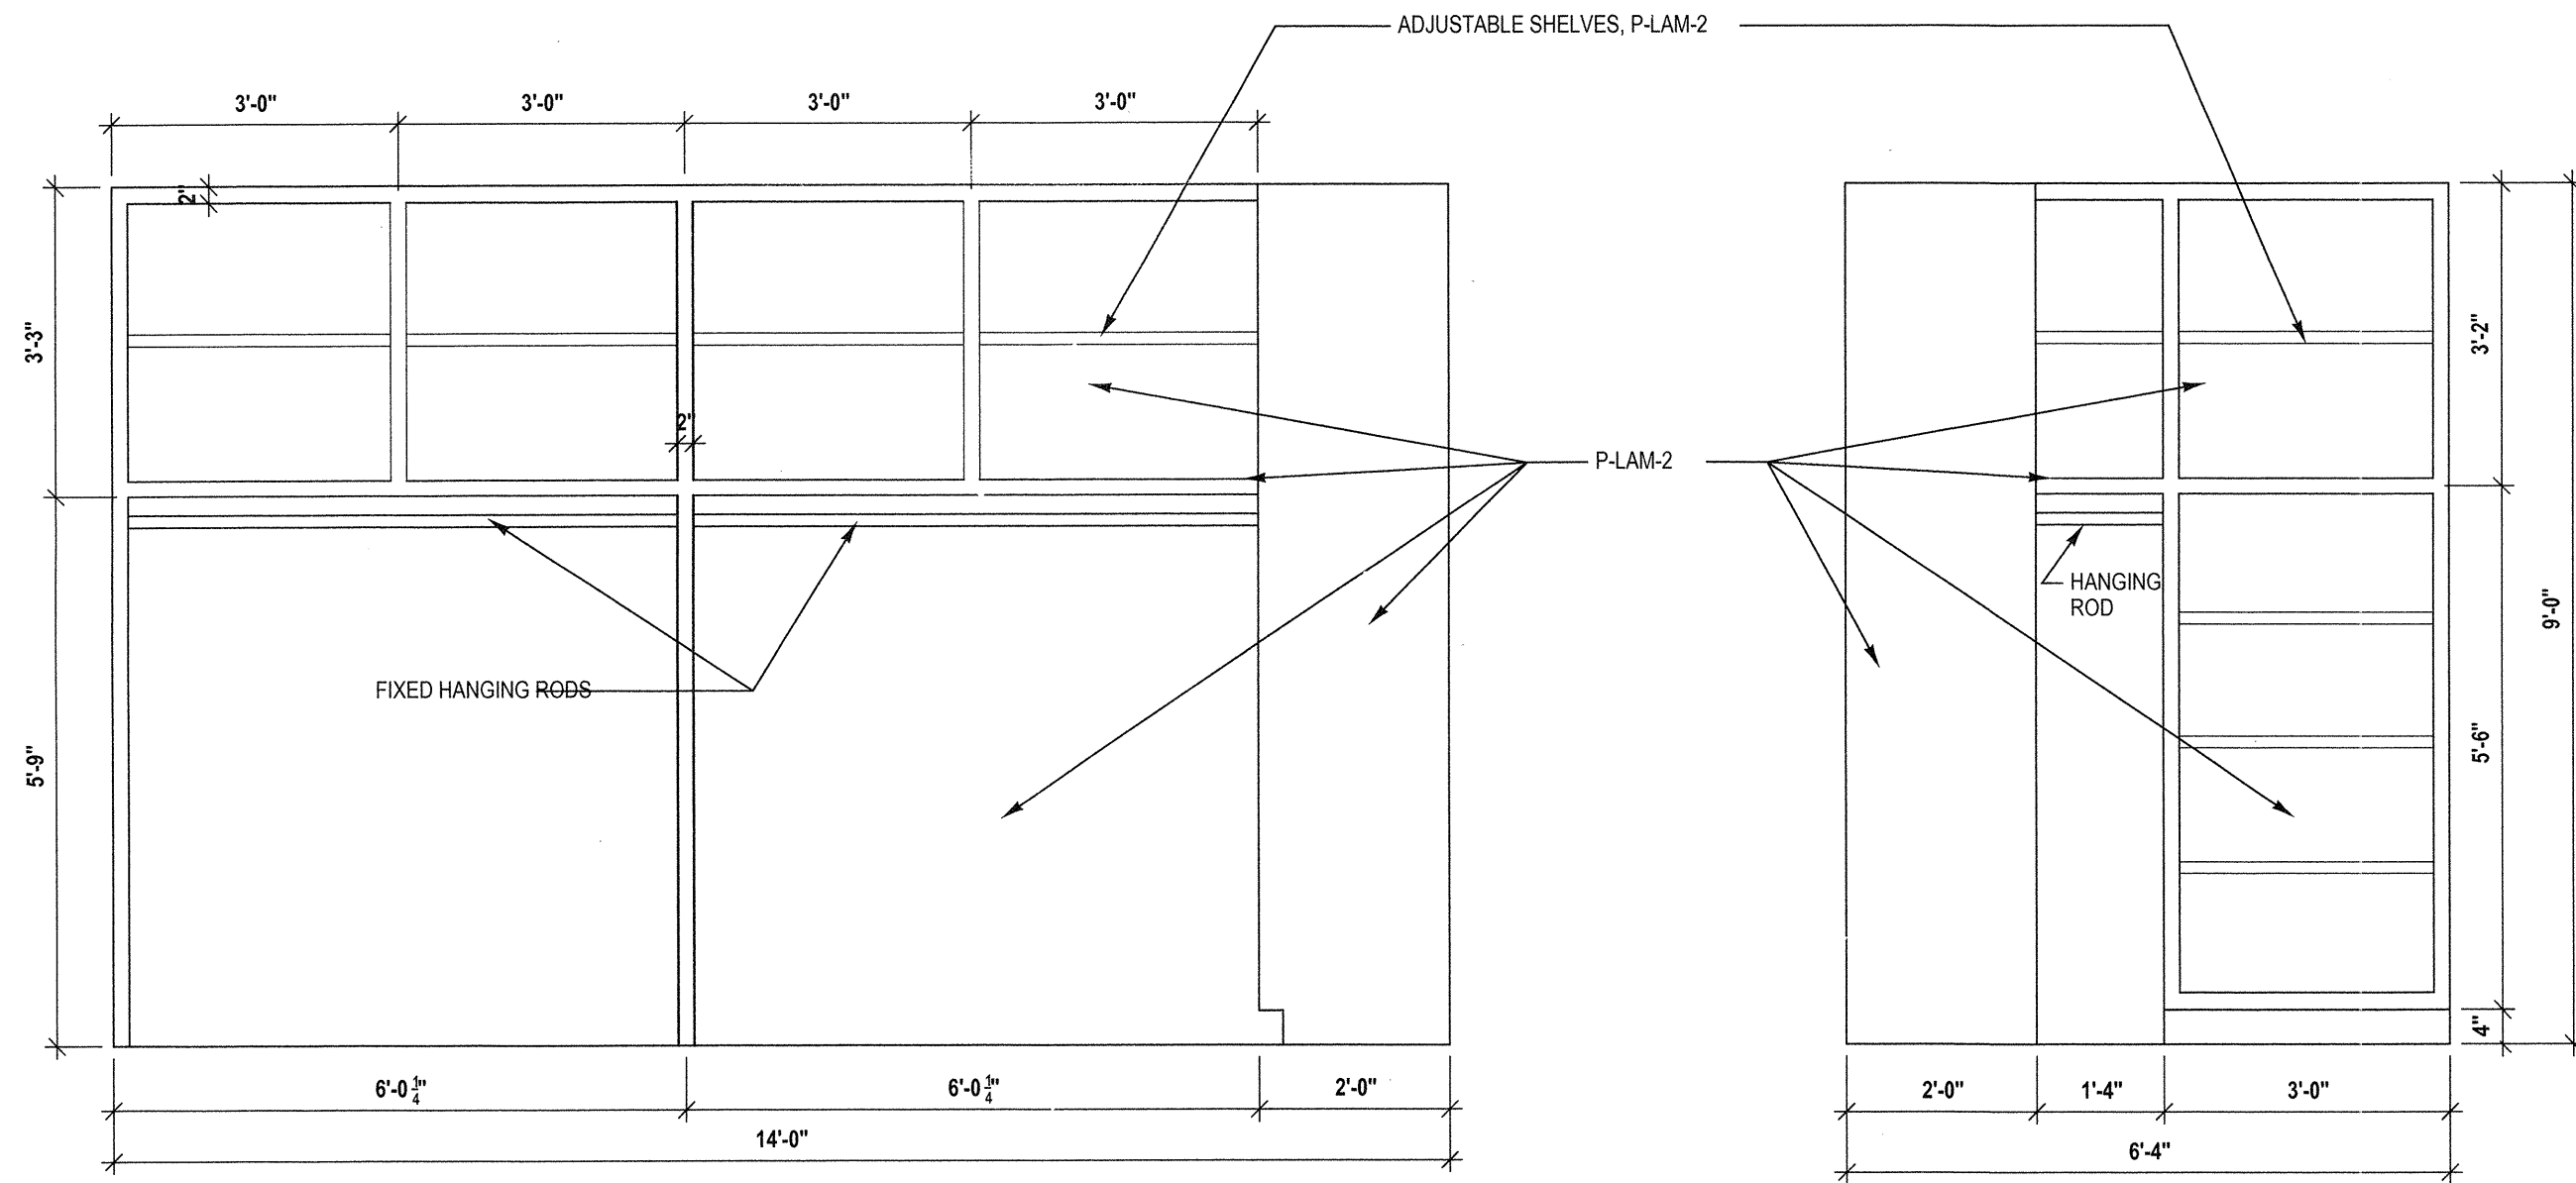


11 STOCK SHELVING ELEVATION
1/2" = 1'-0"




10 DESK ELEVATION
1/2" = 1'-0"
OMITTED

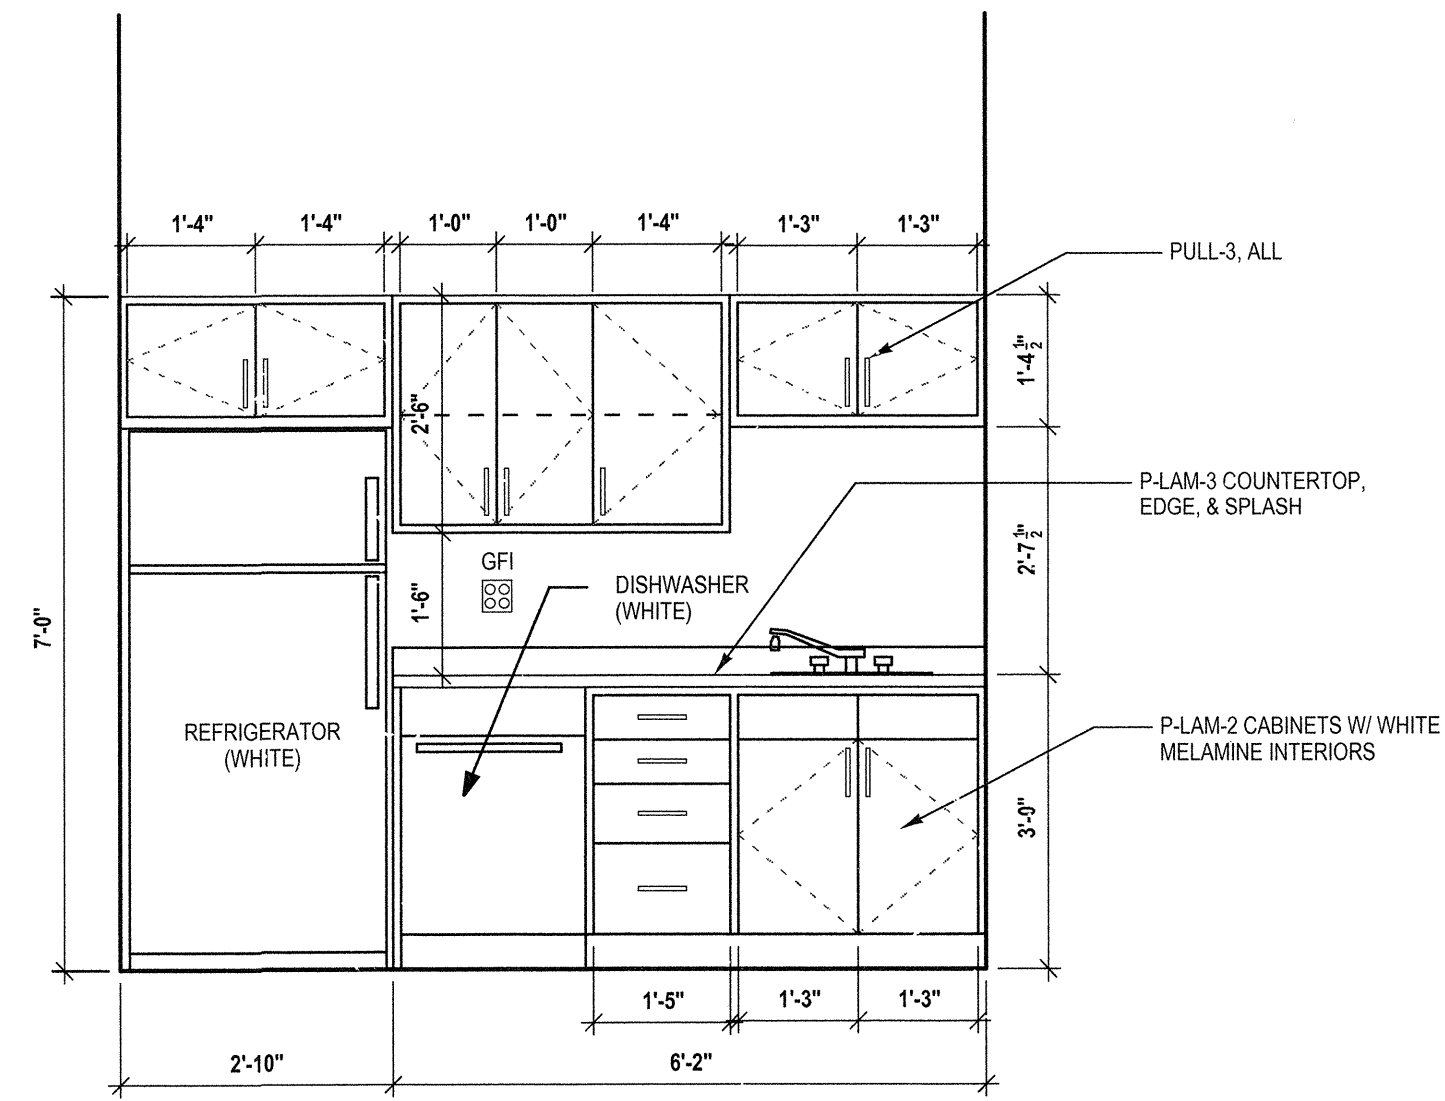


9 KITCHENETTE ELEVATION
1/2" = 1'-0"

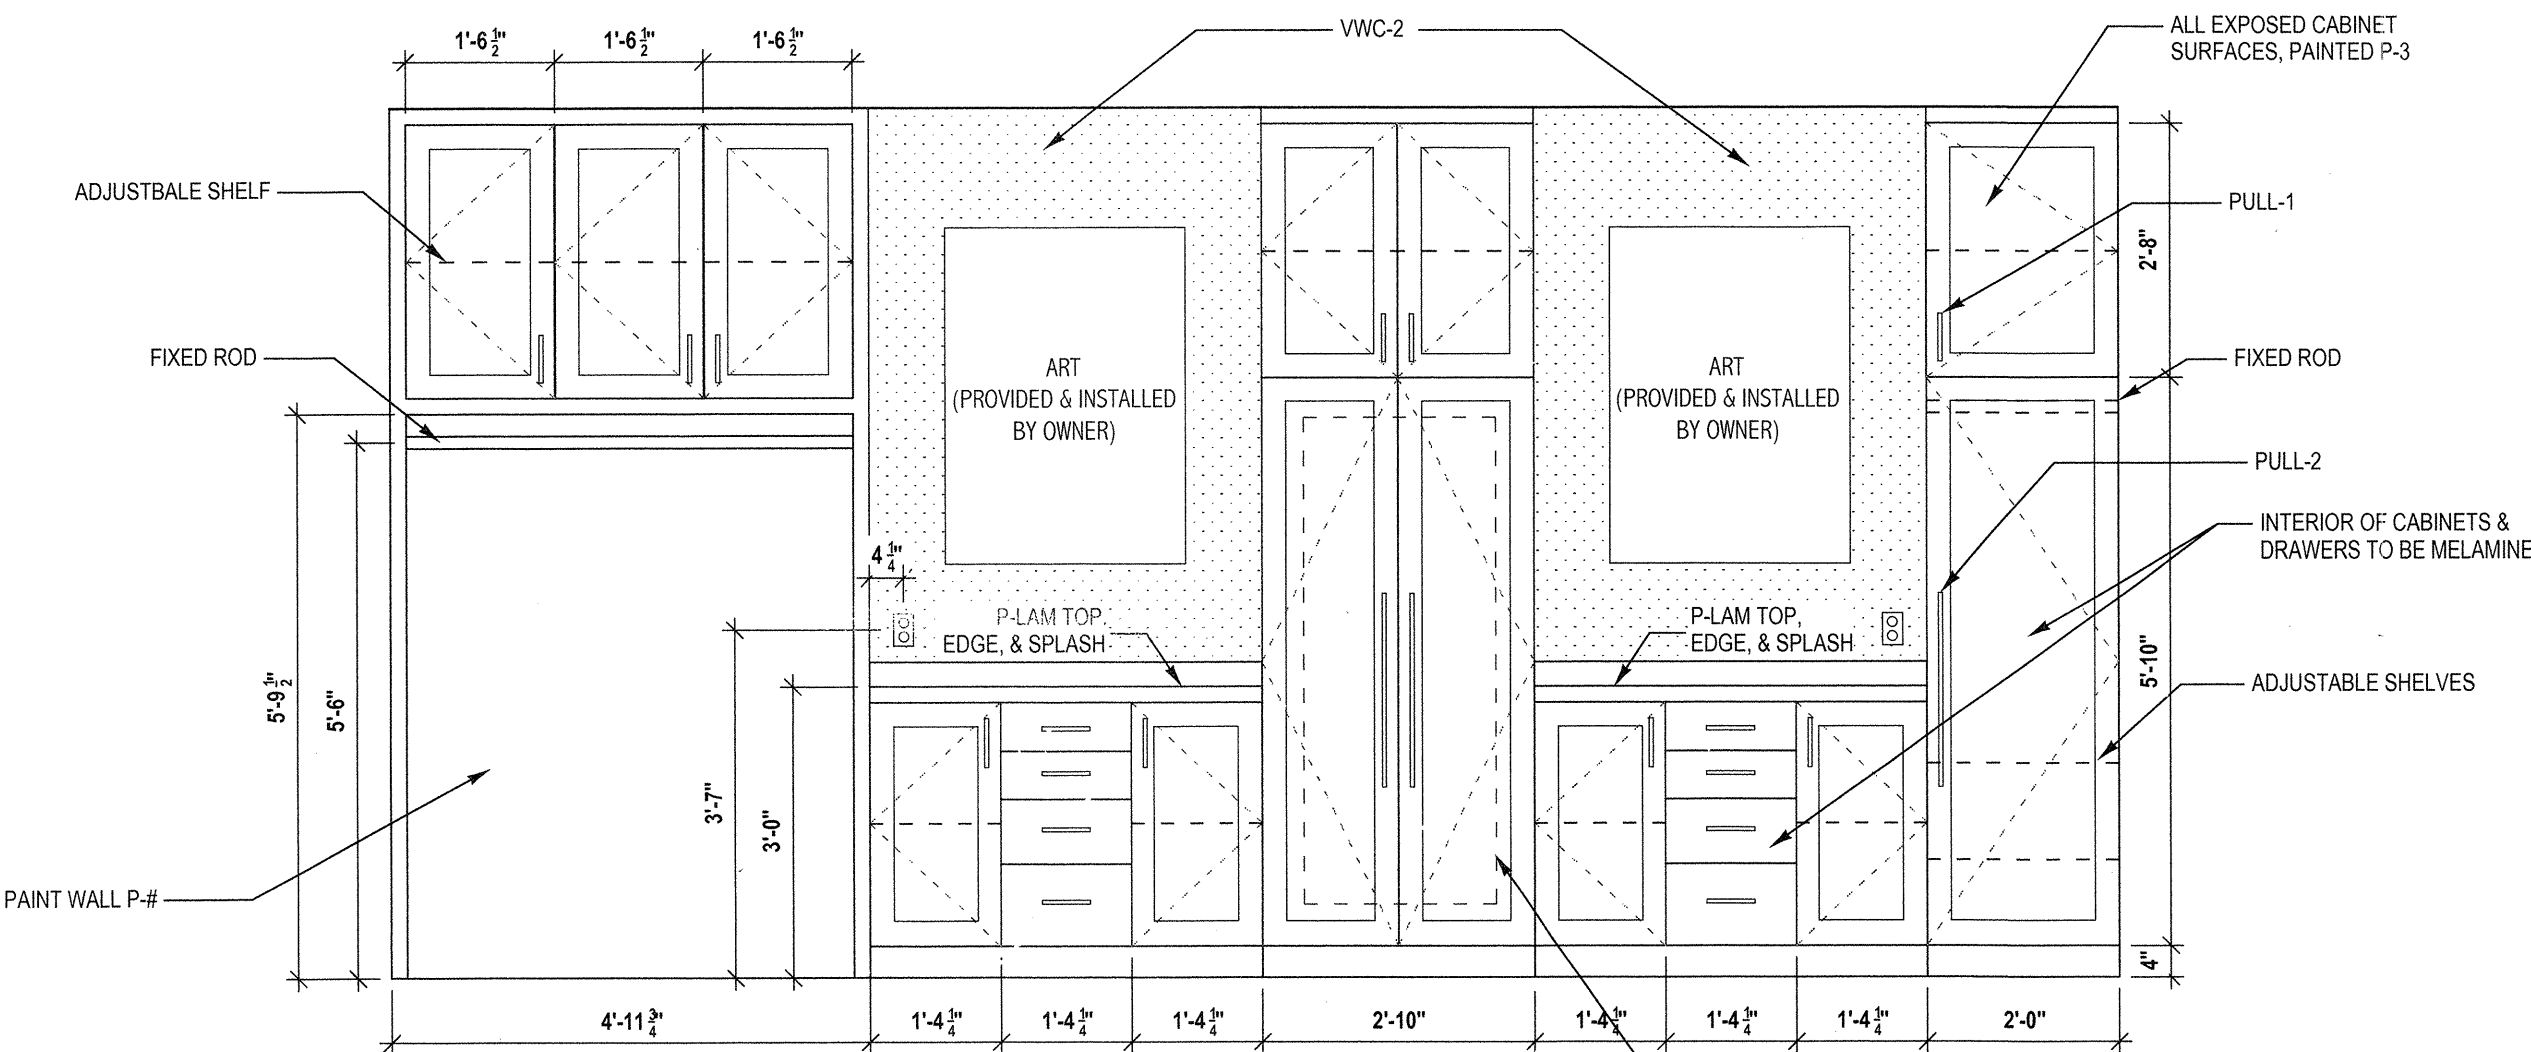


8 CASH WRAP STORAGE WALL ELEVATION
1/2" = 1'-0"

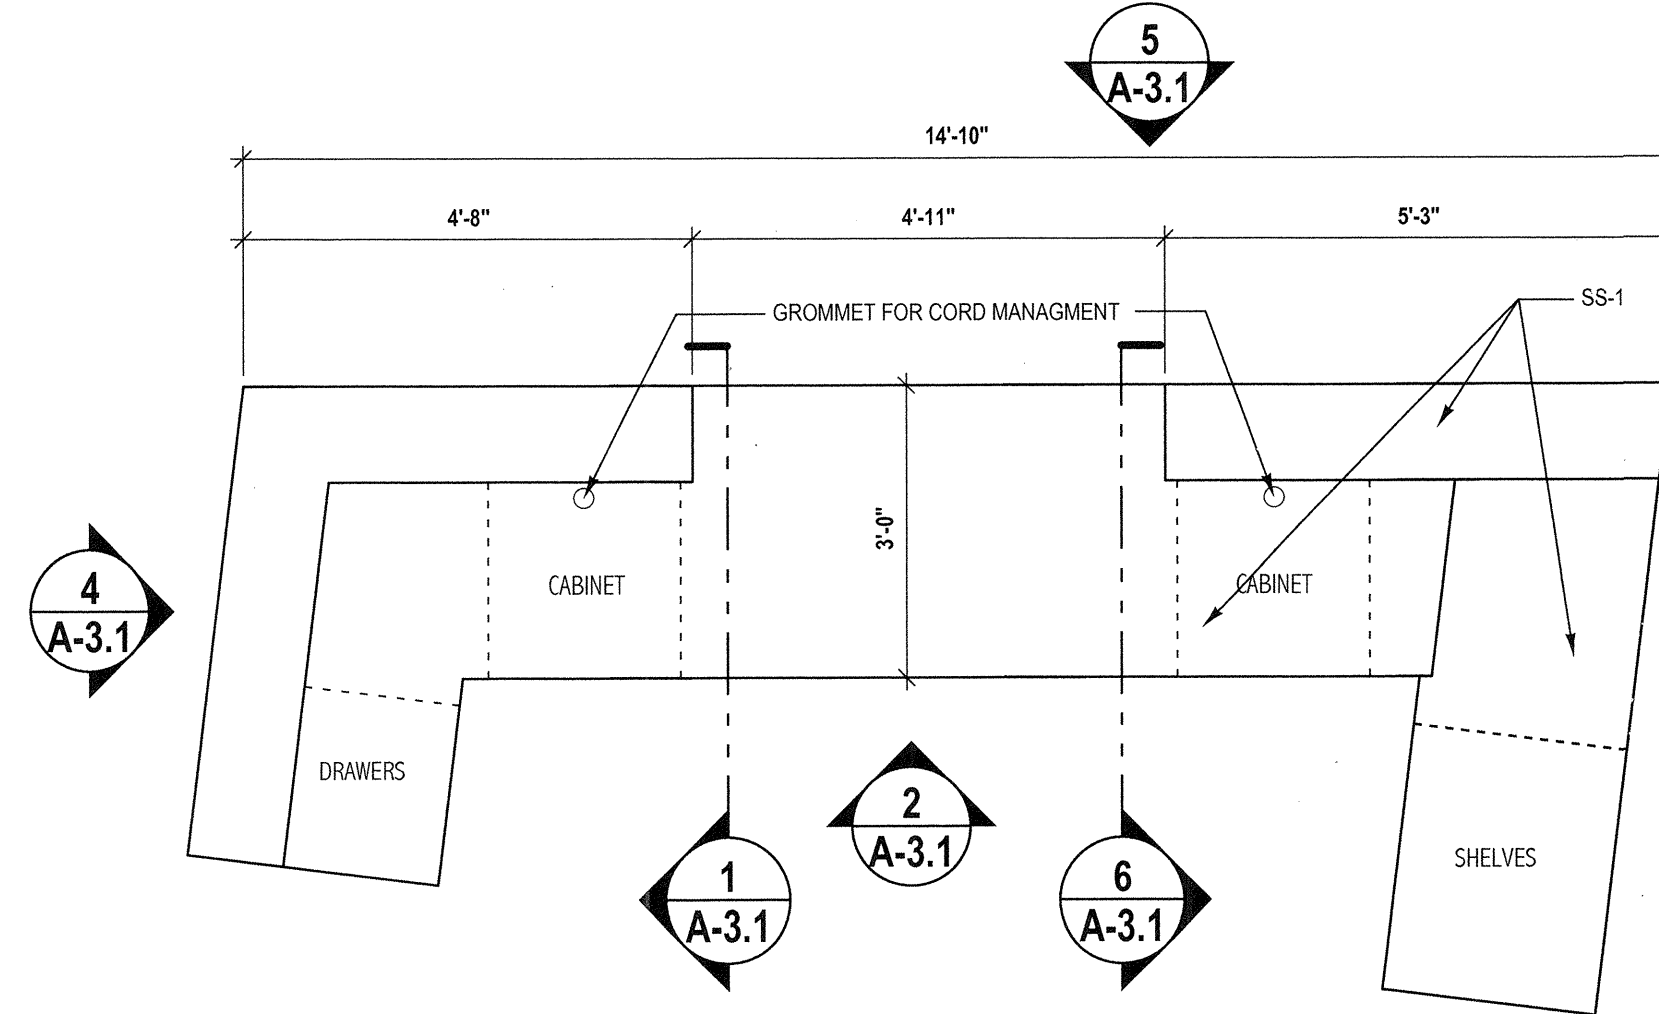


7 CASH WRAP PLAN
1/2" = 1'-0"

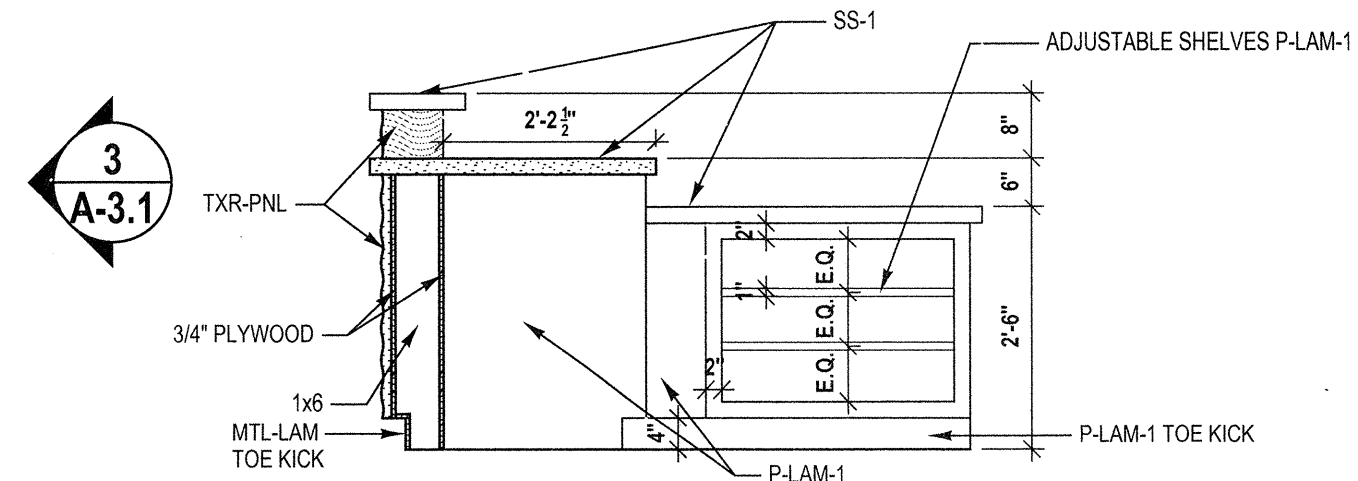


6 CASH WRAP PLAN
1/2" = 1'-0"

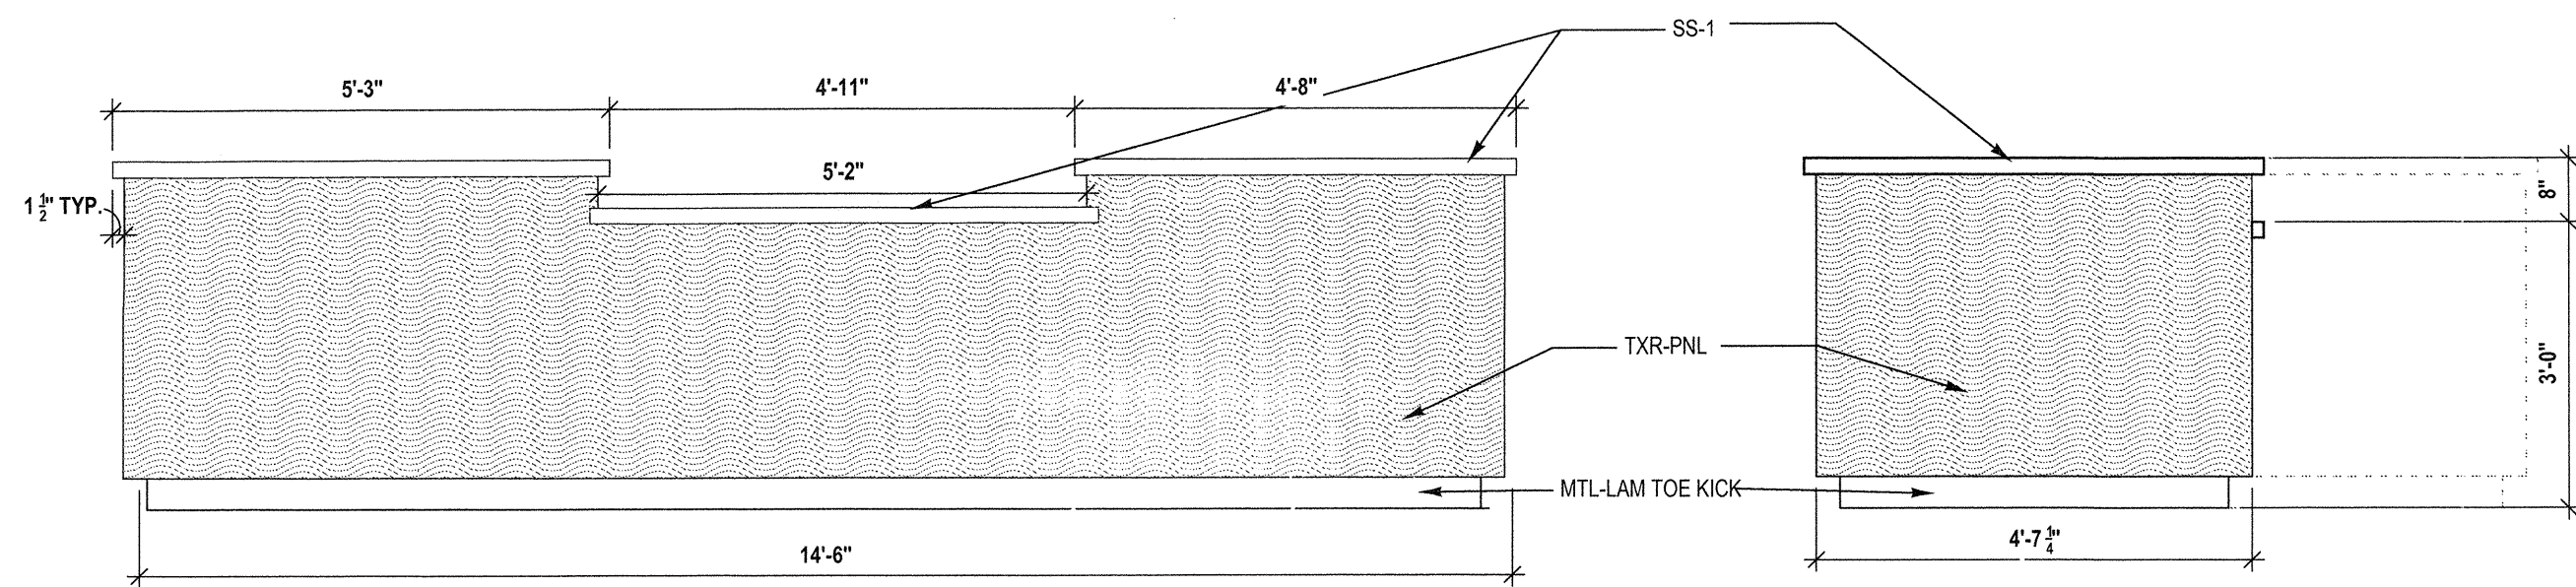


5 CASH WRAP ELEVATION
1/2" = 1'-0"

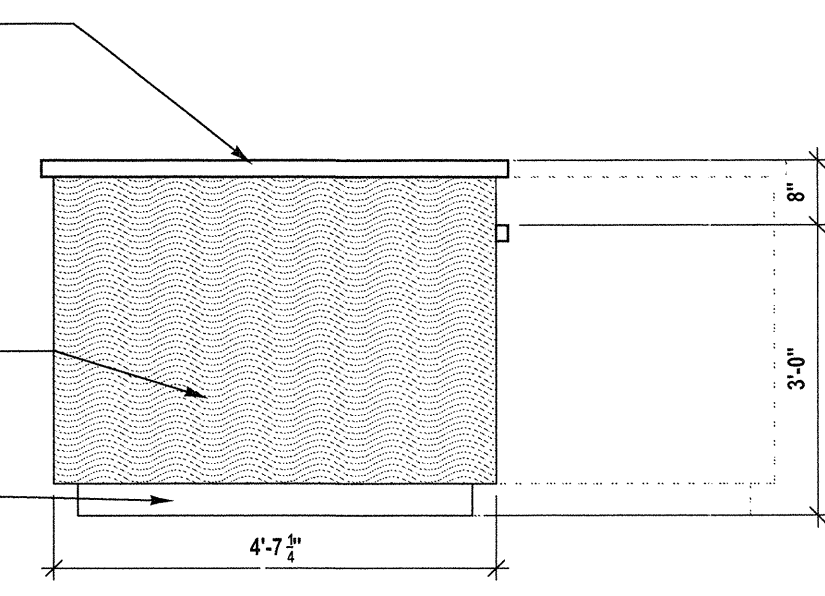


4 CASH WRAP ELEVATION
1/2" = 1'-0"

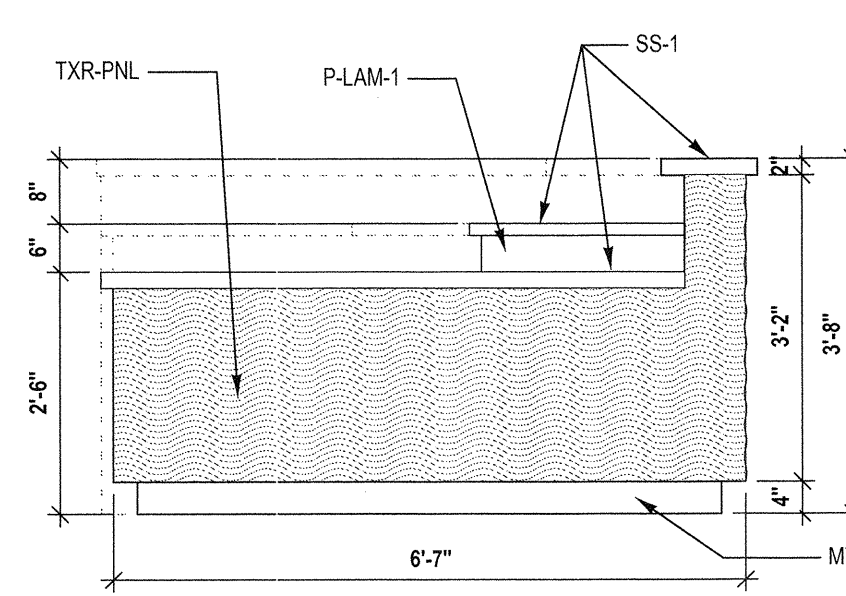

3 CASH WRAP ELEVATION
1/2" = 1'-0"

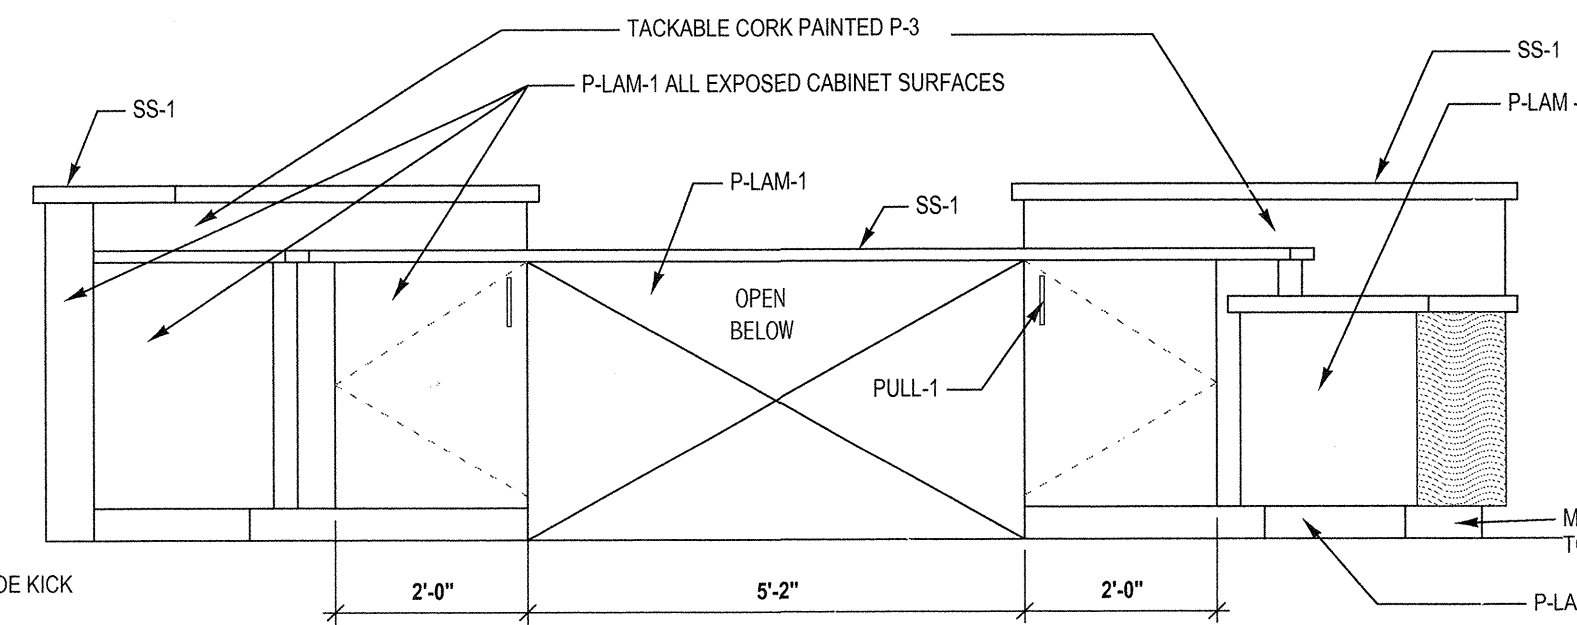

2 CASH WRAP ELEVATION
1/2" = 1'-0"

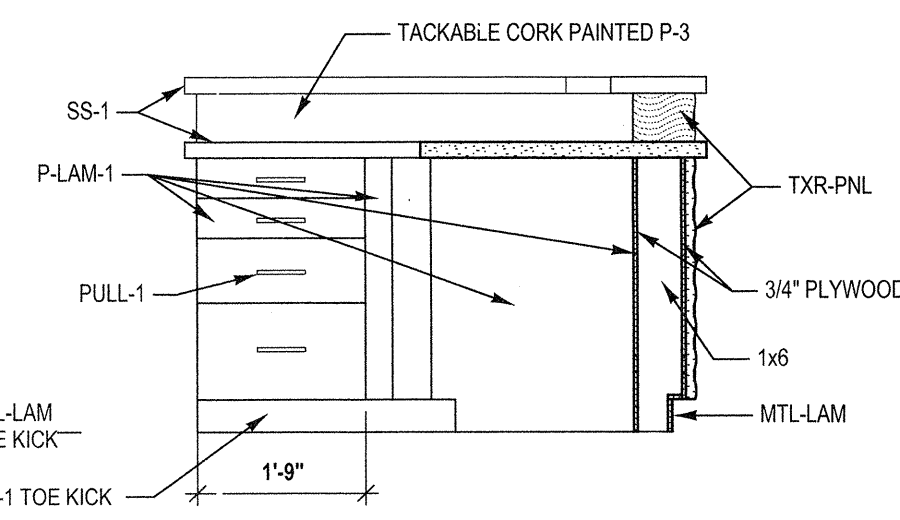

1 CASH WRAP SECTION
1/2" = 1'-0"

MILLWORK

REVISION: 18 SEPT 2012



21 SEPT 2012

12-096

SHEET NUMBER

CONSTRUCTION SET

A-3.1

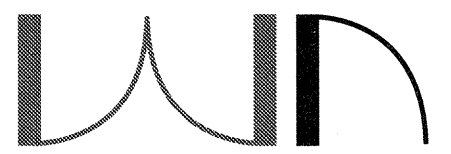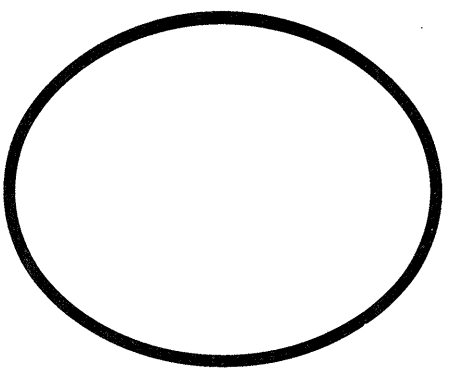

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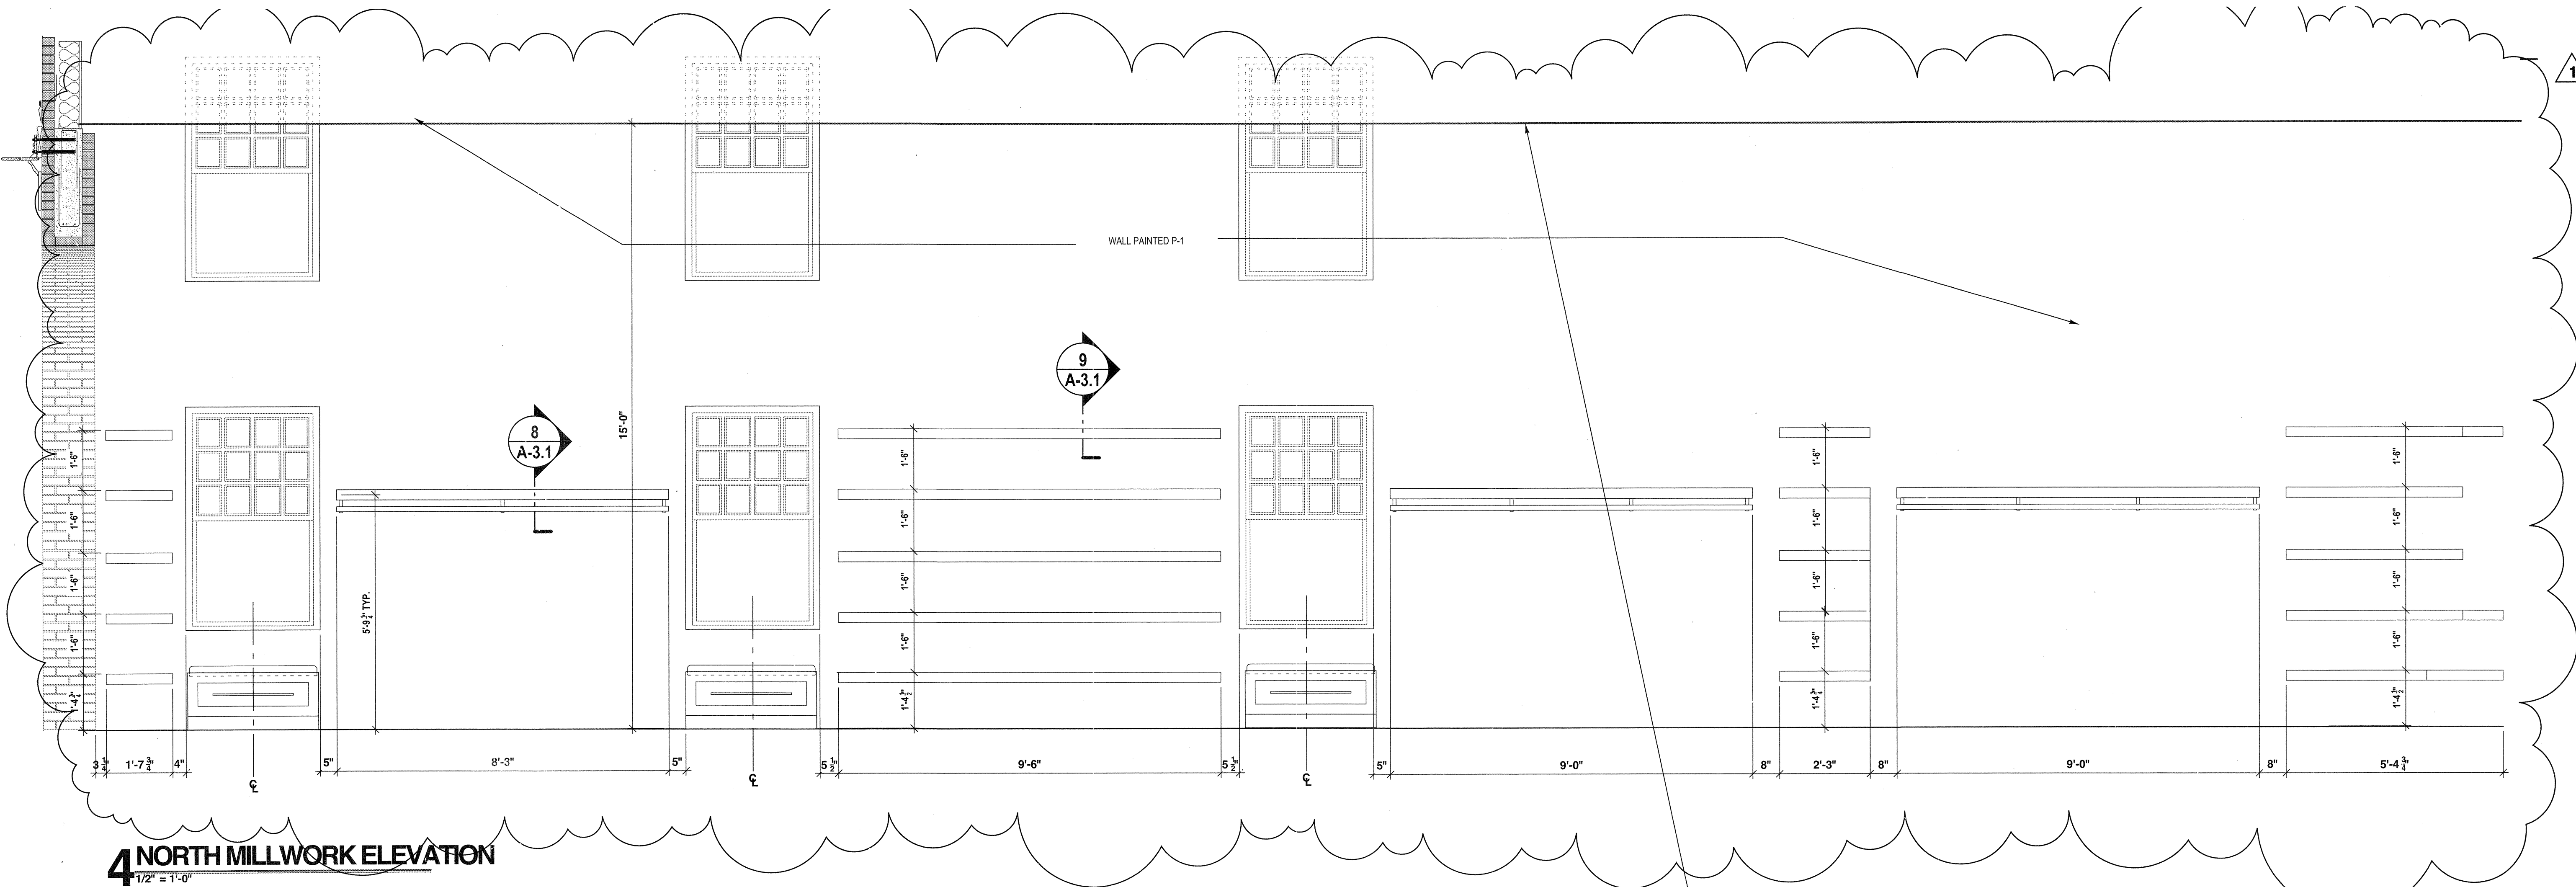
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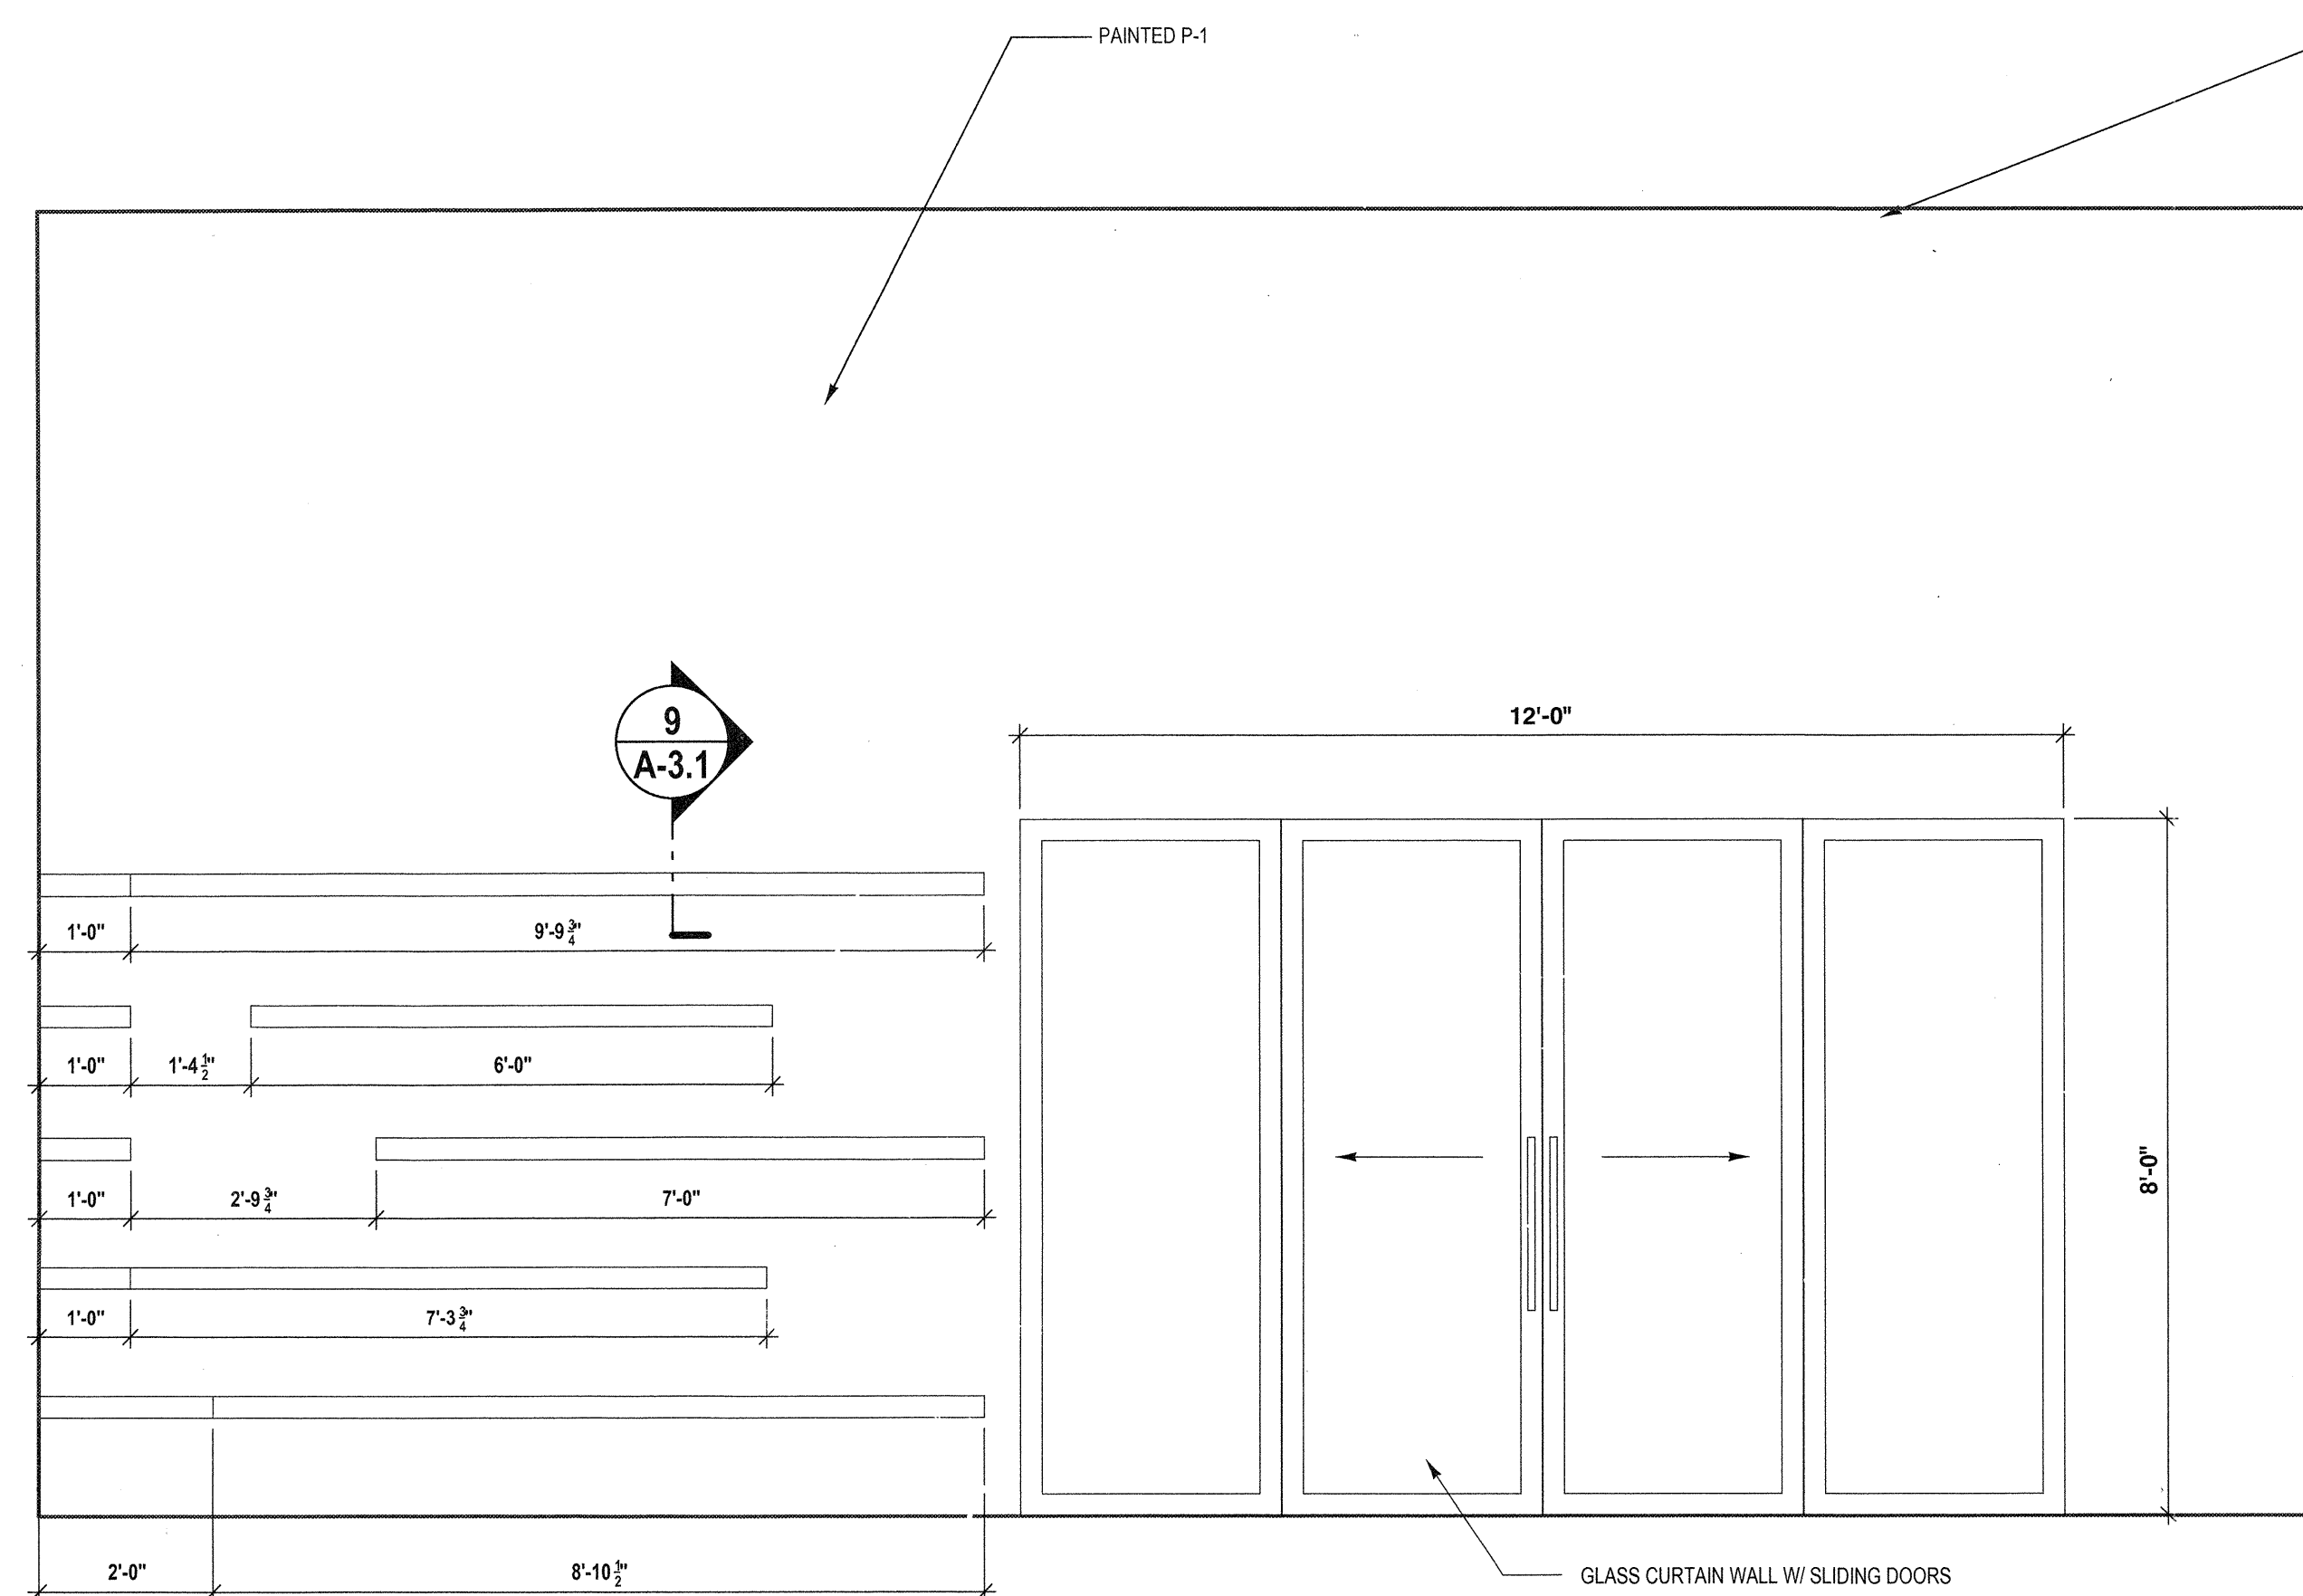
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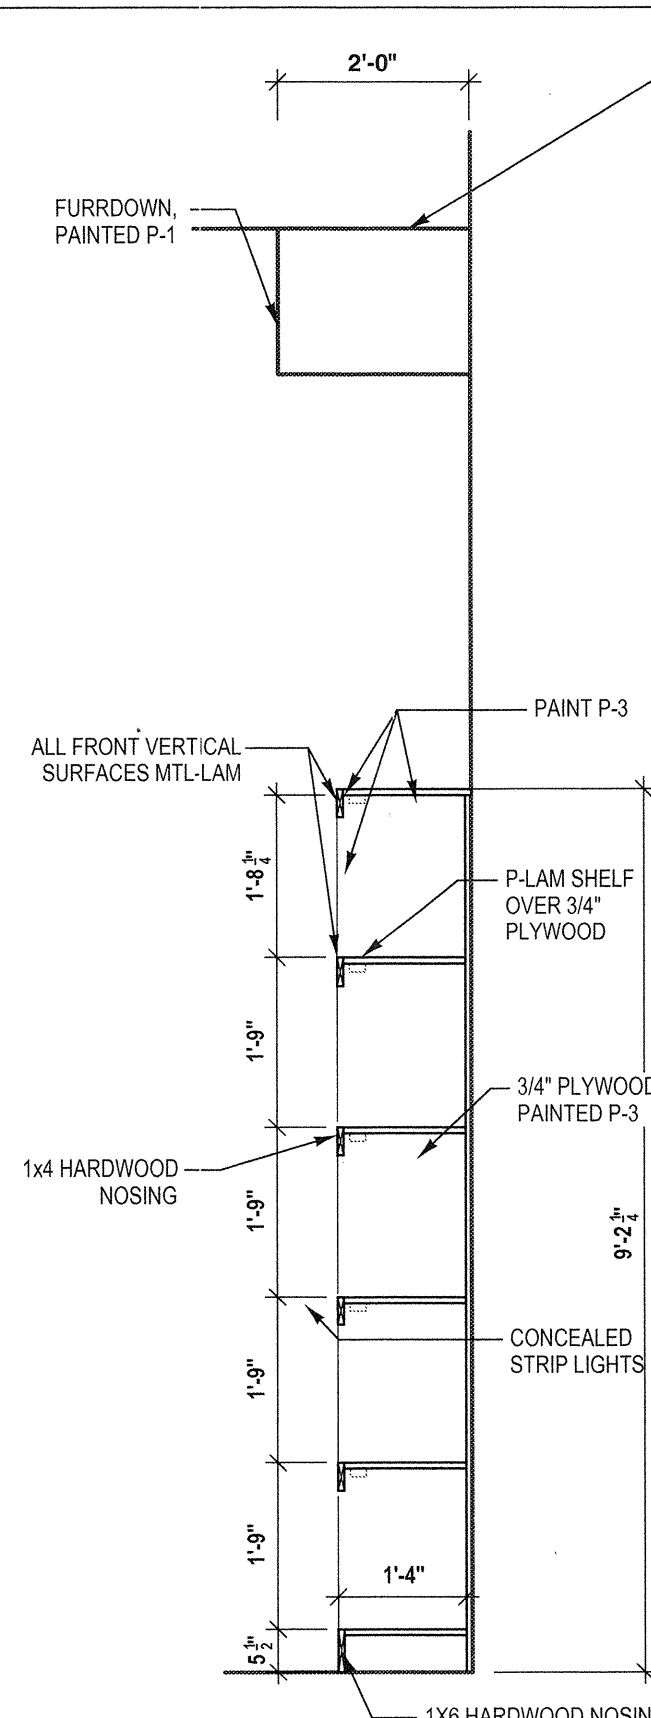
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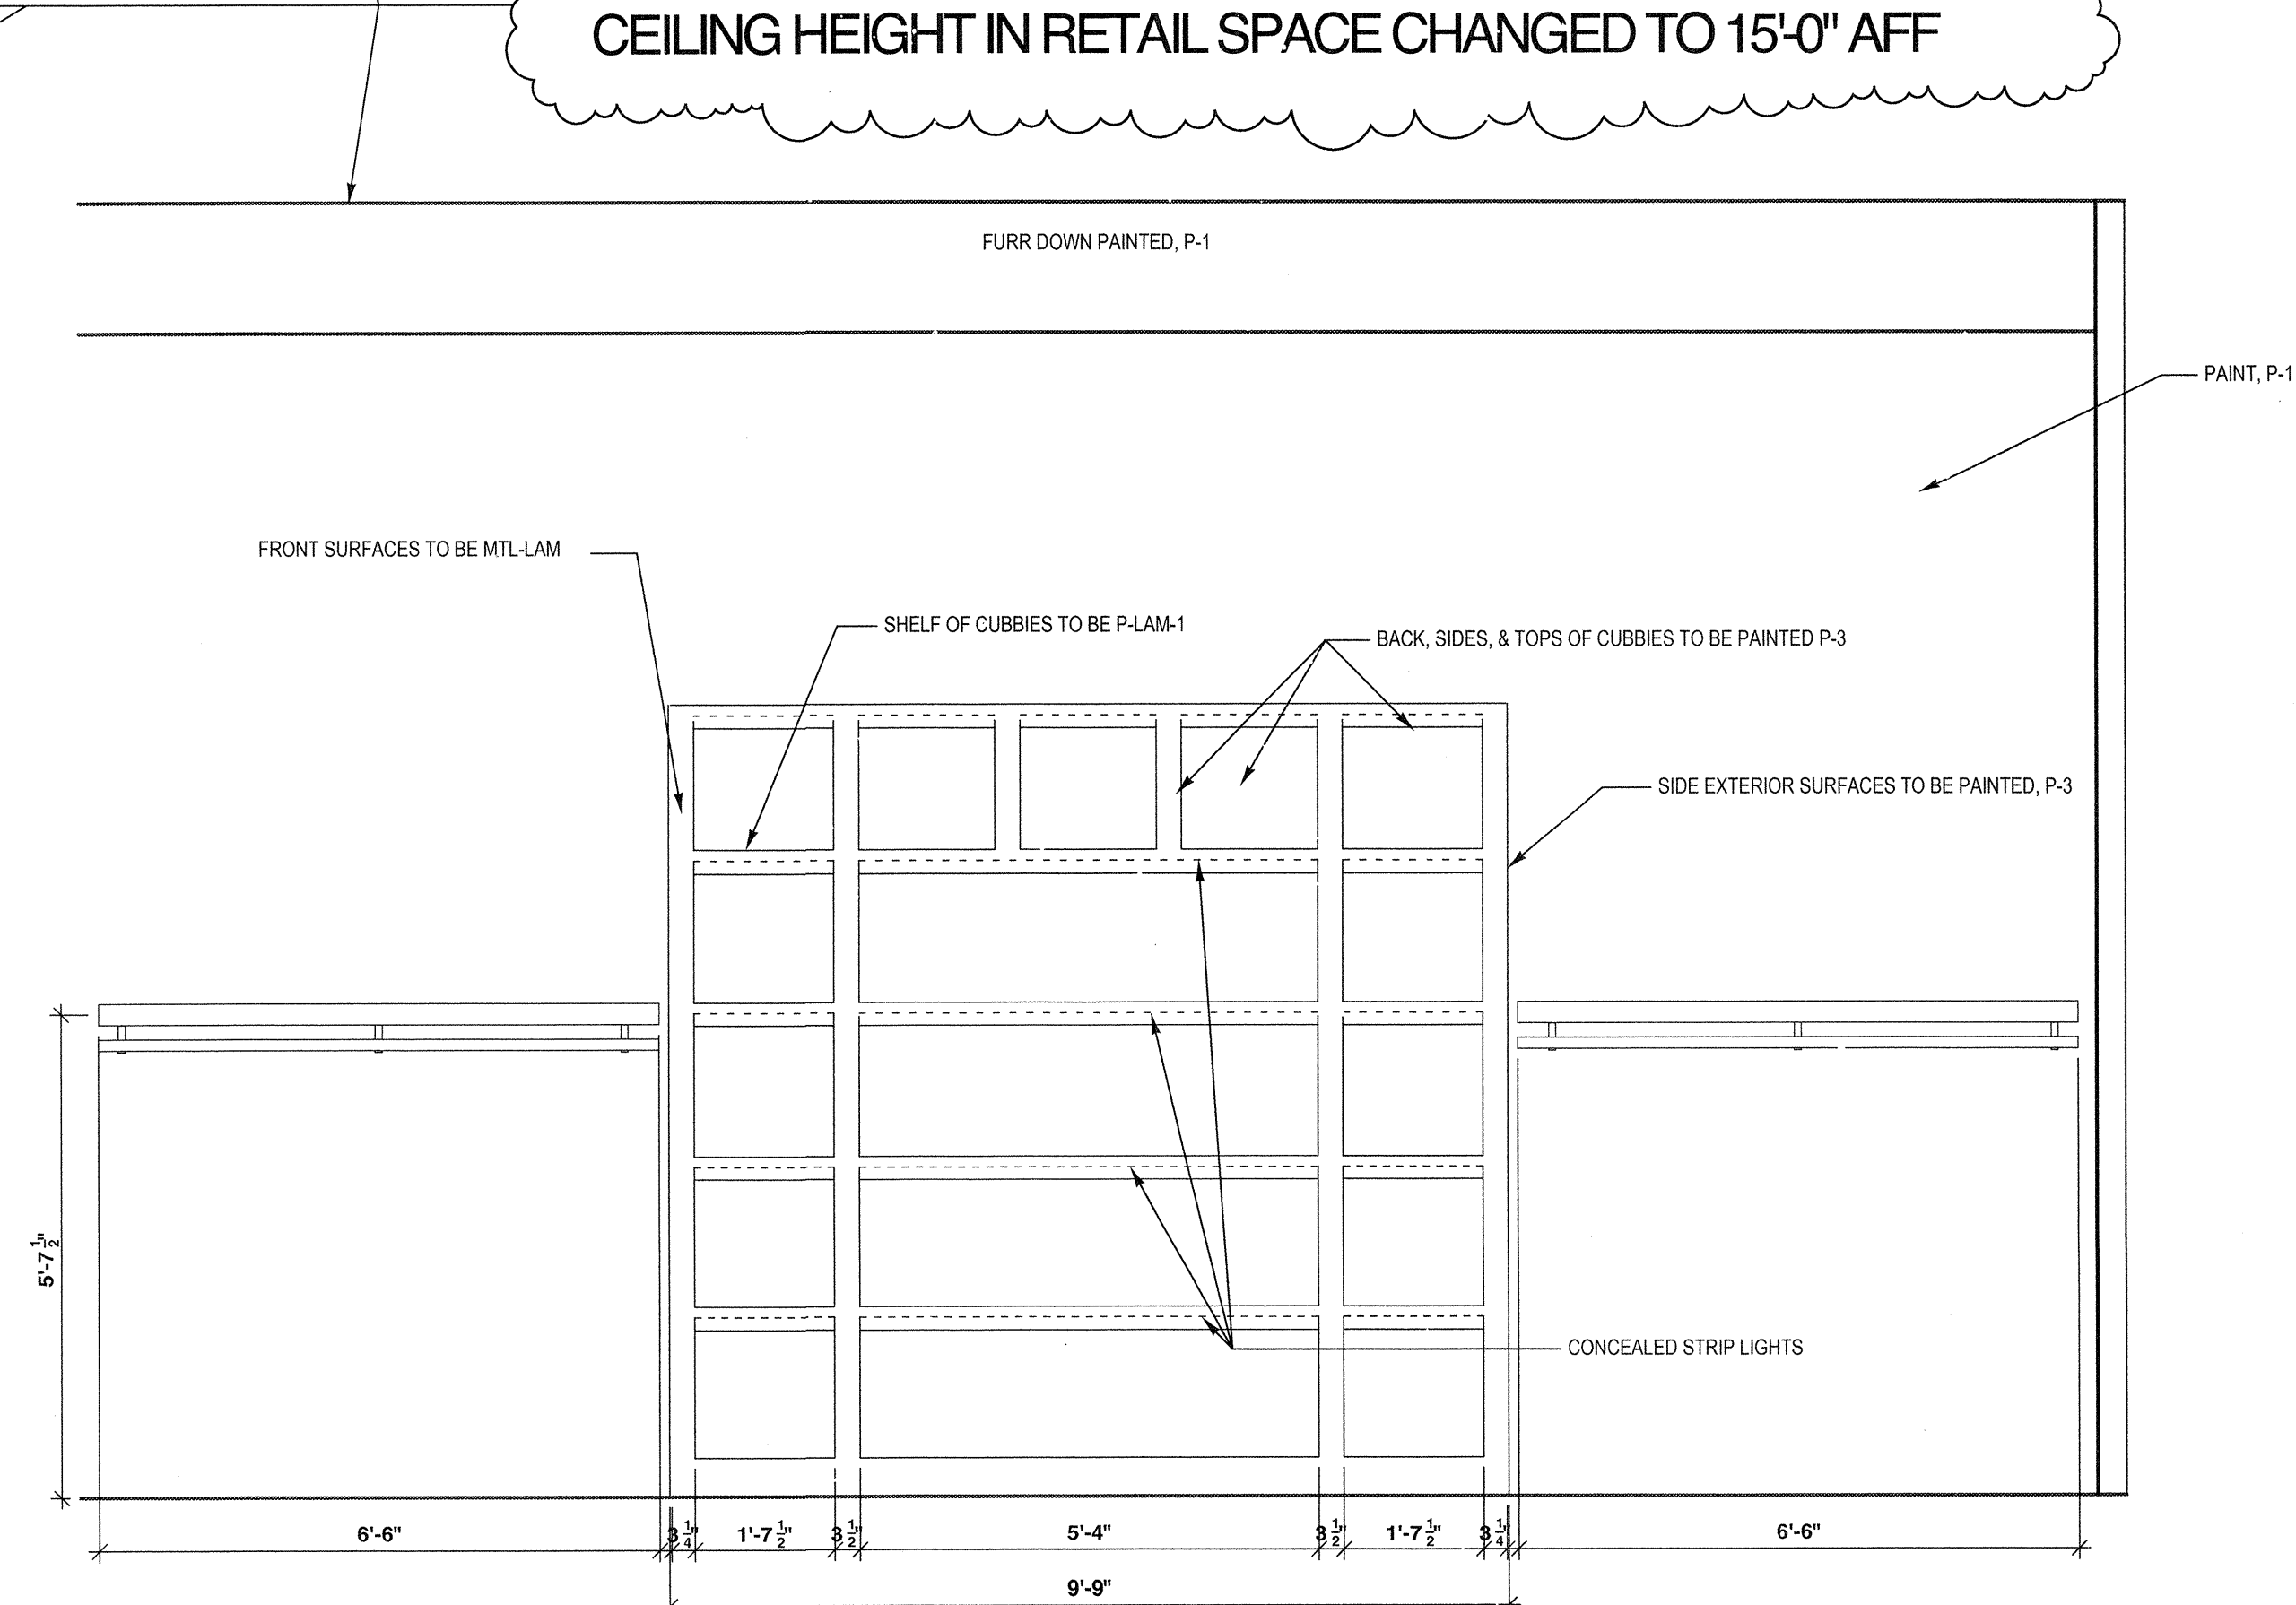
4 NORTH MILLWORK ELEVATION
1/2" = 1'-0"



3 DISPLAY SHELVING ELEVATION
1/2" = 1'-0"



2 SHELVING SECTION
1/2" = 1'-0"



1 DISPLAY SHELVING ELEVATION
1/2" = 1'-0"

CONSTRUCTION SET A-3.2

INTERIOR FINISH SCHEDULE

ROOM NUMBER	ROOM NAME	FLOOR	BASE	WALLS	CEILING	MILLWORK	REMARKS
		STAIN-CONCR P-5 PLATFORM	RB MTL-LAM-BASE	P-1 TYPICAL P-2 ACCENT P-4 TRIM P-3 ACCENT VWC-1 VWC-2 VWC-3 VWC-4 FABRIC-1 FRP WD-CEILING	P-3 ACCENT P-LAM-1 P-LAM-2 P-LAM-3 P-LAM-4 SS-1 SS-2 SS-3 PULL-1 PULL-2 PULL-3 PULL-4 DR-LEVER FABRIC-2		
101	ENTRY						EXISTING CEILING TO REMAIN IN ENTRY
102	SALES FLOOR						
103	CASH WRAP						
104	ADA DRESSING ROOM						
105	DRESSING ROOM						
106	DRESSING ROOM						
107	WOMEN'S RESTROOM						
108	SALON						
109	STOCK & RECEIVING						
110	MEN'S RESTROOM						
111	UTILITY						

MATERIAL SELECTIONS


ITEM	MATERIAL	MANUFACTURER	PATTERN/COLOR	REMARKS	REP. CONTACT
STAIN-CONCR	STAINED AND POLISHED CONCRETE	QC OR EQUAL	PATINA STAIN, BLACKFOOT	WITH JOINTS AS INDICATED ON THE PLAN	
MTL-LAM-BASE	METAL LAMINATE BASE		METAL LAMINATE TO BE MTL-LAM	MTL-LAM OVER 1x6, (EXPOSED SURFACES TO BE MTL-LAM)	
RB	RUBBER BASE	ROPPE	TBD BY ARCHITECT		
P-1 TYPICAL	TYPICAL WALL PAINT - LATEX - EGGSHELL	BENJAMIN MOORE	WINTER WHITE, OC-21		
P-2 ACCENT	WALL PAINT - LATEX - EGGSHELL	BENJAMIN MOORE	WILLOW CREEK 1468		
P-3 MILLWORK	MILLWORK PAINT - OIL - SEMI-GLOSS	BENJAMIN MOORE	EDGE-COMB GRAY, HC-173		
P-4 TRIM	TRIM PAINT - OIL - SEMI-GLOSS	BENJAMIN MOORE	BLACK HORIZON, 2132-30	INTERIOR WINDOW TRIM, DOOR CASINGS, & DOORS	
P-5 CEILING	CEILING PAINT - LATEX - FLAT	BENJAMIN MOORE	WINTER WHITE, OC-21		
P-6 PLATFORM	PLATFORM PAINT - LATEX - SEMI-GLOSS	BENJAMIN MOORE	TO MATCH FINISHED STAINED/POLISHED CONCRETE	T.B.D. BY ARCHITECT	
P-7 WALL	TYPICAL WALL PAINT - LATEX - PEARL FINISH	BENJAMIN MOORE	WINTER WHITE, OC-21		
P-8 ACCENT	TYPICAL WALL PAINT - LATEX - PEARL FINISH	BENJAMIN MOORE	EDGE-COMB GRAY, HC-173		
VWC-1	VINYL WALLCOVERING	NATIONAL WALLCOVERING	VYCON, RIVULET Y46561RU		KANDID SCOTT, 501.319.3310
VWC-2	VINYL WALLCOVERING	EYKON	LUMINOUS 2VLU-02		KATHY MCFALL, 901.550.2026
VWC-3	VINYL WALLCOVERING	NATIONAL WALLCOVERING	VYCON, JARDIN Y46360JA		KANDID SCOTT, 501.319.3310
VWC-4	VINYL WALLCOVERING	NATIONAL WALLCOVERING	COMMAND, KARMA CM77-8804 CHARCOAL		KANDID SCOTT, 501.319.3310
WD-CEILING	WOOD VENEER CEILING	SAFOT	QC, ZEBRAWOOD, CUSTOM STAIN, #090712	CONTACT ARCHITECT FOR APPROVAL BEFORE ORDERING	KANDID SCOTT, 501.319.3310
P-LAM-1	PLASTIC LAMINATE DISPLAY SHELF, SHELF SURFACE	FORMICA	NEUTRAL WEFT, S875-58		KATE DUNNAVANT, 501.258.5347
P-LAM-2	PLASTIC LAMINATE CABINET FRONT	WILSONART	STEEL MESH 4879-38		AMBER BURLEY, 501.256.9022
P-LAM-3	PLASTIC LAMINATE WORK SURFACE, SPLASH & EDGE	WILSONART	CRISP LINEN 4942-38		AMBER BURLEY, 501.256.9022
P-LAM-4	PLASTIC LAMINATE CABINET FRONT	WILSONART	ASTRO STRANDZ 4940K-18		AMBER BURLEY, 501.256.9022
MTL-LAM	METAL LAMINATE	WILSONART	ALUMASTEEL ALUMINUM		AMBER BURLEY, 501.256.9022
TXR-PNL	3D TEXTURE PANEL	SOELBERG	NUOTARE, WHITE HG OR PORTUNA LIGHT	FINAL COLOR TBD BY ARCHITECT	TOM JOHNSON, 501.950.7994
SS-1	SOLID SURFACE TOP, EDGE & SPLASH	CAESARSTONE	4120 RAVEN	POLISHED FINISH, 2" THICK EDGE, EASED EDGE	VALLERY WREN, 901.652.4911
SS-2	SOLID SURFACE TOP, EDGE & SPLASH	HANSTONE	ULTRA VIOLET, CW104	POLISHED FINISH, 2" THICK EDGE, EASED EDGE	KELLEY ADAMS, 350-8406
SS-3	SOLID SURFACE TOP, EDGE & SPLASH	CORIAN	GLACIER WHITE	POLISHED FINISH, EASED EDGE	MITCH WEIR, 901.361.0038
FABRIC-1	DRAPERY PANELS	ROBERT ALLEN CONTRACT	GLAZED LINEN CHARCOAL	ALLOW LABOR BUDGET OF \$350 FOR ALL PANELS. APPROVE BEFORE ORDERING.	
FABRIC-2	UPHOLSTERY FABRIC FOR BENCH	TBD BY ARCHITECT	TBD BY ARCHITECT	ALLOW BUDGET OF \$50/YD FOR MATERIALS	
HANG-RD	HANGING RODS	B&N INDUSTRIES	PICK SYSTEM, FINAL SELECTIONS TBD BY ARCHITECT	ALLOW BUDGET OF \$3,500 FOR MATERIALS. DOES NOT INCLUDE ANY SHELVEING	KERITH HELLAND, (800) 350-4127
SHELF-BRACKET	BRACKET FOR FLOATING SHELVES	B&N INDUSTRIES	PICK SYSTEM, FINAL SELECTIONS TBD BY ARCHITECT	ALLOW BUDGET OF \$2,500 FOR MATERIALS. DOES NOT INCLUDE ANY SHELVEING	KERITH HELLAND, (800) 350-4127
MIRROR-1	DRESSING ROOM MIRROR		PLATE GLASS MIRROR, WALL TO WALL, BASE TO CEILING	SEE PLAN FOR LOCATIONS	
MIRROR-2	FRAMED MIRROR	TBD BY ARCHITECT	TBD BY ARCHITECT	ALLOW BUDGET OF \$480, SEE PLAN FOR LOCATIONS	
MIRROR-3	FRAMED MIRROR- RESTROOM	TBD BY ARCHITECT	TBD BY ARCHITECT	ALLOW BUDGET OF \$275	
MIRROR-4	FRAMED MIRROR- RESTROOM	TBD BY ARCHITECT	TBD BY ARCHITECT	ALLOW BUDGET OF \$150	
FAUCET-1	SINK FAUCET	DELTA	VERO, TWO HANDLE, WIDE SPREAD, MODEL #3553LF-SS	CONTACT ARCHITECT FOR APPROVAL BEFORE ORDERING	WHITNEY LAMMERS, 501.690.3663
FAUCET-2	SINK FAUCET	GLACIER BAY	TCOMBA, 4 IN CENTERSET, HIGH-ARC, BRUSHED NICKEL, MODEL #51A1061BNV	CONTACT ARCHITECT FOR APPROVAL BEFORE ORDERING	HOME DEPOT, WWW.UMBRA.COM
ROD	BRUSHED NICKEL ROD	UMBRA	UMBRA, CAPPRA ROD, 36"-72", BRUSHED NICKEL	INSTALL ON INSIDE OF DRESSING ROOM	
FRP	FIBER GLASS REINFORCED PANEL		WHITE	INSTALL ON WALLS, WIDTH OF SINK	
PULL-1	CABINET BAR PULL	LIBERTY	6-27IN STEEL BAR PULL MODEL #1117058.0		HOME DEPOT
PULL-2	CABINET BAR PULL	LIBERTY	25-15IN FLAT END BAR PULL, MODEL #75761.0		HOME DEPOT
PULL-3	CABINET BAR PULL	LIBERTY	3-3/4" WIDE PLAZA PULL, MODEL #52571.0		HOME DEPOT
PULL-4	CABINET SQUARE PULL	TOPEX HARDWARE	SQUARE PULL WITH HOLE, SATIN NICKEL, MODEL #8-107105434		
PULL-5	FRONT DOOR BAR PULL	ASSA ABLOY ROCKWOOD	NOIR MET, RM3812 91-114", US32D		WENDELL POORE, 501-786-7901
PULL-6	SALON DOOR BAR PULLS	ASSA ABLOY ROCKWOOD	NOIR MET, RM500 (12" CTC), US32D		WENDELL POORE, 501-786-7901
DR-LEVER	DOOR LEVER	ASSA ABLOY EMTEK	STUTTGART LEVER, STAINLESS STEEL W/ BRUSHED STAINLESS STEEL SQUARE ROSETTE, US32D		WENDELL POORE, 501-786-7901
DR-STOP	DOOR STOP	ASSA ABLOY ROCKWOOD	RM850, US32D	USE WHERE DOOR STOPS ARE NEEDED	WENDELL POORE, 501-786-7901
ROD-BRACKET	HANGING ROD BRACKET	UMBRA	MICHAEL IVANKOVIC, 1" CEILING MOUNT BRACKET, NICKEL		WWW.UMBRA.COM
GROMMET	SATIN ALUMINUM GROMMET				

TYPICAL NOTES:

- CONTRACTOR TO SUBMIT SAMPLES OF ALL SELECTED MATERIALS FOR ARCHITECT'S FINAL APPROVAL PRIOR TO ORDERING.
- CONTRACTOR TO FIELD VERIFY ALL EXISTING CONDITIONS 34. PAINT RETURN AIR VENTS TO MATCH ADJOINING WALL / CEILING COLOR.
- DOOR HARDWARE, PLUMBING FIXTURES AND LIGHTING FIXTURES TO BE SATIN NICKEL FINISH.
- PROVIDE PROTECTIVE, TINTED FILM AT WINDOWS.
- SWITCH PLATES & OUTLET COVERS FINISHES TO BE SELECTED BY ARCHITECT.
- LAVATORY FINISHES TO BE SELECTED BY ARCHITECT.
- INSTALL ALL MATERIALS PER MANUFACTURER'S SPECIFICATIONS AND INSTALLATION GUIDELINES.
- SUBFLOOR TO BE CLEANED OF EXISTING ADHESIVE BEFORE INSTALLING SHEET VINYL.
- SUBFLOOR - CONFIRM ABSENCE OF MOISTURE, RUN CALCIUM CHLORIDE TEST.
- VERIFY W/ PAINT MANUFACTURER FOR CORRECT TINT / SHADE OF PRIMER TO ACHIEVE TRUE COLOR VALUE OF SPECIFIED PAINT.

MILLWORK NOTES:

- ALL P-LAM MILLWORK TO BE FULL OVERLAY PLASTIC-LAMINATE COVERED. COLOR NOTED ON INTERIOR ELEVATIONS AND MILLWORK SECTIONS.
- MDF BOARD / MELAMINE IS AN ACCEPTABLE MILLWORK SUBSTRATE.
- MDF FOR FRAME AND BODY OF CABINET, MELAMINE FOR DRAWERS, ETC.
- DRAWERS AND CABINET BACKINGS TO BE WHITE MELAMINE.
- ALL HINGES AT DOORS TO BE CONCEALED. HAFELE OR EQUAL.
- DRAWER AND DOOR PULLS TO AS INDICATED IN THE FINISH SCHEDULE
- FILE DRAWERS (F) TO HAVE RAILS FOR HANGING FILES.

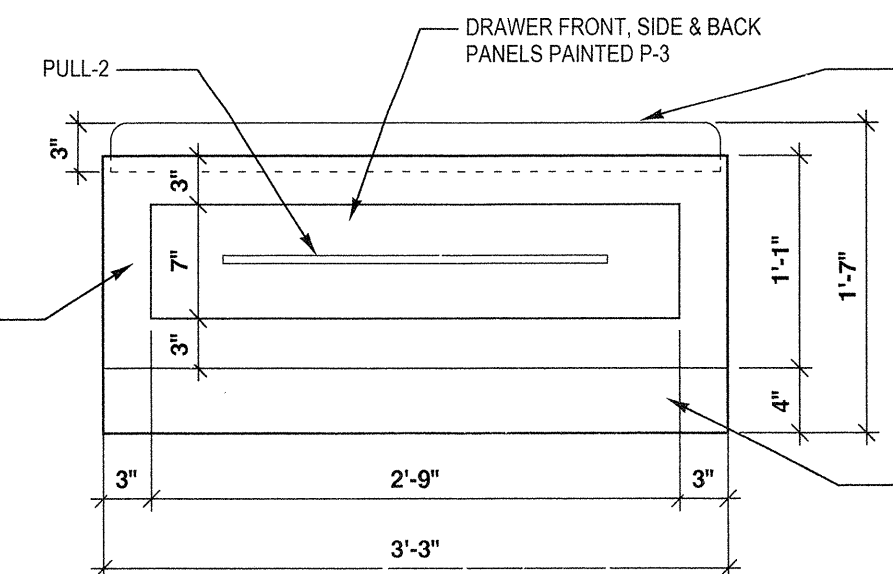

4 BENCH W/ DRAWER
1" = 1'-0"


QUANTITY 3

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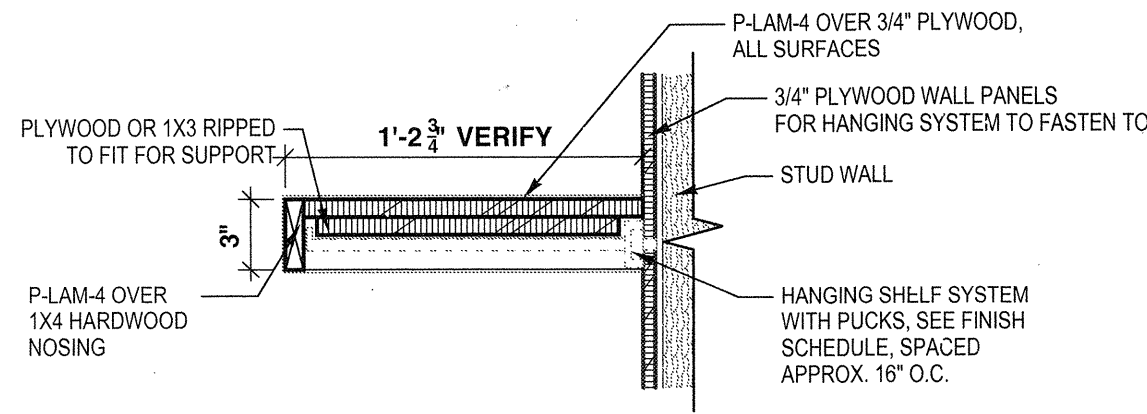
BUDGET ALLOWANCES

TYPICAL NOTES:

- ALLOWANCE NUMBERS TO INCLUDE: SALES TAX, OVERAGE AND FREIGHT. ALLOWANCE DOES NOT INCLUDE LABOR OR PROFIT.

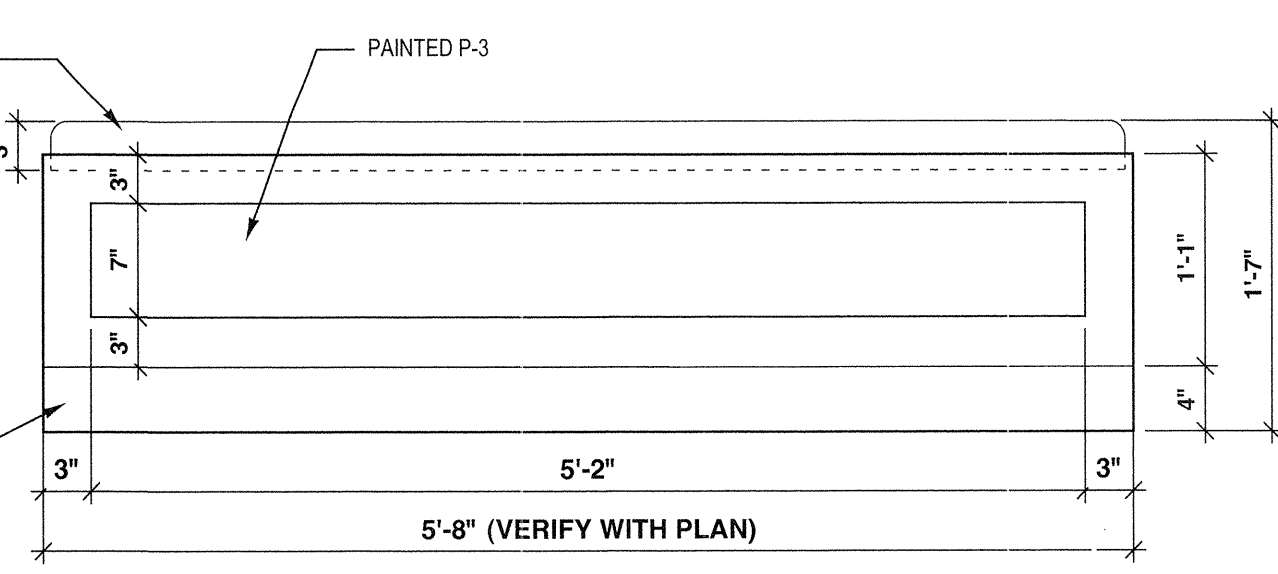


3 ADA DRESSING ROOM BENCH
1" = 1'-0"



OPTION REMOVABLE SHELF SECTION
FLOATING SHELF- OPTION 2
1'-1/2" = 1'-0"

NOTE: HANGING PUCKS MUST BE INSTALLED PRIOR TO HANGING PLYWOOD WALLS & WALL FINISHING

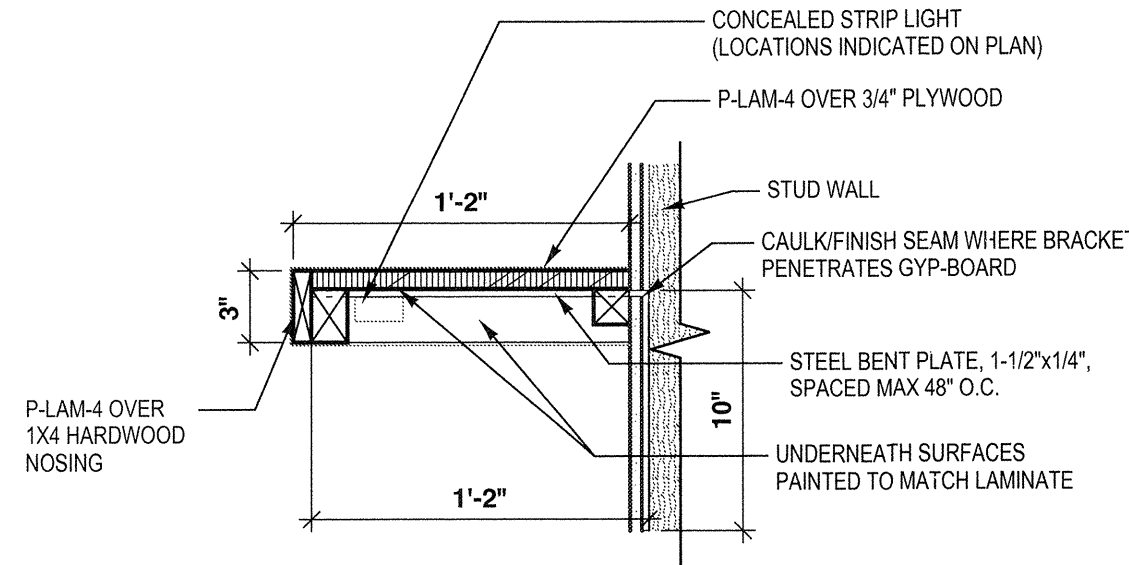

FLOATING SHELF SECTION
OPTION 1
1'-1/2" = 1'-0"

4" SOLID SURFACE BACKSPLASH BEHIND SINK & SIDE WALLS, 4" ABOVE DW. SEE ELEVATION


3/4" PLYWOOD TOP W/ 1X2 NOSING, SOLID SURFACE TOP AND EASED EDGE, ELEVATION

STATIONARY 3/4" PLYWOOD FRONT PLASTIC LAMINATE APRON


3/4" PLYWOOD FRONT; PLASTIC LAMINATE FRONT, REMOVABLE PANEL TO CONCEAL P-TRAP; & DISPOSAL SEE ELEVATION

3/4" PLYWOOD BOTTOM: PLASTIC LAMINATE TO MATCH W/ 1X2 FRAME

1X4 BLOCKING BASE W/ PLASTIC LAMINATE

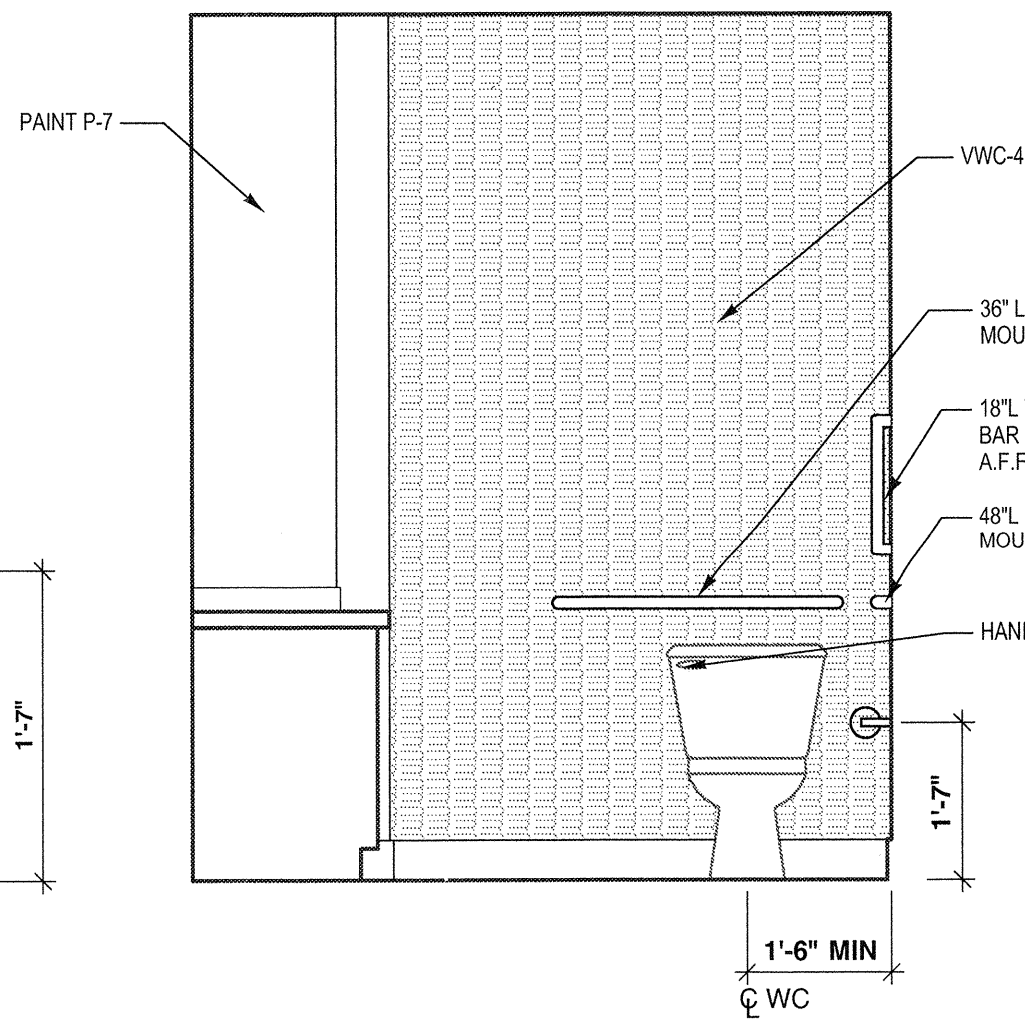


2 RESTROOM WEST ELEVATION
1/2" = 1'-0"

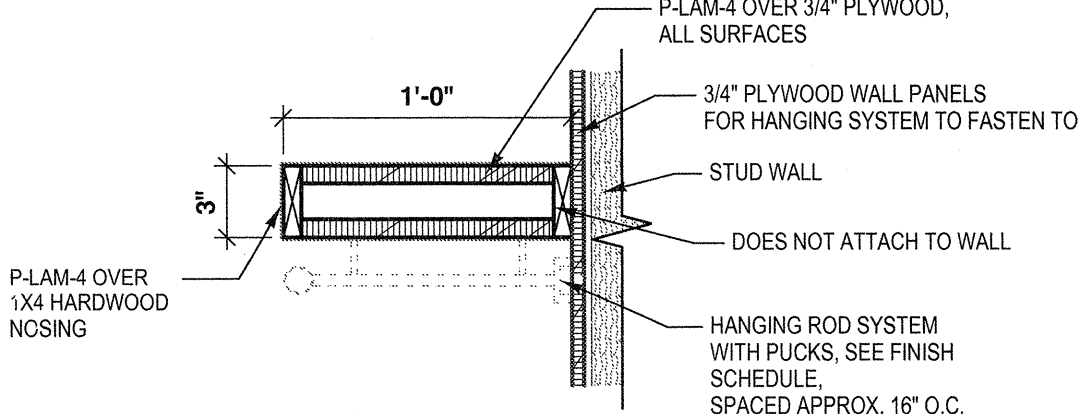


OPTION REMOVABLE SHELF SECTION
W/ HANGING ROD- OPTION 2
1'-1/2" = 1'-0"


NOTE: HANGING PUCKS MUST BE INSTALLED PRIOR TO HANGING PLYWOOD WALLS & WALL FINISHING

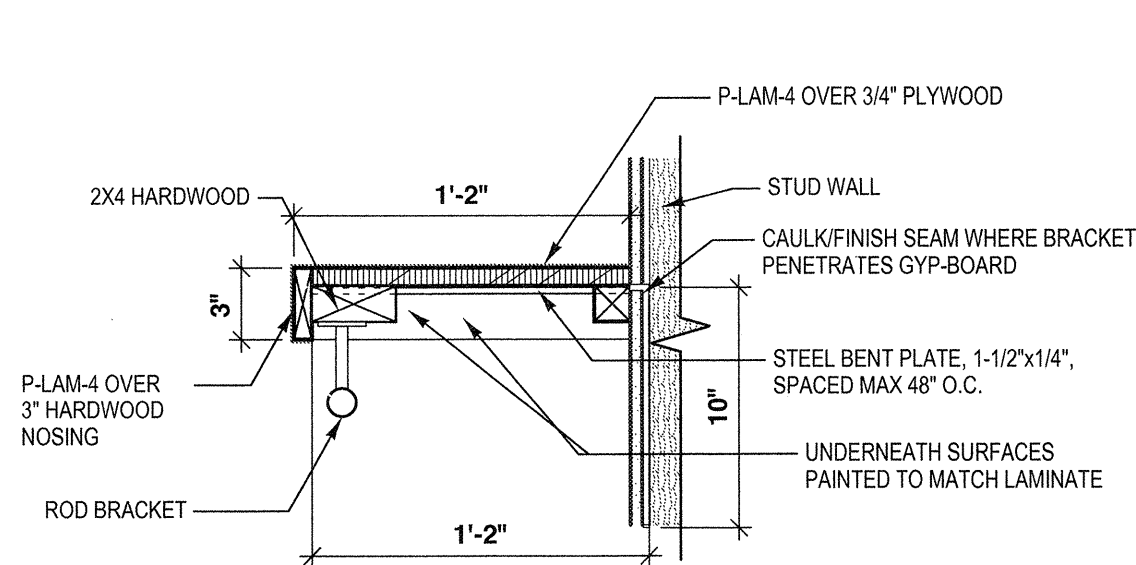


FLOATING SHELF SECTION
W/ HANGING ROD- OPTION 1
1'-1/2" = 1'-0"

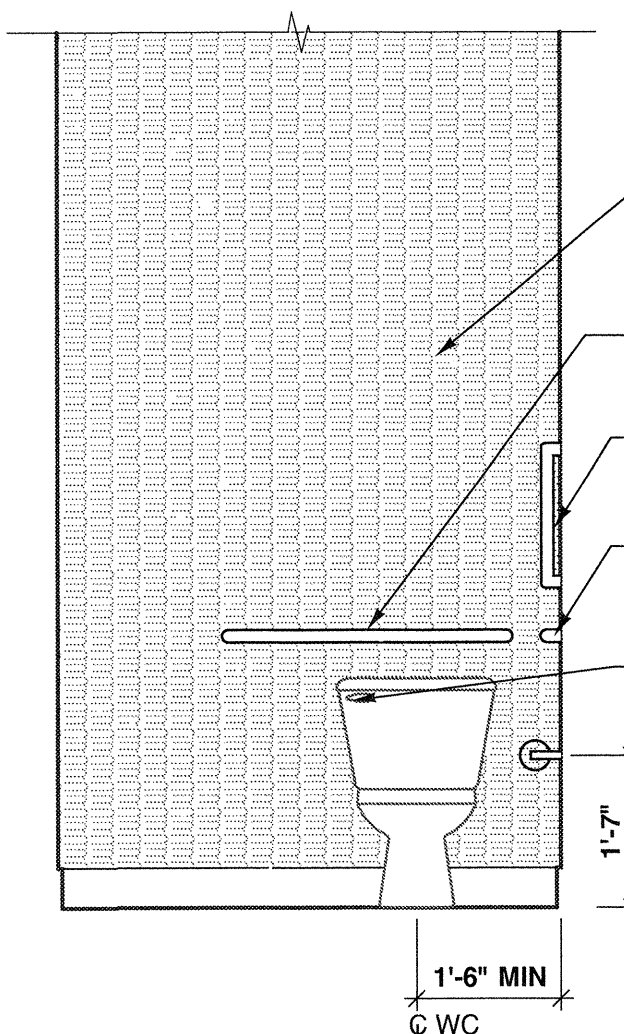

6 RESTROOM ELEVATION
1/2" = 1'-0"

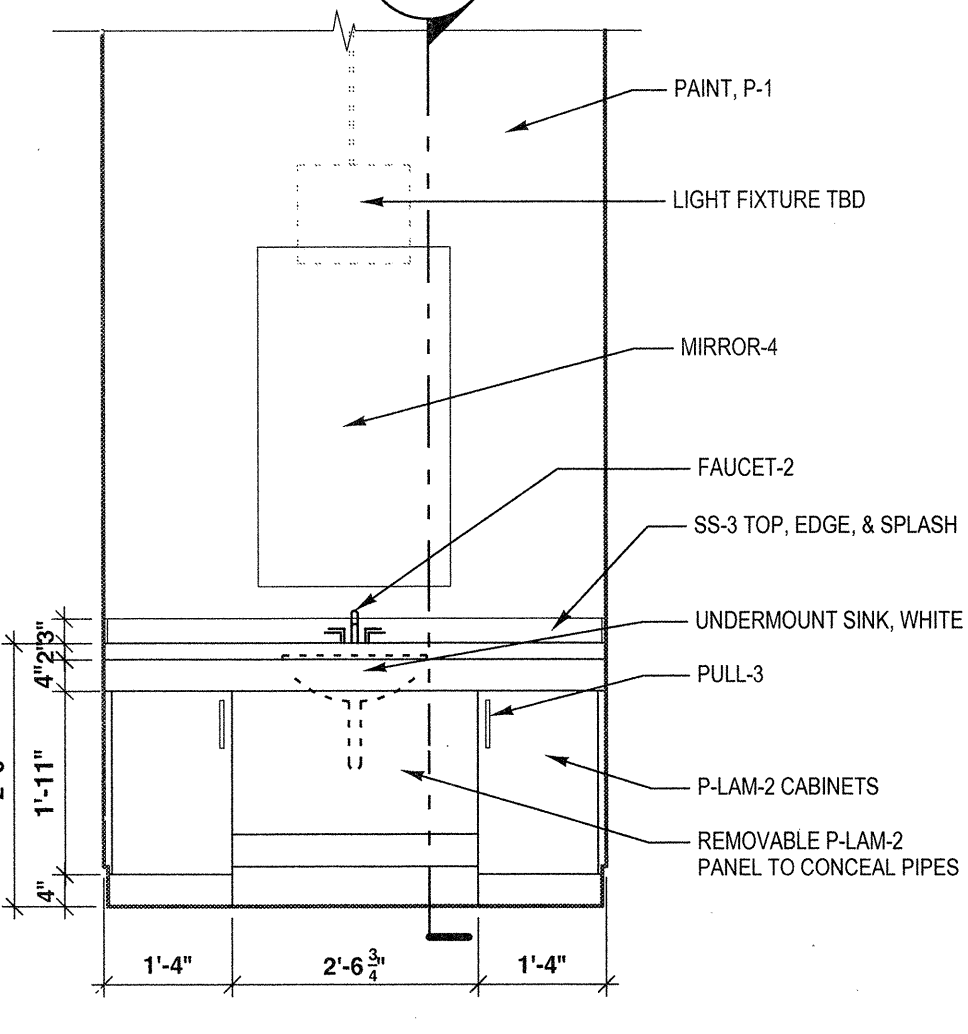


5 RESTROOM ELEVATION
1/2" = 1'-0"

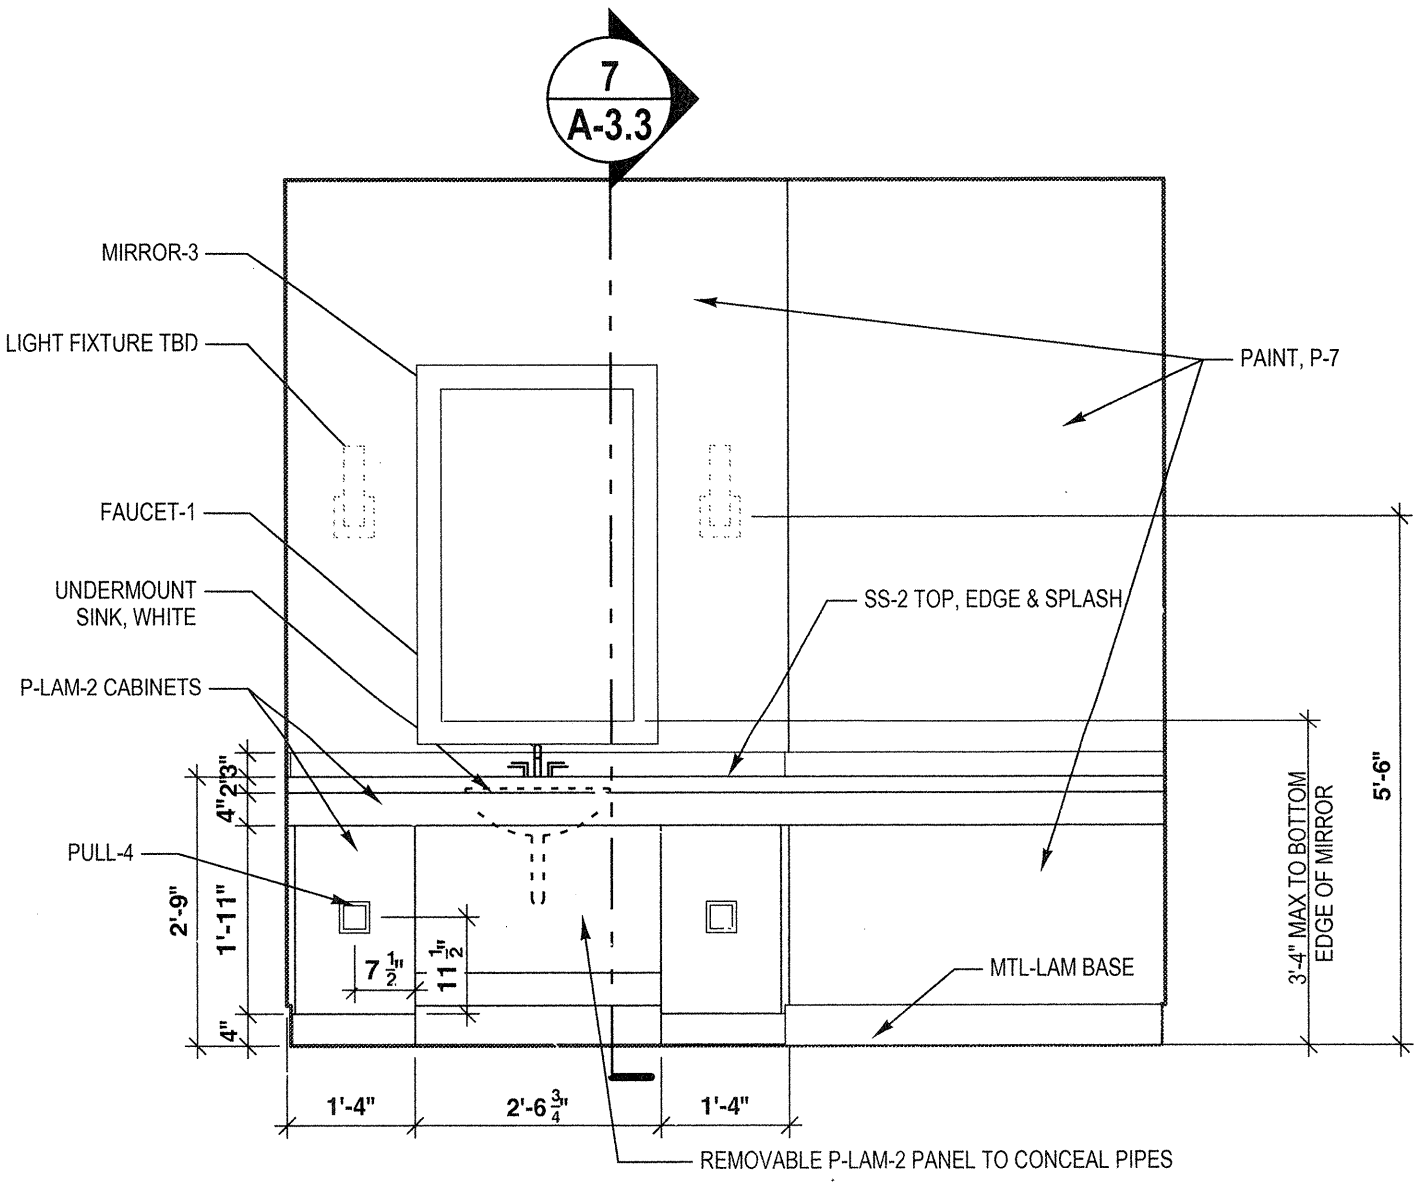

1 RESTROOM SOUTH ELEVATION
1/2" = 1'-0"

CONSTRUCTION SET A-3.3

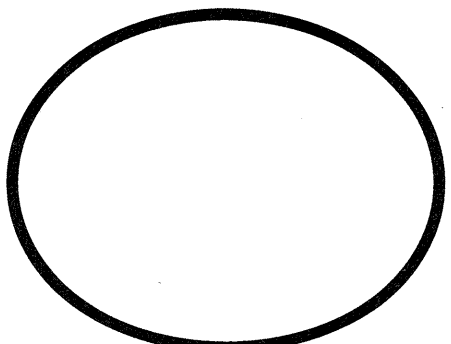

WILLIAMS
& DEAN
ASSOCIATED
ARCHITECTS


EIGHTEEN
CORPORATE HILL DRIVE
LITTLE ROCK, AR 72205
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MONROW BOUTIQUE
THE VILLAGE at HENDRIX

CONWAY, ARKANSAS

SHEET TITLE	
MILLWORK, INTERIOR ELEVATIONS, FINISH FLOOR PLAN & FINISH SCHEDULE	
REVISION:	
1	21 SEPT 2012
18 SEPT 2012	
12-096	
SHEET NUMBER	

MECHANICAL ABBREVIATIONS		NOTE: 1. ALL ABBREVIATIONS SHOWN MAY NOT BE APPLICABLE TO THE PROJECT. 2. REFER TO EQUIPMENT SCHEDULES FOR EQUIPMENT DESIGNATIONS. 3. REFER TO SYMBOLS FOR ADDITIONAL ABBREVIATIONS THAT MAY APPLY.					
A		E		M		T	
ABV A/C ACC ACCU ADJ AFC AFG AFUE AHU ALUM AMB AMP ANSI APD ARCH ARI ASHRAE ASME ASTM AUX AWG AWS AWW ASSY	ABOVE AIR CONDITIONER, AIR CONDITIONING AIR COOLED CHILLER AIR COOLED CONDENSING UNIT ADJUSTABLE ABOVE FINISHED CEILING ABOVE FINISHED FLOOR ABOVE FINISHED GRADE ANNUAL FUEL UTILIZATION EFFICIENCY AIR HANDLING UNIT ALUMINUM AMBIENT AMPERES AMERICAN NAT'L STANDARDS INSTITUTE AIR PRESSURE DROP (INCHES WC) ARCHITECT, ARCHITECTURAL AIR CONDITIONING & REFRIG INSTITUTE AMERICAN SOCIETY OF HEATING, REF. & AC ENGINEERS AMERICAN SOCIETY OF MECH ENGRS AMERICAN SOCIETY OF TESTING & MATLS AUXILIARY AMERICAN WIRE GAUGE AMERICAN WELDING SOCIETY AMERICAN WATER WORKS ASSOC. ASSEMBLY	EA EAT EC ECC EDB ELEV ELEC ENCL EQP, EQUIP ESP EWB EWC EWT EXH EXIST EXT	EXHAUST AIR, EACH ENTERING AIR TEMPERATURE ELECTRICAL CONTRACTOR ECCENTRIC ENTERING DRY BULB ELEVATION ELECTRICAL ENCLOSURE EQUIPMENT EXTERNAL STATIC PRESSURE ENTERING WET BULB ELECTRICAL WATER COOLER ENTERING WATER TEMPERATURE EXHAUST EXISTING EXTRUDED	MAX MBTU, MBH MC MCA MGB MCC MD MECH MFR MOCP MH MIN MTD	MAXIMUM 1000 BTU PER HOUR MECHANICAL CONTRACTOR MINIMUM CIRCUIT AMPACITY MAIN CIRCUIT BREAKER MOTOR CONTROL CENTER MOTORIZED DAMPER MECHANICAL MANUFACTURER MAXIMUM OVER CURRENT PROTECTION MANHOLE, METAL HALIDE MINIMUM MOUNTED	TDH TE THRU TOT TP TSP TSTAT TWR TWS TYP	TOTAL DYNAMIC HEAD TENANT EXHAUST (TOILET) THROUGH TOTAL TOTAL PRESSURE TOTAL STATIC PRESSURE THERMOSTAT TOWER WATER RETURN TOWER WATER SUPPLY TYPICAL
B		F		N		U	
BAS BD BFW BKR BLDG BOD BOP BOS BTU	BUILDING AUTOMATION SYSTEM BACKDRAFT DAMPER BOILER FEED WATER BREAKER BUILDING BOTTOM OF DUCT BOTTOM OF PIPE BOTTOM OF STRUCTURE BRITISH THERMAL UNIT	FA FACP FCO FL FLA FLEX FLR FPI FPM FT °F	FIRE ALARM FIRE ALARM CONTROL PANEL FLOOR CLEANOUT FLOW LINE FULL LOAD AMPS FLEXIBLE FLOOR FINS PER INCH FEET PER MINUTE FOOT, FEET DEGREES FAHRENHEIT	N/A NC NEC NEMA NFPA NIC NO NPSH NTS	NOT APPLICABLE NOISE CRITERIA, NORMALLY CLOSED NATIONAL ELECTRICAL CODE NATIONAL ELECTRICAL MFR'S ASSOC. NATIONAL FIRE PROTECTION ASSOC. NOT IN CONTRACT NORMALLY OPEN NET POSITIVE SUCTION HEAD NOT TO SCALE	UC U/F U/G U/S UL UNO UPS	UNDERCUT UNDERFLOOR UNDERGROUND UNDERSLAB UNDERWRITERS LABORATORIES, INC. UNLESS NOTED OTHERWISE UNINTERRUPTABLE POWER SUPPLY
C		G		O		V	
CAP CATV CCTV CC CFH CFM CFS CHR CHW CIRC CKT CL CLG CMU CO CONN COTG COL CPVC CRD CU °C CV CWR CWS CW	CAPACITY CABLE TELEVISION SYSTEM CLOSED CIRCUIT TELEVISION CONCRETE CUBIC FEET PER HOUR CUBIC FEET PER MINUTE CUBIC FEET PER SECOND CHILLED WATER RETURN CHILLED WATER SUPPLY CIRCULATING CIRCUIT CENTERLINE CEILING CONCRETE MASONRY UNIT CLEANOUT CONNECT, CONNECTION CLEANOUT TO GRADE COLUMN CHLORINATED POLYVINYL CHLORIDE CEILING RADIATION DAMPER COPPER DEGREES CELSIUS CONSTANT VOLUME CONDENSER WATER RETURN CONDENSER WATER SUPPLY COLD WATER	GRND GA GAL GALV GC GFI, GFC GPD GPH GPM GW	GROUND GAUGE GALLON GALVANIZED GENERAL CONTRACTOR GROUND FAULT INTERRUPTER GALLONS PER DAY GALLONS PER HOUR GALLONS PER MINUTE GREASE WASTE	OA OBD OC OD ODB OH OPNG OS&Y OSHA OF/CI	OUTSIDE AIR (VENTILATION AIR) OPPOSED BLADE DAMPER ON CENTER OUTSIDE DIAMETER OUTDOOR DRY BULB OVERHEAD OPENING OUTSIDE STEM AND YOKE OCCUPATIONAL SAFETY & HEALTH ADMIN. OWNER FURNISHED/CONTRACTOR INSTALLED	VA VAC VAV VD VEL VERT VTR	VOLT, VENT, VERTICAL VOLT-AMPERE VACUUM VARIABLE AIR VOLUME VOLUME DAMPER VELOCITY VERTICAL VENT THROUGH ROOF
D		H		P		W	
D DB DBL dB DEF DEG DESIG DDC DIA, Ø DIM DISC DN DPOT DPST DS DWG DX	DEEP, DEPTH DRY BULB DOUBLE DECIBEL DEFLECTION DEGREES DESIGNATED, DESIGNATION DIRECT DIGITAL CONTROL DIAMETER DIMENSION DISCONNECT DOWN DOUBLE-POLE, DOUBLE-THROW DOUBLE-POLE, SINGLE-THROW DOWNSPOUT, DISCONNECT SWITCH DRAWING DIRECT EXPANSION	HD HGBP HGRH HID HOA HORIZ HP HSPF HSTAT HT HTG HTR HVAC HW HYD HZ	HEAD, HUB DRAIN, HEAVY DUTY HOT GAS BYPASS HOT GAS REHEAT HIGH INTENSITY DISCHARGE HAND-OFF-AUTOMATIC HORIZONTAL HORSEPOWER HEATING SEASON PERFORMANCE FACTOR HUMIDISTAT HEIGHT HEATING HEATER HEATING, VENTILATING & A/C HOT WATER HYDRANT HERTZ	PC PD PF PH PIV PLBG PNL PSF PSI PSIA PSIG PRV PVC	PLUMBING CONTRACTOR PRESSURE DROP POWER FACTOR PHASE POST INDICATOR VALVE PLUMBING PANEL POUNDS PER SQUARE FOOT POUNDS PER SQUARE INCH POUNDS PER SQUARE INCH ABSOLUTE POUNDS PER SQUARE INCH GAUGE PRESSURE RELIEF VALVE POLYVINYL CHLORIDE	W/ W/O WB WC WPD WT WWF	WATT, WIDTH WITH WITHOUT WET BULB WATER COLUMN WATER PRESSURE DROP WATERTIGHT, WEIGHT WELDED WIRE FABRIC
E		I		Q		X	
		ID IDB IE IN IN WC	INSIDE DIAMETER INDOOR DRY BULB INVERT ELEVATION INCH, INCHES INCHES OF WATER COLUMN	QTY	QUANTITY	XFRMR	TRANSFORMER
J		K		R		OTHER	
		J-BOX	JUNCTION BOX	RA RCP RD RE RECIRC REINF REQD REV RH RHG RL RLA RM RPM RS	RETURN AIR REFLECTED CEILING PLAN ROOF DRAIN REFERENCE, REFER TO RECIRCULATE REINFORCING, REINFORCED REQUIRED REVISION, REVISE RELATIVE HUMIDITY, RIGHT-HAND REFRIGERANT HOT GAS REFRIGERANT LIQUID RUNNING LOAD AMPS ROOM REVOLUTIONS PER MINUTE REFRIGERANT SUCTION	12x12 12/12 129	RECTANGULAR DUCT SIZE OVAL DUCT SIZE ROUND DUCT SIZE
L		S					
		KVA KW KWH	KILOVOLT-AMPS KILOWATTS KILOWATT-HOUR	SA SD SECT SENS SF SGL SHT SM SMACNA SOV SP SPEC SQ SS STD STL SURF SUSP	SUPPLY AIR SMOKE DAMPER, STORM DRAIN, SUPPLY DIFFUSER SECTION SENSIBLE SQUARE FEET, SQUARE FOOT SINGLE SHEET SHEET METAL SHEET METAL & A/C CONT NAT'L ASSOC. SHUT-OFF VALVE STATIC PRESSURE SPECIFICATION, SPECIFY SQUARE STAINLESS STEEL, SANITARY SEWER STANDARD STEEL SURFACE SUSPEND, SUSPENDED		

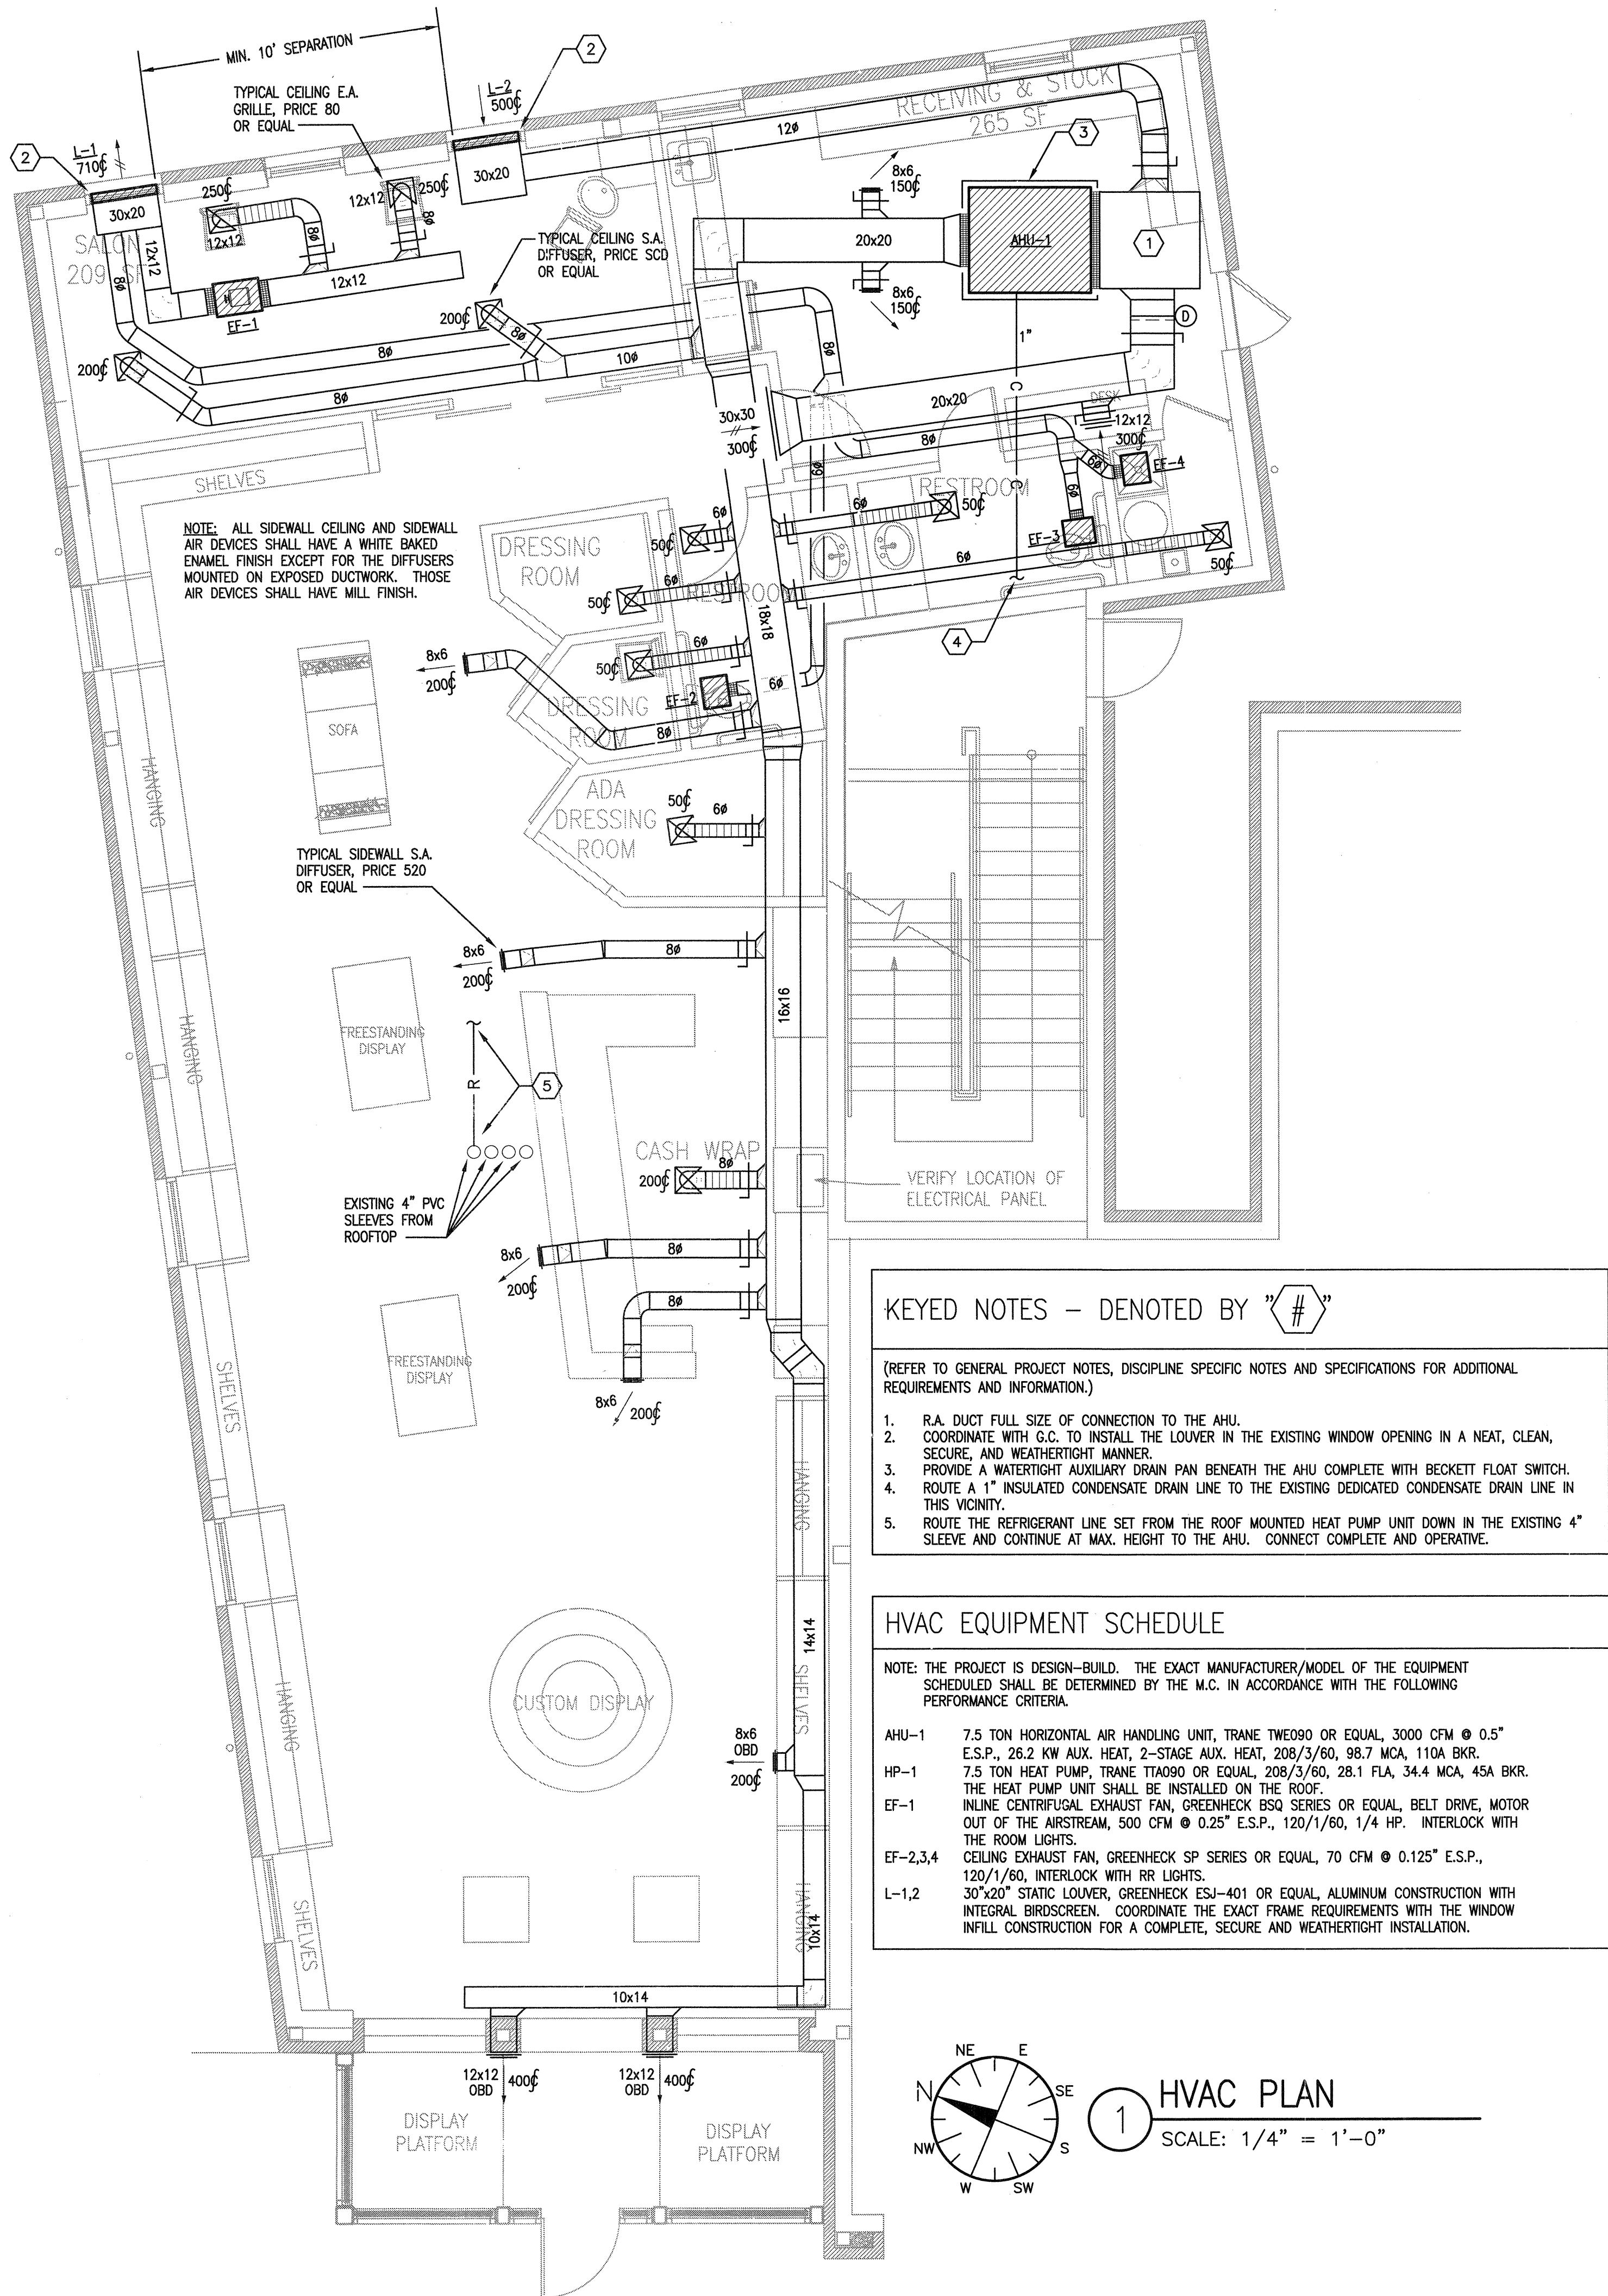


HVAC GENERAL NOTES

- A. GENERAL REQUIREMENTS:
- UNLESS SPECIFICALLY NOTED OTHERWISE, THE TERM "CONTRACTOR" INDICATED ON ANY GIVEN DIVISION 15 PLAN SHEET SHALL REFER TO THE CONTRACTOR RESPONSIBLE FOR THE WORK OF THE SPECIFIC TRADE NOTED ON THAT PLAN SHEET.
 - ALL WORK SHALL BE IN STRICT ACCORDANCE WITH THE ARKANSAS MECHANICAL CODE AND THE REQUIREMENTS OF ALL LOCAL, STATE, AND FEDERAL AUTHORITIES HAVING JURISDICTION, WHETHER OR NOT THE REQUIREMENTS ARE SPECIFICALLY INDICATED IN THE CONTRACT DOCUMENTS.
 - THE CONTRACTOR SHALL VISIT ALL SITES AND FIELD VERIFY ALL EXISTING CONDITIONS PRIOR TO BID.
 - THE ENGINEERING DRAWINGS ARE DIAGRAMMATIC IN NATURE. WHILE A CONCERTED EFFORT HAS BEEN MADE TO PROVIDE SYSTEM ARRANGEMENTS AND LAYOUTS IN A NONCONFLICTIVE MANNER, THE FINAL RESPONSIBILITY FOR COORDINATION OF SYSTEM ROUTING, FABRICATION, AND INSTALLATION BELONGS TO THE INSTALLING CONTRACTORS. FABRICATION AND INSTALLATION OF THE VARIOUS ENGINEERING SYSTEMS SHALL NOT BEGIN UNTIL VERIFICATION OF ALL ARCHITECTURAL, STRUCTURAL, MECHANICAL, PLUMBING, FIRE PROTECTION, AND ELECTRICAL DRAWINGS HAS TAKEN PLACE. NO ADDITIONAL COMPENSATION SHALL BE GRANTED FOR ANY CHANGES REQUIRED DUE TO INSTALLATION CONFLICTS BETWEEN TRADES. ALSO, THE "I WAS HERE FIRST" RULE DOES NOT QUALIFY AS COORDINATION.
 - THE WORK SPECIFIED HEREIN SHALL INCLUDE ALL LABOR, MATERIALS, TOOLS, EQUIPMENT, SUPPLIES AND SUPERVISION REQUIRED TO INSTALL AND PLACE IN OPERATION THE MECHANICAL SYSTEMS AND APPURTENANCES SPECIFIED HEREIN AND/OR INDICATED ON THE DRAWINGS OR REASONABLY IMPLIED AS NECESSARY FOR COMPLETION OF THE VARIOUS SYSTEMS. ALL WORK SHALL BE COMPLETED IN A NEAT, CLEAN, AND WORKMANLIKE MANNER IN ACCORDANCE WITH CURRENT INDUSTRY STANDARDS.
 - ALL WORK SPECIFIED HEREIN SHALL BE PERFORMED BY PROPERLY LICENSED, TRAINED, AND EXPERIENCED TRADESMEN. THE CONTRACTOR SHALL PROVIDE A FIELD SUPERVISOR WITH THE AUTHORITY AND EXPERIENCE REQUIRED TO INSTRUCT THE WORK, MAKE JOB DECISIONS, AND ACT ON BEHALF OF THE CONTRACTOR IN MATTERS PERTAINING TO THE CONTRACT DOCUMENTS.
 - THE CONTRACTOR SHALL REMOVE ALL RESPECTIVE CONSTRUCTION WASTE AND DEBRIS FROM THE SITE AND SHALL BE RESPONSIBLE FOR THE LAWFUL DISCARD OF SUCH WASTE IN ACCORDANCE WITH ALL LOCAL, STATE, AND FEDERAL REQUIREMENTS. THE COMPLETED WORK AND THE ADJACENT AFFECTED AREAS SHALL BE THOROUGHLY CLEANED TO THE SATISFACTION ON THE OWNER, ARCHITECT, AND ENGINEER.
 - THE CONTRACTOR SHALL REFER TO THE ARCHITECTURAL PLANS AS REQUIRED TO CAREFULLY COORDINATE THE REQUIRED MOUNTING HEIGHTS AND LOCATIONS OF ALL DIFFUSERS, REGISTERS, AND GRILLES RELATIVE TO THE VARIOUS CEILING AND WALL CONDITIONS/TYPES THROUGHOUT THE BUILDING.
- B. FIRE/SMOKE DETECTION AND RATED OPENING PROTECTIVES:
- SMOKE DETECTORS SHALL BE INSTALLED IN RETURN AIR SYSTEMS WITH A DESIGN CAPACITY OF 2,000 CFM OR GREATER. DUCT SMOKE DETECTORS SHALL BE INSTALLED IN ACCORDANCE WITH NFPA 72 AND SHALL BE CONNECTED TO A FIRE ALARM SYSTEM. ACTUATION OF THE DUCT SMOKE DETECTOR SHALL SHUT DOWN THE AIR DISTRIBUTION SYSTEM AND ACTIVATE A VISIBLE AND AUDIBLE SUPERVISORY SIGNAL IN A NORMALLY ATTENDED LOCATION. IN OCCUPANCIES WHERE A FIRE ALARM SYSTEM IS NOT REQUIRED, ACTUATION OF THE DUCT SMOKE DETECTOR SHALL SHUT DOWN THE AIR DISTRIBUTION SYSTEM AND ACTIVATE A STAND-ALONE VISIBLE AND AUDIBLE SIGNAL IN AN APPROVED LOCATION. THE STAND-ALONE SIGNAL DEVICE SHALL BE LABELED "AIR DUCT DETECTOR TROUBLE". IN SYSTEMS THAT ARE INCAPABLE OF SPREADING SMOKE BEYOND THE ENCLOSING WALLS, FLOORS AND CEILINGS OF THE ROOM OR SPACE IN WHICH THE SMOKE IS GENERATED, SMOKE DETECTORS SHALL NOT BE REQUIRED.
 - DUCT SMOKE DETECTORS SHALL BE LOCATED AS FOLLOWS:
 - AIR HANDLING UNITS - LOCATE THE SMOKE DETECTOR IN THE RETURN AIR DUCT DOWNSTREAM OF THE LAST RETURN AIR BRANCH DUCT CONNECTION AND UPSTREAM OF ANY FRESH AIR DUCT CONNECTION, FILTERS, EXHAUST AIR CONNECTION, OR DECONTAMINATION EQUIPMENT AND APPLIANCES.
 - PACKAGED HVAC UNITS - LOCATE THE SMOKE DETECTOR EITHER IN THE RETURN AIR DUCT AS DESCRIBED ABOVE OR IN THE RETURN AIR SECTION OF THE UNIT CASING AS DIRECTED BY THE PACKAGED UNIT MANUFACTURER.
 - ALL PENETRATIONS THROUGH FIRE AND/OR SMOKE RATED CONSTRUCTION SHALL BE SEALED UTILIZING U.L. LISTED MATERIALS AND DESIGNS TO MAINTAIN THE RATING. ALL FIRE, SMOKE AND COMBINATION DAMPERS SHALL BE U.L. LISTED, APPROPRIATE FOR LISTED INSTALLATION TYPE, AND INSTALLED IN STRICT ACCORDANCE WITH THE DAMPER MANUFACTURER'S INSTRUCTIONS AND THE DAMPER'S LISTING. DUCT MOUNTED ACCESS DOORS SHALL BE PROVIDED AT ALL FIRE DAMPERS NOT LOCATED AT AIR DEVICES. ACCESS DOORS SHALL BE SIZED AS APPROPRIATE FOR FULL SERVICE ACCESS TO DAMPER FUSIBLE LINKS, MOTORIZED ACTUATORS, ETC.
- C. ALL DUCT SIZES ARE METAL-METAL DIMENSIONS, EXPRESSED IN INCHES. DOUBLE-WALL SPIRAL DUCT SIZES (WHEN SHOWN) INDICATE THE INNER WALL DIAMETER.
- D. ALL CHANGES IN DUCT DIRECTION 45-DEGREES OR GREATER SHALL BE FULL RADIUS TURNS WITH AN INSIDE RADIUS EQUAL TO THE DUCT WIDTH. IN RECTANGULAR DUCTWORK, WHERE SPACE CONSTRAINTS DO NOT PERMIT RADIUS TURNS, OR WHERE THE CONTRACT DOCUMENTS REFLECT OTHERWISE, MITERED ELBOWS WITH SINGLE THICKNESS TURNING VANES SHALL BE PROVIDED. RECTANGULAR 90'S WITH A RADIUS HEEL AND A MITERED THROAT ARE NOT ACCEPTABLE.
- E. PROVIDE MINIMUM 3/4" GAP BENEATH THE DOOR FOR R.A. IN SPACES WITH 125 CFM S.A. OR LESS AND WHERE THERE IS NO DEDICATED R.A. DUCT OR TRANSFER DUCT.
- F. ALL CEILING MOUNTED AIR DEVICES INSTALLED IN LAY-IN CEILINGS SHALL BE POSITIONED IN THE FULL GRID SPACE NEAREST TO THE LOCATION SHOWN ON THE PLANS.
- G. ALL CONDENSATE DRAINS SERVING COILING COILS SHALL BE TRAPPED AS RECOMMENDED BY THE COIL MANUFACTURER. INDIVIDUAL CONDENSATE DRAIN TRAPS AND LINES SHALL BE FULL SIZE OF CONNECTION TO COIL, BUT IN NO CASE SMALLER THAN 3/4". CONDENSATE DRAINS SHALL NOT TERMINATE AT THE SANITARY SEWER SYSTEM.
- H. ALL MECHANICAL PIPING SYSTEMS SHALL BE PROTECTED AGAINST DISSIMILAR METAL GALVANIC CORROSION BY SEPARATION, INSULATION, OR ENGINEERED CONNECTIONS SUCH AS DIELECTRIC UNIONS.
- I. THE CONTRACTOR SHALL COORDINATE THE EXACT REFRIGERANT LINE SET LENGTH(S) WITH THE EQUIPMENT MANUFACTURER. THE EQUIPMENT MANUFACTURER SHALL BE RESPONSIBLE FOR ALL REFRIGERANT LINE SET SIZING AND RECOMMENDING ANY ADDITIONAL PIPING APPURTENANCES REQUIRED FOR LONG LINE SET APPLICATIONS TO RESULT IN A COMPLETE, OPERATIVE, AND WARRANTABLE INSTALLATION.
- J. PROVIDE ENGRAVED PLASTIC LAMINATE EQUIPMENT TAGS ON ALL HVAC UNITS. NOMENCLATURE SHALL BE PROPOSED BY HVAC CONTRACTOR AND APPROVED BY OWNER PRIOR TO FABRICATION.
- K. HVAC CONTROLS:
- THERMOSTAT LOCATIONS SHOWN ON THE PLANS ARE APPROXIMATE. VERIFY ALL LOCATIONS WITH THE ARCHITECT/OWNER. IF THE FINAL LOCATIONS OF THE THERMOSTATS DIFFER FROM THOSE SHOWN ON THE PLANS, THE NEW LOCATIONS SHALL BE SUBMITTED TO THE MECHANICAL ENGINEER FOR APPROVAL. INSTALL WALL-MOUNTED THERMOSTATS AT 54" A.F.F. IN A HEAVY DUTY METAL LOCK BOX WITH KEYS LOCKING COVER.
 - THERMOSTATS AND TEMPERATURE SENSORS SHALL NOT BE MOUNTED ON EXTERIOR WALLS. WHEN MOUNTING OF THERMOSTATS OR TEMPERATURE SENSORS ON OUTSIDE WALLS IS UNAVOIDABLE, MINIMUM 1" THICK RIGID INSULATION SHALL BE PLACED BETWEEN THE WALL AND THE THERMOSTAT OR SENSOR BASE. THE RIGID INSULATION SHALL BE COVERED NEAT AND CLEAN WITH A PREFINISHED SHEET METAL COVER (COLOR TO BE SELECTED BY OWNER).
 - HVAC CONTROL WIRING SHALL BE MINIMUM 16 GAUGE MULTI-STRAND PLENUM-RATED WIRING. ALL WIRING LOCATED IN, ABOVE OR BEHIND INACCESSIBLE CONSTRUCTION SHALL BE INSTALLED IN 3/4" EMT CONDUIT. ALL WIRING SHALL BE ROUTED CONTINUOUS FROM THE CONTROL DEVICE TO THE CONTROLLER OR INTERFACE PANEL. SPLICE SHALL NOT BE PERMITTED. WIRING CONNECTIONS SHALL EITHER BE CRIMPED OR SOLDERED.
 - THE MECHANICAL CONTRACTOR SHALL PROVIDE TRAINING TO THE OWNER ON ALL HVAC CONTROL SYSTEMS, INCLUDING STAND-ALONE THERMOSTATS.
- L. PROJECT DOCUMENTATION:
- THE CONTRACTOR SHALL MAINTAIN A CLEAN SET OF MECHANICAL AS-BUILT RECORD DRAWINGS SEPARATE FROM THE FIELD CONSTRUCTION SET. ALL CHANGES TO THE ORIGINAL MECHANICAL DESIGN SHALL BE NOTED ON THE AS-BUILT RECORD DRAWINGS IN A NEAT, CLEAN AND ORDERLY MANNER, AND IN RED INK OR PENCIL. AT PROJECT COMPLETION THESE DRAWINGS SHALL BE SUBMITTED TO THE ARCHITECT/ENGINEER FOR APPROVAL PRIOR TO SUBMISSION TO THE OWNER.
 - THE CONTRACTOR SHALL EMPLOY THE SERVICES OF A THIRD-PARTY, NEBB CERTIFIED AIR TEST AND BALANCE CONTRACTOR. TAB REPORT SHALL INCLUDE SCHEDULED AND ACTUAL SYSTEM INFORMATION INCLUDING SYSTEM AIR FLOWS, INDIVIDUAL AIR DEVICE AIR FLOWS, ENTERING AND LEAVING STATIC PRESSURES, RUNNING VOLTAGE AND AMPERAGE, AND ENTERING AND LEAVING AIR TEMPERATURES ACROSS COILS/HEAT EXCHANGERS. AIR FLOWS SHALL BE BALANCED TO WITHIN +/- 5% OF SCHEDULED VALUES. (3) BOUND COPIES OF THE TAB REPORT SHALL BE SUBMITTED TO THE ARCHITECT.
 - THE CONTRACTOR SHALL PROVIDE A WRITTEN ONE (1) YEAR WARRANTY TO KEEP ALL WORK EMBRACED IN THESE CONTRACT DOCUMENTS IN REPAIR AND PROPER WORKING ORDER, WITHOUT CHARGE, FOR A PERIOD OF ONE (1) YEAR FROM DATE OF FINAL ACCEPTANCE OF THE WORK BY THE OWNER.

HVAC MATERIAL SPECIFICATIONS

- THE STANDARD OF QUALITY FOR ALL MECHANICAL EQUIPMENT PROVIDED SHALL BE AS ESTABLISHED BY THE BASIS OF DESIGN INDICATED FOR EACH PIECE OF EQUIPMENT. THE MATERIAL, MANUFACTURING, AND PERFORMANCE SPECIFICATIONS OF THE SPECIFIC MANUFACTURER AND MODEL OF EACH PIECE OF EQUIPMENT SCHEDULED AND SPECIFIED HEREIN SHALL ESTABLISH THE MINIMUM ACCEPTABLE STANDARD OF QUALITY, PERFORMANCE, AND WORKMANSHIP. ALL EQUIPMENT SHALL BE PRODUCTS OF A MANUFACTURER REGULARLY ENGAGED IN THE MANUFACTURE OF COMMERCIAL EQUIPMENT WITH THE ABILITY TO PROVIDE PERFORMANCE DATA GENERATED BY ARI CERTIFIED SOFTWARE. ALTERNATE PRODUCTS SHALL MEET OR EXCEED THE BASIS OF DESIGN.
- MECHANICAL PIPING:
 - REFRIGERANT PIPING: ASTM B280, TYPE ACR COPPER, HARD TEMPER, CLEANED, DEHYDRATED, AND SEALED. FITTINGS SHALL BE WROUGHT COPPER WITH CADMIUM FREE SOLDER, 45% SILVER BRAZING ALLOY, CLASS BAg-5.
 - CONDENSATE DRAIN PIPING: ASTM B88, HARD DRAWN COPPER WITH ANSI B16.22 WROUGHT COPPER FITTINGS -OR- ASTM B306, TYPE DWV COPPER WITH ANSI B16.29 WROUGHT COPPER FITTINGS. JOIN COPPER PIPE WITH ASTM B32 LEAD FREE SOLDER, GRADE 95TA 95-5 TIN-ANTIMONY.
- PIPE INSULATION:
 - ALL REFRIGERANT SUCTION LINES SHALL RECEIVE 3/4" FLEXIBLE CELLULAR INSULATION AS SPECIFIED HEREIN.
 - HVAC CONDENSATE DRAIN LINES ON THE BUILDING INTERIOR SHALL RECEIVE 1/2" FLEXIBLE CELLULAR INSULATION AS SPECIFIED HEREIN.
 - INSULATION MATERIALS: ASTM C534, TYPE 1 ARMAFLEX AP ARMAFLEX FLEXIBLE CELLULAR INSULATION MEETING ASTM E84 FOR MIN 25/50 FLAME SPREAD AND SMOKE DEVELOPED INDEX. REFRIGERANT SUCTION LINE INSULATION ON THE BUILDING EXTERIOR SHALL HAVE 2 COATS OF MANUFACTURER'S RECOMMENDED U.V. MASTIC APPLIED.
- HVAC DUCTWORK CONSTRUCTION: ALL HVAC GALVANIZED DUCTWORK SHALL BE FABRICATED USING ASTM A653 COMMERCIAL GRADE LOCK FORMING G-90/G-60 MATERIALS. ALL HVAC DUCTWORK SHALL BE CONSTRUCTED IN ACCORDANCE WITH SMACNA "HVAC DUCT CONSTRUCTION STANDARDS METAL AND FLEXIBLE" (<2" w.c.). ALL LONGITUDINAL AND TRANSVERSE DUCT JOINTS SHALL BE SEALED UTILIZING LISTED AND LABELED UL 181-A OR UL 181-B TAPES AND MASTICS.
- DUCT INSULATION:
 - SUPPLY AND RETURN DUCTS: SUPPLY AND RETURN AIR DUCTWORK SHALL RECEIVE 2" DUCT WRAP AS SPECIFIED HEREIN.
 - OUTSIDE AIR AND EXHAUST DUCTS: ALL OUTSIDE AIR AND RESTROOM EXHAUST DUCTWORK SHALL RECEIVE MIN. 1" DUCT WRAP AS SPECIFIED HEREIN.
 - INSULATION MATERIALS:
 - EXTERNAL DUCT INSULATION SHALL BE ASTM C 1290, TYPE 75, FLEXIBLE BLANKET, 0.75# DENSITY, KNAUF DUCT WRAP OR EQUAL.
 - INTERNAL DUCT LINER SHALL BE ASTM C 1071, TYPE 1 FLEXIBLE DUCT LINER, 1.5# DENSITY. KNAUF DUCT LINER E-M OR EQUAL.
- HVAC DUCT ACCESSORIES:
 - BRANCH DUCT TAKE-OFF FITTINGS:
 - SUPPLY AIR DUCT TAKE-OFFS: EQUAL TO AIR-TITE MODEL HETDQ GALVANIZED HIGH-EFFICIENCY 45° FITTING WITH NEOPRENE GASKET ON FLANGE, INTEGRAL DAMPER WITH LOCKING QUADRANT LEVER AND 2" STAND-OFF BRACKET.
 - RETURN OR EXHAUST AIR DUCT TAKE-OFFS: EQUAL TO AIR-TITE MODEL CATDQ GALVANIZED FLAT FITTING WITH NEOPRENE GASKET ON FLANGE, INTEGRAL DAMPER WITH LOCKING QUADRANT LEVER AND 2" STAND-OFF BRACKET.
 - RECTANGULAR VOLUME DAMPERS: OPPOSED BLADE CONFIGURATION, 5-INCH DEEP 20 GAUGE GALVANIZED HAT CHANNEL FRAME, 16 GA. GALVANIZED STEEL BLADES, 1/2-INCH PLATED STEEL AXLES, OIL IMPREGNATED BRONZE BEARINGS, MANUAL HAND QUADRANT WITH STAND-OFF BRACKET, GREENHECK MBD-15 OR EQUAL.
 - ROUND VOLUME DAMPERS: 6-INCH WIDE 20 GAUGE GALVANIZED STEEL FRAME, 20 GAUGE GALVANIZED STEEL BLADE, 3/8-INCH SQUARE PLATED STEEL AXLES TURNING IN ACETAL BEARINGS, MANUAL HAND QUADRANT WITH STAND-OFF BRACKET, GREENHECK MBDR-50 OR EQUAL.
 - ROUND FLEXIBLE DUCTWORK: COATED FIBERGLASS WOVEN FABRIC OVER COATED HELICAL STEEL WIRE, FIBERGLASS SCRIM REINFORCED ALUMINIZED POLYESTER FILM OVER 2" 0.76# DENSITY FIBERGLASS INSULATION; U.L. 181, NFPA 90A, AND NFPA 90B COMPLIANT; THERMAFLEX M-KC OR EQUAL.
 - FIRE DAMPERS, SMOKE DAMPERS AND COMBINATION FIRE/SMOKE DAMPERS SHALL BE U.L. LISTED (#555 AND/OR #555S, AS APPLICABLE) ACCORDING TO THE TYPE REQUIRED. ALL DAMPERS SHALL BE INSTALLED IN STRICT ACCORDANCE WITH THE MANUFACTURER'S INSTRUCTIONS ACCORDING TO THE DAMPER'S LISTING, RATING, SERVICE TYPE, AND INSTALLATION REQUIREMENTS.

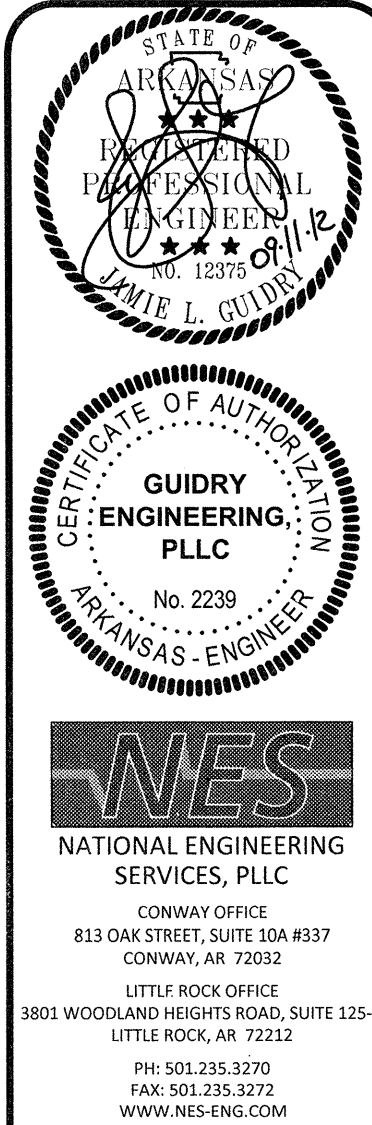

MONROW BOUTIQUE
THE VILLAGE at HENDRIX
CONWAY, ARKANSAS

PLUMBING NOTES,
SCHEDULE, AND DETAILS

REVISIONS

DATE	REV #	DESCRIPTION

NES PROJ. #

12044


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KEYED NOTES – DENOTED BY "#"


(REFER TO GENERAL PROJECT NOTES, DISCIPLINE SPECIFIC NOTES AND SPECIFICATIONS FOR ADDITIONAL REQUIREMENTS AND INFORMATION.)

- CONNECT TO THE EXISTING 1" CW STUB-UP, EXTEND TO MAX. HEIGHT, AND CONTINUE AS SHOWN.
- EXISTING CW STUB-UP FOR ADJACENT TENANT SPACE (NIC).
- DROP WITH A 1/2" CW LINE TO A REFRIGERATOR ICE MAKER VALVE BOX.
- THERE WILL BE A HAIR WASH SINK IN THIS LOCATION. THE SINK SHALL BE OWNER SUPPLIED AND CONTRACTOR INSTALLED. FIELD VERIFY THE EXACT CONNECTION REQUIREMENTS AND DIMENSIONS. PROVIDE A POINT-OF-USE HAIR TRAP IN THE SINK DRAIN PRIOR TO CONNECTION TO THE SANITARY SEWER SYSTEM. THE HAIR TRAP SHALL BE INSTALLED ACCESSIBLE BENEATH THE SINK.
- CAP THE EXISTING SEWER STUB-UP BELOW FINISHED SLAB.
- CONNECT TO THE EXISTING SEWER STUB-UP IN THIS VICINITY.
- DROP TO RPZ. RISE DOWNSTREAM OF THE RPZ TO MAX. HEIGHT AND CONTINUE AS SHOWN.

PLUMBING FIXTURE SCHEDULE

NOTE: THE PROJECT IS DESIGN-BUILD. THE P.C. SHALL WORK DIRECTLY WITH THE OWNER TO DETERMINE THE ACTUAL MANUFACTURER/MODEL OF ALL PLUMBING FIXTURES SCHEDULED.

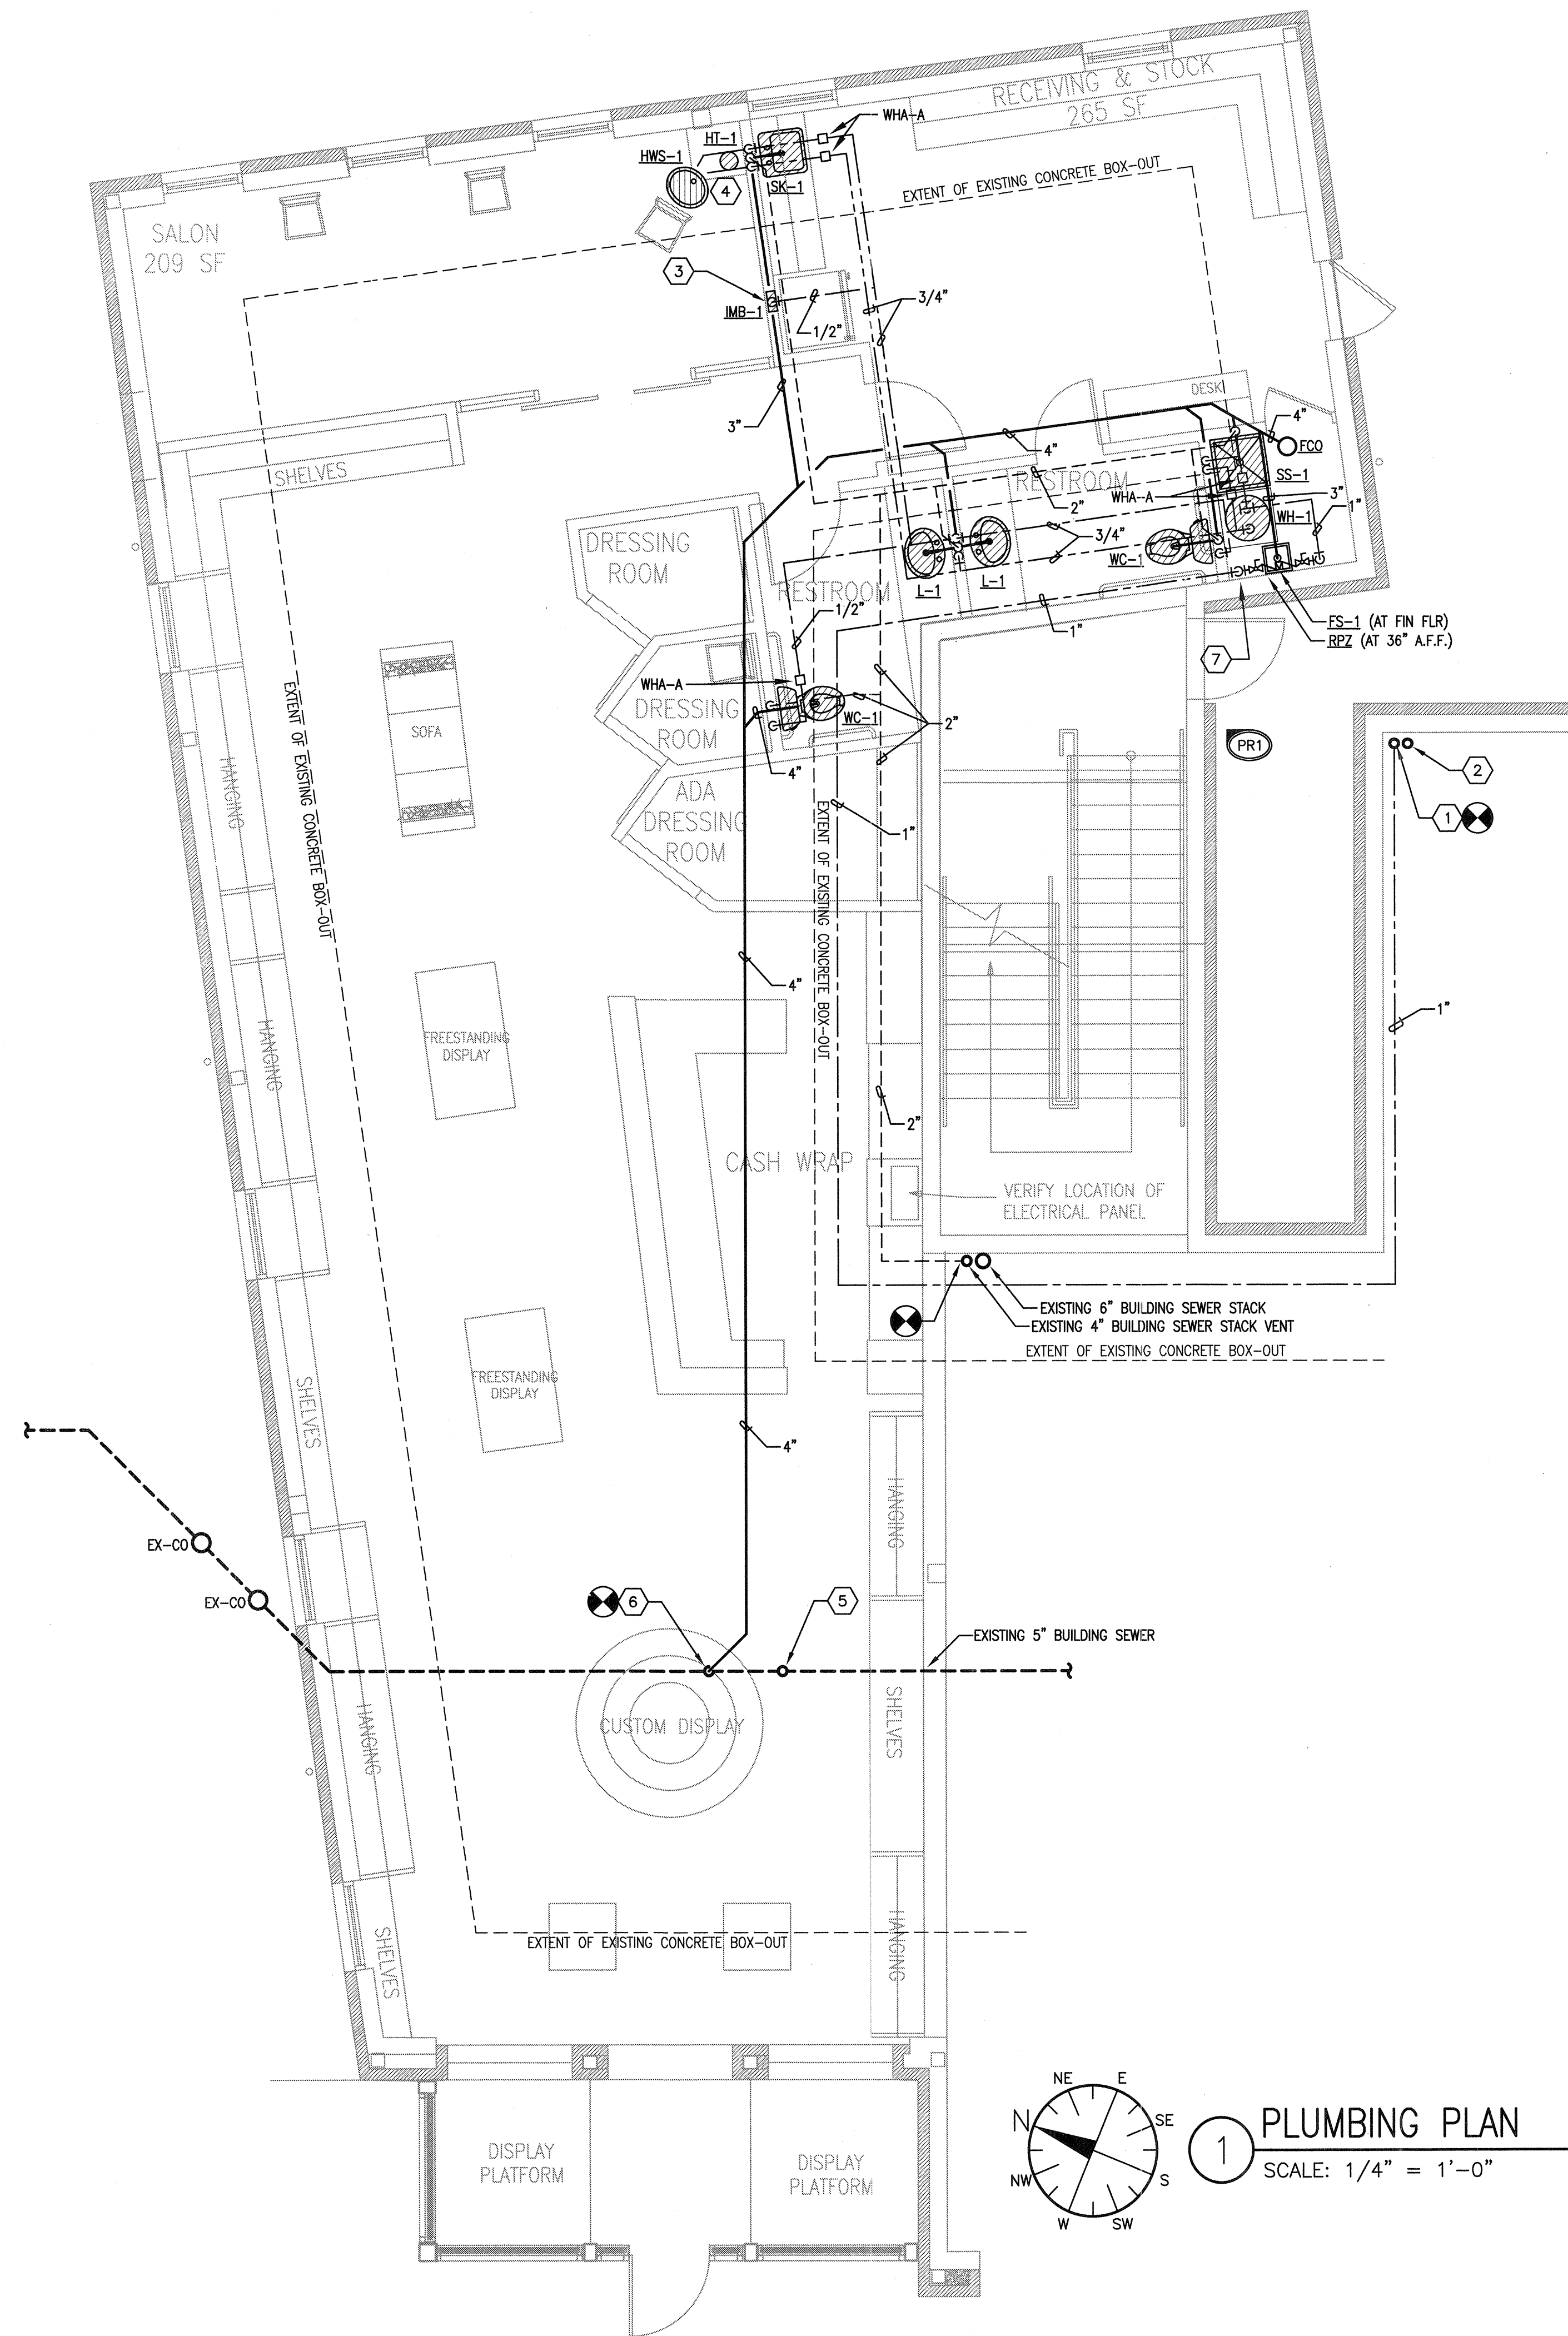
WC-1	TANK-TYPE VITREOUS CHINA TOILET, 1.6 GPF, ADA COMPLIANT, 17" MIN. TO 19" MAX. HIGH
L-1	SELF-RIMMING LAVATORY, ACCESSIBLE WITH ADA COMPLIANT CHROME FAUCET AND TRIM
SK-1	SELF-RIMMING, SINGLE BASIN SINK, CHROME FAUCET AND TRIM
SS-1	FLOOR-MOUNTED SERVICE SINK WITH WALL-MOUNT FAUCET, MOP HANGER, WALL GUARDS, 5' HOSE WITH HOSE CLAMP.
WH-1	20-GALLON POINT-OF-USE, 2.5 KW, 208/1/60
HWS-1	HAIR WASH SINK, OWNER SUPPLIED, INSTALLED BY P.C.
HT-1	HAIR TRAP
FD-1	FLOOR DRAIN WITH TRAP-GUARD
FS-1	PVC FLOOR SINK WITH TRAP GUARD
RPZ	REDUCED PRESSURE ZONE BACKFLOW PREVENTER, USC-FCCCHR LISTED, LINE-SIZED
IMB-1	ICE MAKER VALVE BOX
WHA-A	WATER HAMMER ARRESTOR – SUFFIX INDICATES PDI RATING

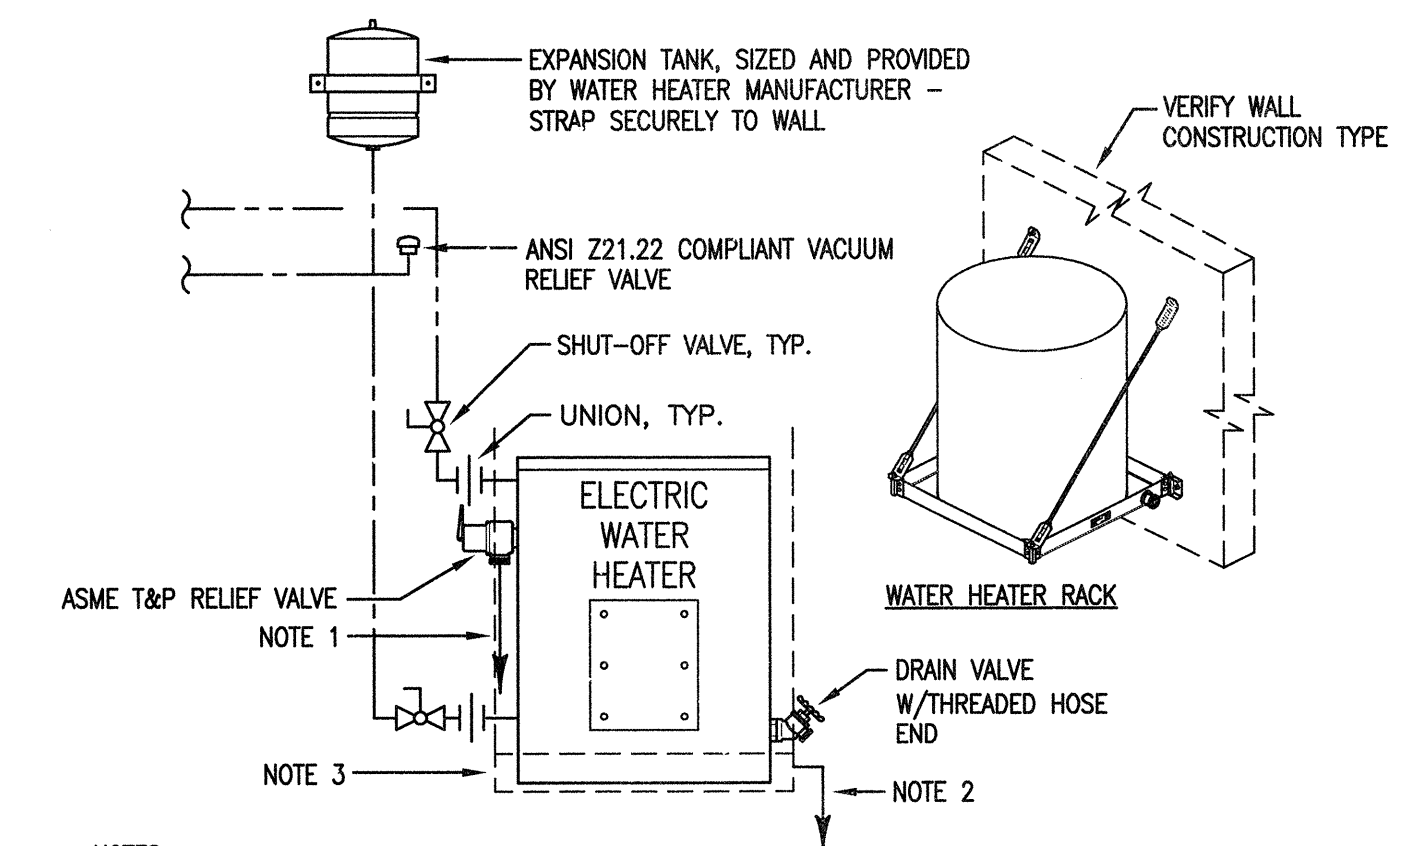

D1

WATER HEATER DETAIL

SCALE: N.T.S.

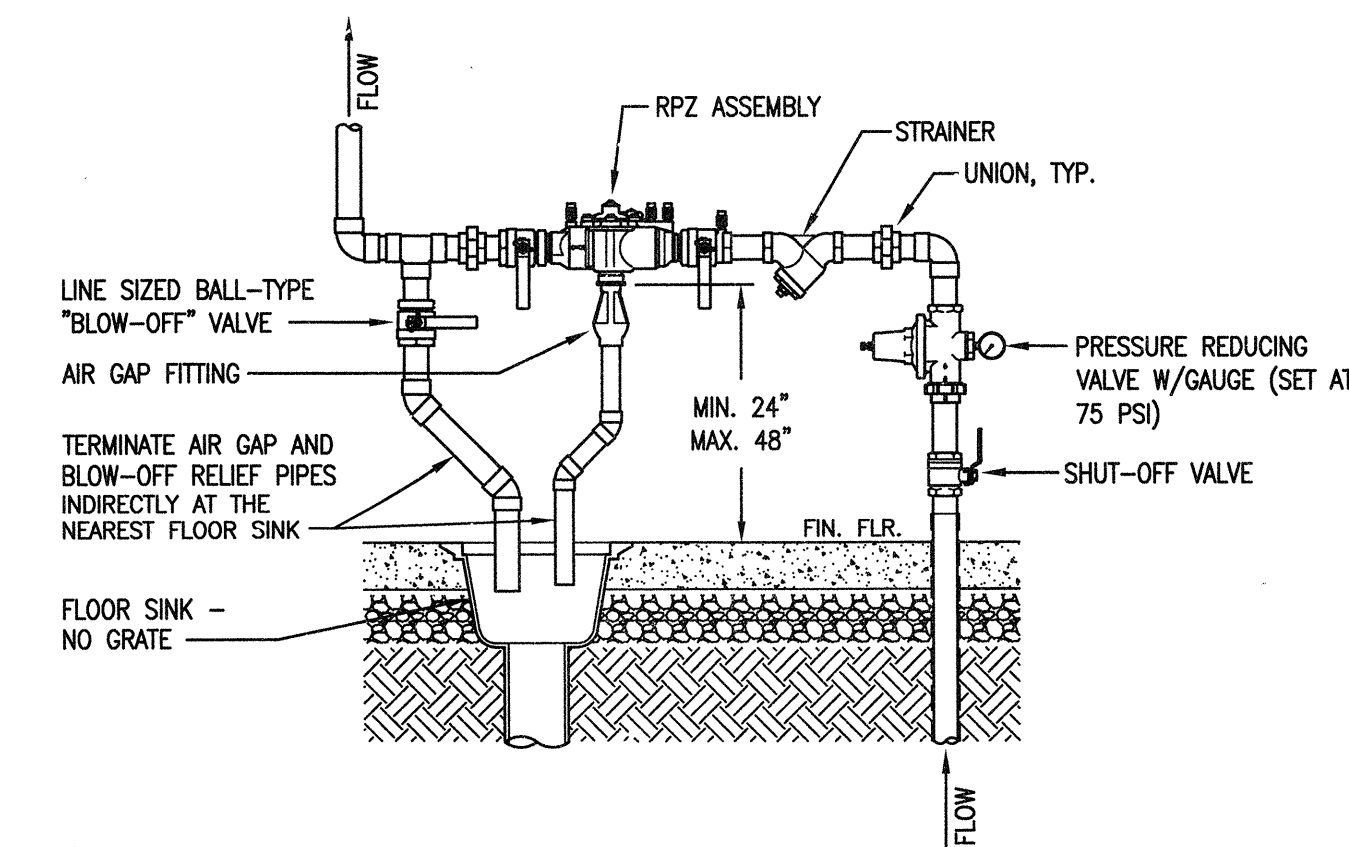


- NOTES:
- PRESSURE REDUCING VALVE IS ONLY REQUIRED WHERE WATER SERVICE PRESSURE IS GREATER THAN 75 PSI.
 - AIR GAP RELIEF AND BLOW-OFF PIPING SHALL BE ROUTE THROUGH THE NEAREST EXTERIOR WALL, TURN DOWN, AND TERMINATE.
 - THE PIPE PENETRATIONS THROUGH THE EXTERIOR WALL SHALL BE SLEEVED WITH THE ANNULAR SPACE SEALED WEATHERTIGHT AND FINISHED NEAT AND CLEAN WITH STAINLESS STEEL ESCUTCHEONS ON BOTH SIDES OF THE WALL.

D2

RPZ DETAIL

SCALE: N.T.S.

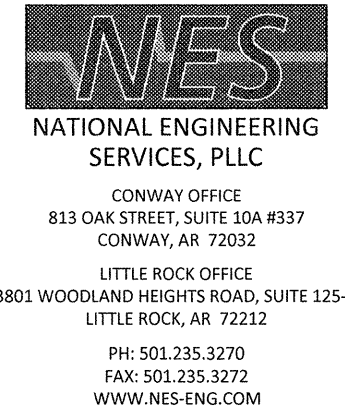

MONROW BOUTIQUE
THE VILLAGE at HENDRIX
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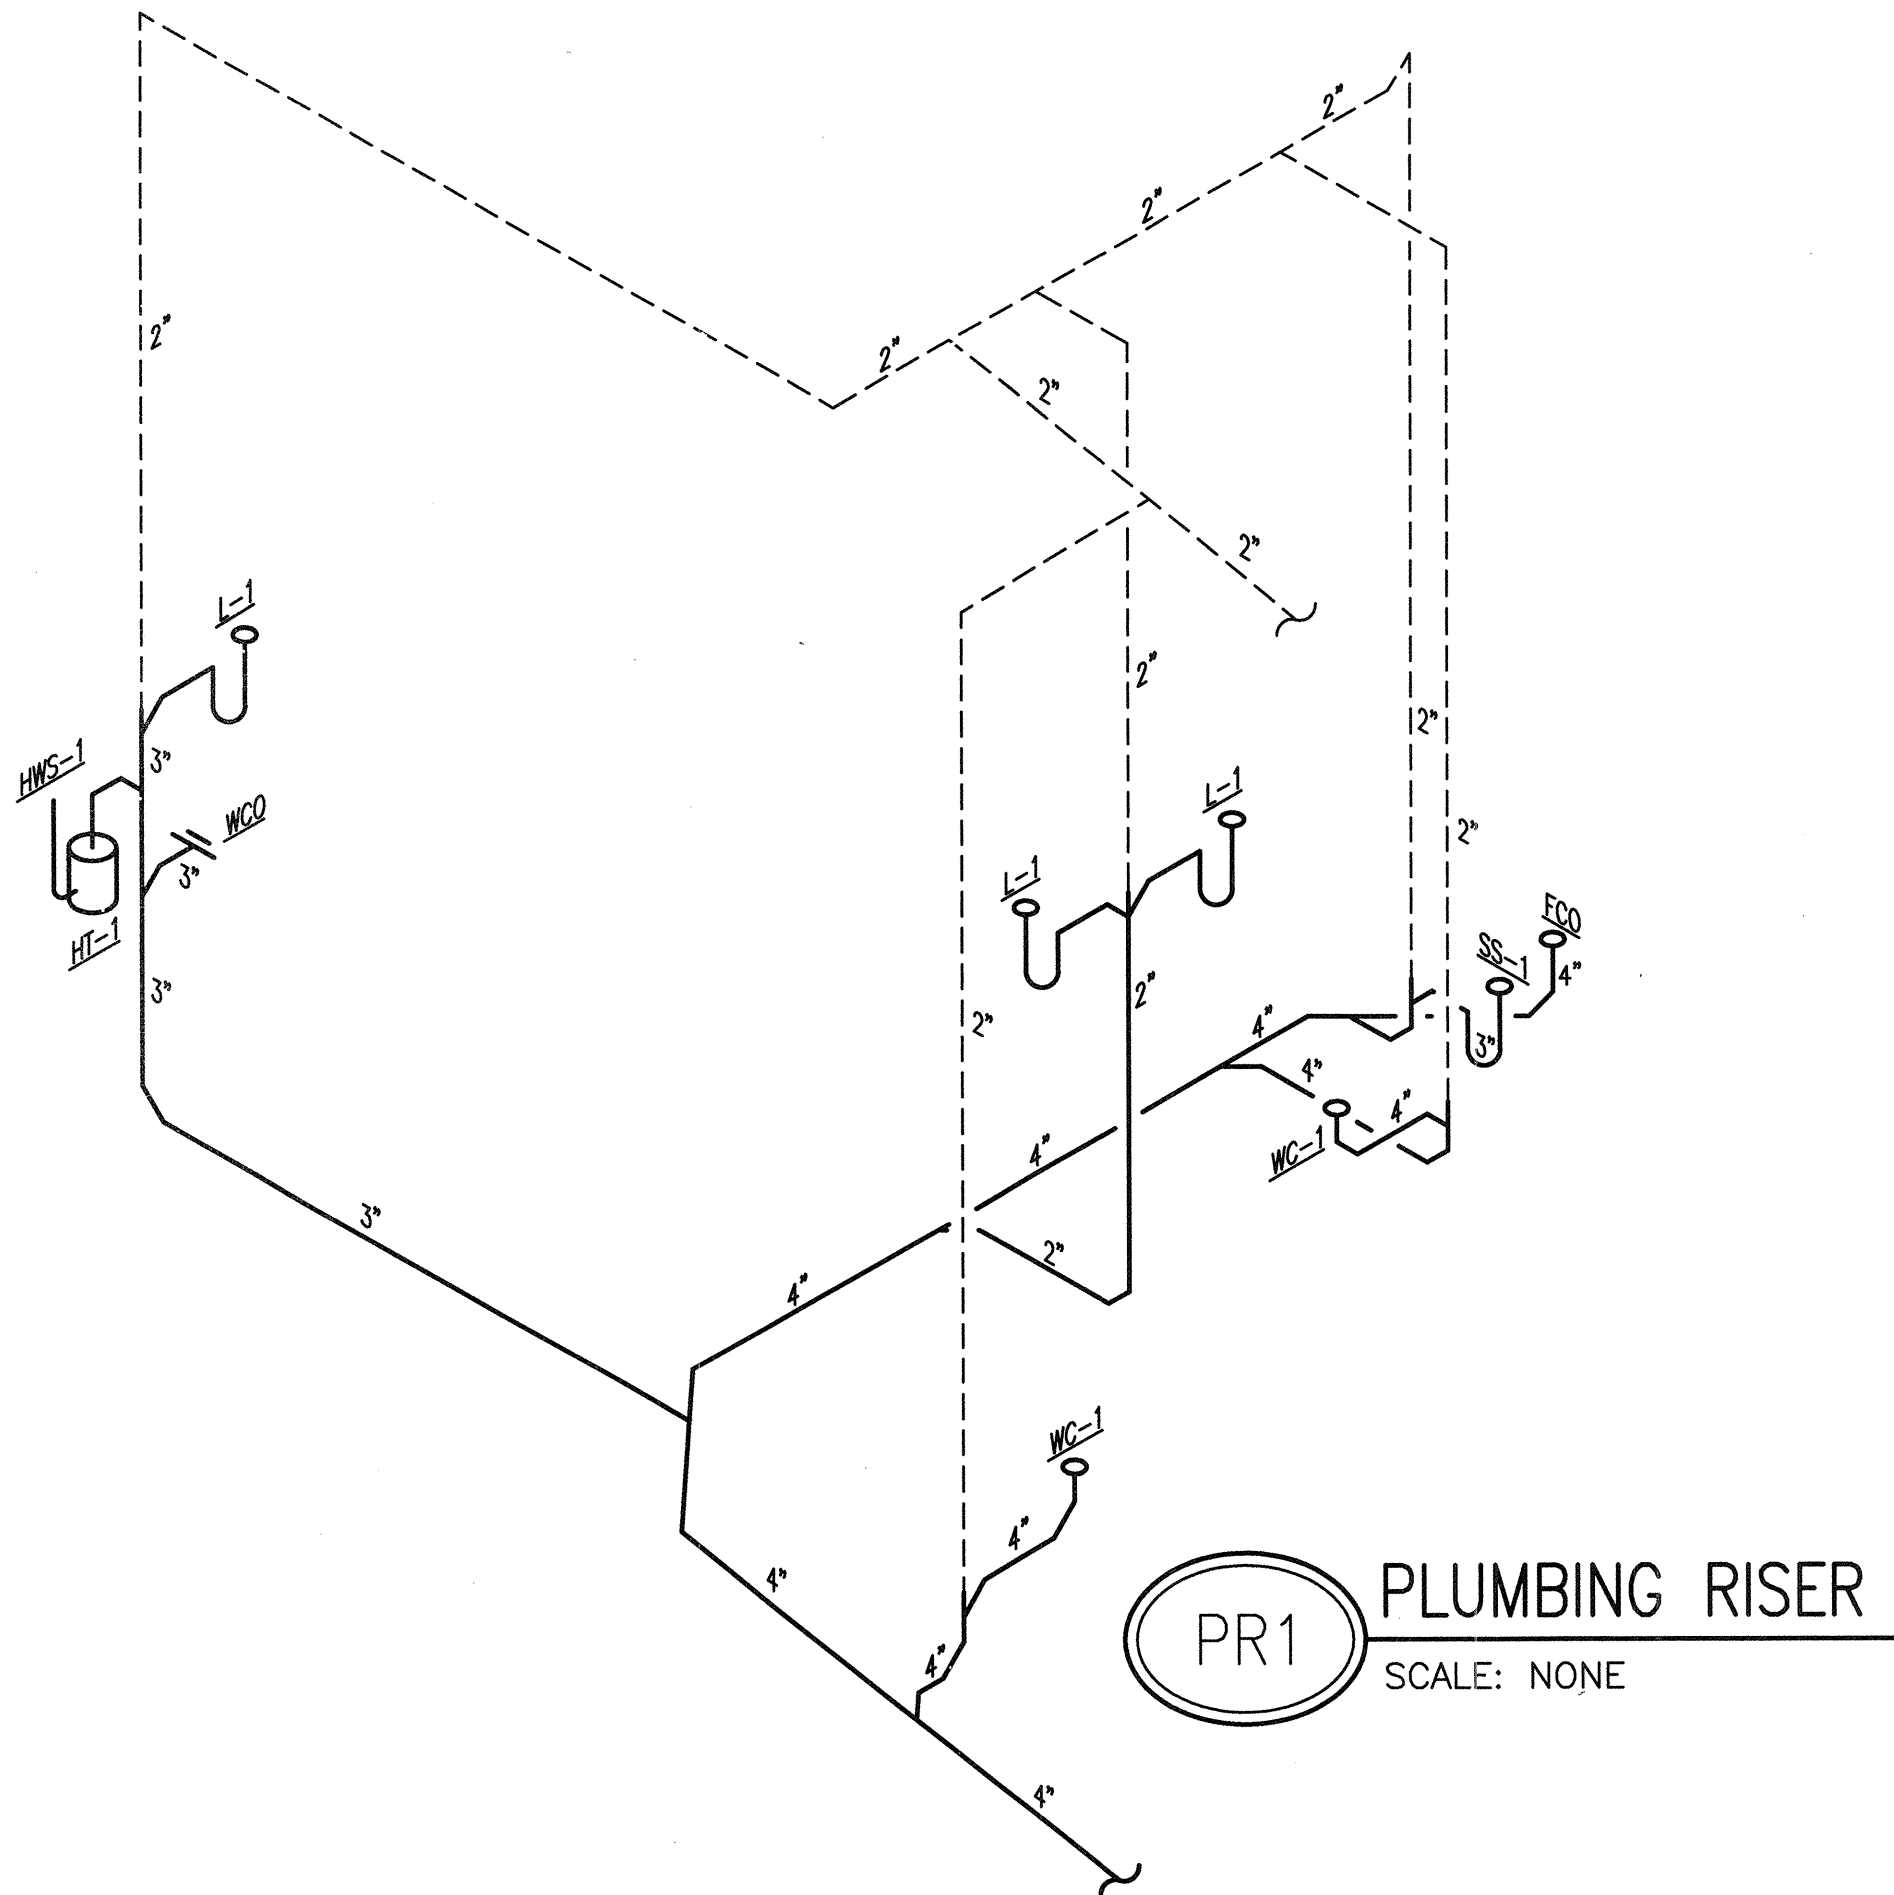
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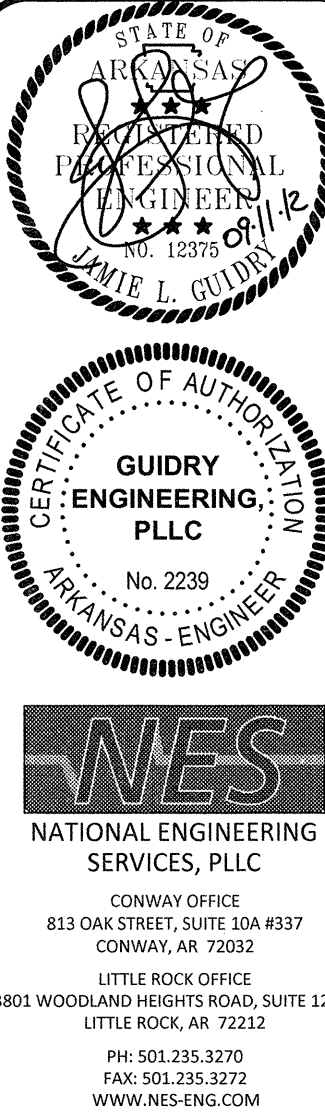


PLUMBING GENERAL NOTES

- GENERAL REQUIREMENTS:
 - UNLESS SPECIFICALLY NOTED OTHERWISE, THE TERM "CONTRACTOR" INDICATED ON ANY GIVEN DIVISION 15 PLAN SHEET SHALL REFER TO THE CONTRACTOR RESPONSIBLE FOR THE WORK OF THE SPECIFIC TRADE NOTED ON THAT PLAN SHEET.
 - ALL WORK SHALL BE PERFORMED IN ACCORDANCE WITH THE REQUIREMENTS OF THE ARKANSAS PLUMBING CODE, THE ARKANSAS FUEL GAS CODE, THE REQUIREMENTS OF ALL LOCAL UTILITIES AND THE REQUIREMENTS OF ALL LOCAL AUTHORITIES HAVING JURISDICTION, WHETHER OR NOT THE REQUIREMENTS ARE SPECIFICALLY INDICATED ON THE CONTRACT DOCUMENTS.
 - THE ENGINEERING DRAWINGS ARE DIAGRAMMATIC IN NATURE. WHILE A CONCERTED EFFORT HAS BEEN MADE TO PROVIDE SYSTEM ARRANGEMENTS AND LAYOUTS IN A NONCONFLICTIVE MANNER, THE FINAL RESPONSIBILITY FOR COORDINATION OF SYSTEM ROUTING, FABRICATION, AND INSTALLATION BETWEEN THE VARIOUS CONSTRUCTION TRADES SHALL BELONG TO THE INSTALLING CONTRACTORS. FABRICATION AND INSTALLATION OF THE VARIOUS ENGINEERING SYSTEMS SHALL NOT BEGIN UNTIL VERIFICATION OF ALL ARCHITECTURAL, STRUCTURAL, MECHANICAL, PLUMBING, FIRE PROTECTION, AND ELECTRICAL DRAWINGS HAS TAKEN PLACE.
 - THE WORK SPECIFIED HEREIN SHALL INCLUDE ALL LABOR, MATERIALS, TOOLS, EQUIPMENT, SUPPLIES AND SUPERVISION REQUIRED TO INSTALL AND PLACE IN OPERATION THE MECHANICAL SYSTEMS AND APPURTENANCES SPECIFIED HEREIN AND/OR INDICATED ON THE DRAWINGS OR REASONABLY IMPLIED AS NECESSARY FOR COMPLETION OF THE VARIOUS SYSTEMS. ALL WORK SHALL BE COMPLETED IN A NEAT AND CLEAN MANNER IN ACCORDANCE WITH CURRENT INDUSTRY STANDARDS.
 - ALL WORK SPECIFIED HEREIN SHALL BE PERFORMED BY PROPERLY LICENSED, TRAINED, AND EXPERIENCED TRADESMEN. THE CONTRACTOR SHALL PROVIDE A FIELD SUPERVISOR WITH THE AUTHORITY AND EXPERIENCE REQUIRED TO INSTRUCT THE WORK, MAKE JOB DECISIONS, AND ACT ON BEHALF OF THE CONTRACTOR IN MATTERS PERTAINING TO THE CONTRACT DOCUMENTS.
 - THE CONTRACTOR SHALL VISIT THE SITE AND VERIFY ALL EXISTING CONDITIONS PRIOR TO BID.
 - THE CONTRACTOR SHALL REMOVE ALL RESPECTIVE CONSTRUCTION WASTE AND DEBRIS FROM THE SITE AND SHALL BE RESPONSIBLE FOR THE LAWFUL DISCARD OF SUCH WASTE IN ACCORDANCE WITH ALL LOCAL, STATE, AND FEDERAL REQUIREMENTS. THE COMPLETED WORK AND THE ADJACENT AFFECTED AREAS SHALL BE THOROUGHLY CLEANED TO THE SATISFACTION ON THE OWNER, ARCHITECT, AND ENGINEER.
 - THE CONTRACTOR SHALL BE RESPONSIBLE FOR ALL CUTTING, PATCHING, AND PAINTING REQUIRED BY THE RESPECTIVE WORK. THE CONTRACTOR SHALL BE RESPONSIBLE FOR SATISFACTORILY REPAIRING EXCESSIVE, UNNECESSARY PENETRATIONS OR OVERSIZED PENETRATIONS THROUGH CONSTRUCTION. IF THE ARCHITECT/ENGINEER DEEMS NECESSARY, ANY CONSTRUCTION DAMAGED FROM CUTTING OR PENETRATION ACTIVITIES SHALL BE REMOVED AND REPLACED AT NO ADDITIONAL COST TO THE OWNER. THERE SHALL BE NO CUTTING OR PENETRATING OF CONSTRUCTION THAT WILL COMPROMISE THE STRUCTURAL INTEGRITY OF THE BUILDING SYSTEM. IF THE CONTRACTOR DEEMS IT NECESSARY TO ALTER, CUT, OR PENETRATE A STRUCTURAL MEMBER, EXPRESS PERMISSION SHALL BE GIVEN BY THE STRUCTURAL ENGINEER PRIOR TO PROCEEDING. IT IS PERMISSIBLE FOR BEAMS TO BE PENETRATED WITH SMALL SCREWS WITHOUT PRIOR APPROVAL.
- WALL PENETRATIONS:
 - STAINLESS STEEL PIPE ESCUTCHEONS SHALL BE PROVIDED AT ALL INTERIOR, EXPOSED PIPE PENETRATIONS THROUGH WALLS. ESCUTCHEONS SHALL BE SECURED TIGHT TO WALL SURFACES.
 - ALL PIPING PENETRATIONS THROUGH EXTERIOR WALLS SHALL BE SLEEVED. THE INTERSTITIAL SPACE BETWEEN THE SLEEVE AND THE PIPE SHALL BE CAULKED/SEALED WEATHERTIGHT. STAINLESS STEEL ESCUTCHEONS SHALL BE PROVIDED ON BOTH SIDES OF THE SLEEVE FOR A NEAT AND CLEAN FINISH.
 - ALL PENETRATIONS THROUGH FIRE/SMOKE RATED CONSTRUCTION SHAL BE SEALED UTILIZING U.L. LISTED MATERIALS AND DESIGNS TO MAINTAIN FIRE-RATINGS. U.L. LISTED DESIGNS FOR EACH PENETRATION TYPE UTILIZED BY THE CONTRACTOR SHALL BE SUBMITTED TO THE ARCHITECT AND ENGINEER FOR APPROVAL.
- DUE TO THE SMALL SCALE OF THE PLANS, IT IS NOT ALWAYS POSSIBLE TO INCLUDE ALL PLUMBING LINE SIZES ON THE PLANS. REFER TO THE PLUMBING RISERS, DETAILS AND NOTES FOR ALL LINE SIZES NOT INDICATED ON THE PLUMBING PLANS.
- THE CONTRACTOR SHALL COORDINATE AS REQUIRED TO ENSURE NO WATER LINES PASS OVER ELECTRICAL EQUIPMENT INCLUDING, BUT NOT LIMITED TO, POWER PANELS, FIRE ALARM CONTROL PANELS, TRANSFORMERS, AND PHONE/DATA BOARDS.
- PROVIDE AN ACCESS DOOR FOR ALL VALVES INSTALLED BEHIND WALLS OR IN OTHER INACCESSIBLE CONSTRUCTION. ACCESS DOORS EXPOSED TO VIEW SHALL BE PAINTED TO MATCH THE ADJACENT SURFACE.
- ALL PIPING SYSTEMS SHALL BE PROTECTED AGAINST DISSIMILAR METAL GALVANIC CORROSION BY SEPARATION, INSULATION, OR ENGINEERED CONNECTIONS SUCH AS DIELECTRIC UNIONS.
- PIPE INSULATION SHALL BE CONTINUOUS AND UNBROKEN THROUGH ALL HANGERS, SUPPORTS, WALL PENETRATIONS, ETC.
- PROVIDE SHUT-OFF VALVE ON ALL WATER BRANCH LINES SERVING INDIVIDUAL FIXTURES. VALVES SHALL BE INSTALLED IN AN ACCESSIBLE LOCATION.
- PROJECT DOCUMENTATION: THE CONTRACTOR SHALL PROVIDE A WRITTEN ONE (1) YEAR WARRANTY TO KEEP ALL WORK EMBRACED IN THESE CONTRACT DOCUMENTS IN REPAIR AND PROPER WORKING ORDER, WITHOUT CHARGE, FOR A PERIOD OF ONE (1) YEAR FROM DATE OF FINAL ACCEPTANCE OF THE WORK BY THE OWNER.
- PLUMBING SYSTEMS TESTING:
 - POTABLE WATER PIPING TEST THE WATER PIPING SYSTEM SHALL BE HYDROSTATICALLY TESTED AT 100 PSI FOR A PERIOD OF NOT LESS THAN EIGHT (8) HOURS WITH NO DISCERNIBLE PRESSURE LOSS.
 - SANITARY BUILDING DRAIN TEST: THE SANITARY BUILDING DRAIN SHALL BE HYDROSTATICALLY TESTED AT 5 PSI FOR ONE HOUR WITH NO DISCERNIBLE PRESSURE LOSS.
- POTABLE WATER SYSTEM CLEANING:
 - PROVIDE WATER DISINFECTION SAMPLING AND TESTING IN ACCORDANCE WITH THE REQUIREMENTS OF THE ARKANSAS DEPARTMENT OF HEALTH.
 - THE WATER DISTRIBUTION SYSTEM SHALL BE DISINFECTED IN ONE OF THE FOLLOWING TWO WAYS:
 - THE SYSTEM SHALL BE FILLED WITH A SOLUTION CONTAINING 50 PARTS PER MILLION OF AVAILABLE CHLORINE. THE SOLUTION SHALL BE ALLOWED TO STAND TWENTY-FOUR (24) HOURS BEFORE FLUSHING AND RETURNING TO SERVICE.
 - THE SYSTEM SHALL BE FILLED WITH A SOLUTION CONTAINING 200 PARTS PER MILLION OF AVAILABLE CHLORINE. THE SOLUTION SHALL BE ALLOWED TO STAND THREE (3) HOURS BEFORE FLUSHING AND RETURNING TO SERVICE.
 - DURING STERILIZATION OPERATE ALL VALVES, FAUCETS, ETC., SO THAT ALL PORTIONS OF THE SYSTEM ARE REACHED. FLUSH SYSTEM WITH CLEAR CITY WATER UNTIL CONCENTRATION DROPS TO 0.5 PPM. OBTAIN BACTERIOLOGICAL CERTIFICATE FROM THE ARKANSAS DEPARTMENT OF HEALTH OR AN AUTHORIZED REPRESENTATIVE FOR WATER SAMPLE AND SUBMIT WITH FINAL DOCUMENTS AT COMPLETION.

PLUMBING MATERIAL SPECIFICATIONS

- THE STANDARD OF QUALITY FOR ALL PLUMBING FIXTURES PROVIDED SHALL BE AS ESTABLISHED BY THE BASIS OF DESIGN INDICATED FOR EACH FIXTURE. THE MATERIAL, MANUFACTURING, AND PERFORMANCE SPECIFICATIONS OF THE SPECIFIC MANUFACTURER AND MODEL NOTED FOR EACH FIXTURE SCHEDULED SHALL ESTABLISH THE MINIMUM ACCEPTABLE STANDARD OF QUALITY, PERFORMANCE, AND WORKMANSHIP. ALTERNATE PRODUCTS SHALL MEET OR EXCEED THE BASIS OF DESIGN.
- DOMESTIC COLD AND HOT WATER PIPING:
 - BELOW SLAB: ASTM B88 TYPE "K" ANNEALED WATER TUBE WITH ANSI B16.22 WROUGHT COPPER FITTINGS. PROVIDE ASTM B32 LEAD FREE SOLDER, GRADE 95TA, 95-5 TIN-ANTIMONY. PROVIDE CONTINUOUS POLYETHYLENE OR PVC SLEEVE, BLUE FOR COLD WATER SERVICE AND RED FOR HOT WATER SERVICE.
 - ABOVE SLAB: ASTM B88 TYPE "L" HARD COPPER TUBE WITH ANSI B16.22 WROUGHT COPPER FITTINGS. PROVIDE ASTM B32 LEAD FREE SOLDER, GRADE 95TA, 95-5 TIN-ANTIMONY.
- PIPING INSULATION:
 - HOT AND COLD WATER PIPING ABOVE GRADE: MINIMUM 1" THICK ASTM C547, TYPE 1, RIGID, MOLDED FIBERGLASS INSULATION WITH FACTORY APPLIED FIBER REINFORCED KRAFT-PAPER VAPOR BARRIER. INSULATION SHALL BE EQUAL TO KMAUF 1000 OR JOHNS MANSVILLE.
 - HOT WATER PIPING BELOW GRADE: MINIMUM 3/4" THICK ASTM C534, TYPE 1 ARMACELL AP ARMAFLEX FLEXIBLE CELLULAR INSULATION.
- SANITARY AND GREASE WASTE PIPING AND FITTINGS (BELOW SLAB): ASTM D3034 SDR 35 PVC PIPE AND ASTM D2855 FITTINGS -OR- ASTM D1785 SCH. 40 PVC PIPE AND ASTM D2865 FITTINGS.
- SANITARY AND GREASE VENT PIPING AND FITTINGS (ABOVE SLAB): HUB AND SPIGOT ASTM A74 SERVICE WEIGHT CAST IRON BELOW GRADE AND HUBLESS ASTM A74 SERVICE WEIGHT CAST-IRON ABOVE GRADE WITH CISPI 301 CLAMPS.
- TRAP SEAL PROTECTION: ALL FLOOR DRAINS AND FLOOR SINKS SHALL HAVE ELASTOMERIC SELF-CLOSING TRAP GUARD PRODUCT EQUAL TO PROSET SYSTEMS TRAP GUARD.



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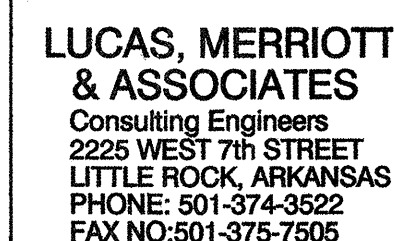
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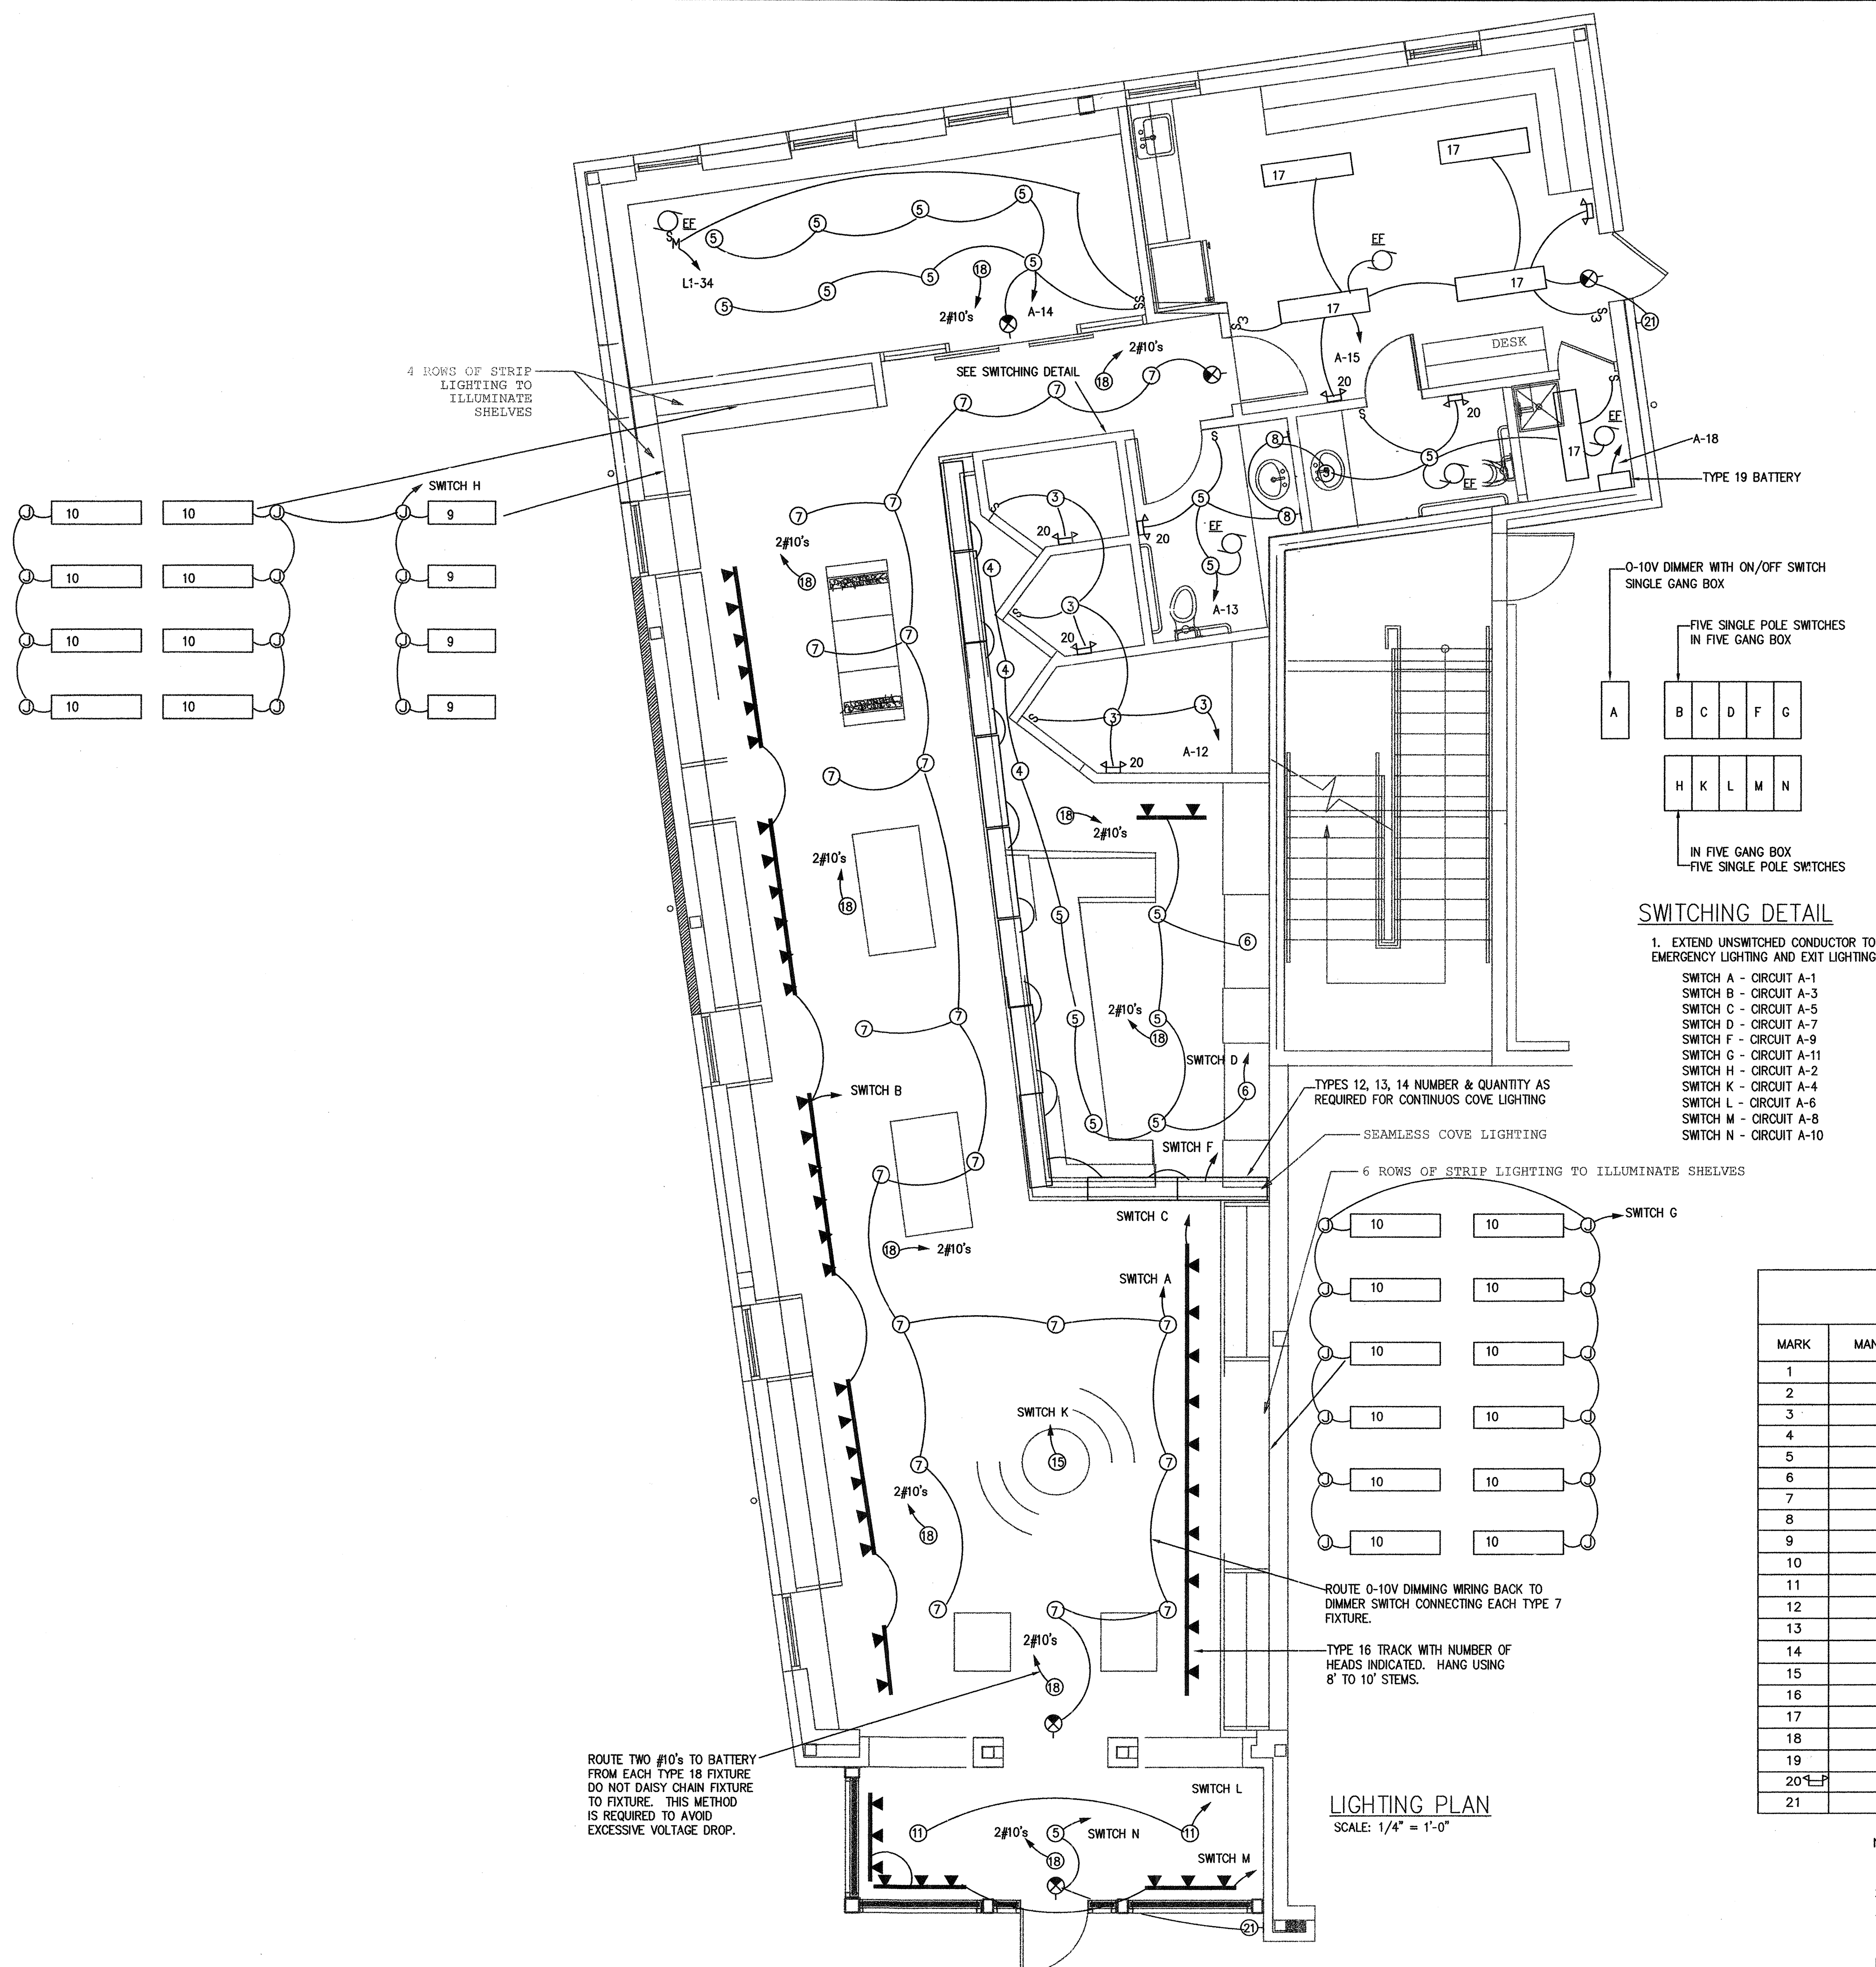


MONROW BOUTIQUE
THE VILLAGE AT HENDRIX
CONWAY, ARKANSAS



LIGHTING PLAN

REVISIONS	DATE
E1	2
SHEET	OF
9/14/12	2012-03
DATE	JOB NO.



PROGRAM START BALLAST FOR ALL

CONFIRM THE LOCATIONS OF ALL WALL MOUNTED DEVICES SUCH AS FIRE ALARM COMPONENTS SWITCHES, ETC. WITH ARCHITECT PRIOR TO ROUGH-IN.

- ⑥-----CONVENIENCE OUTLET AC= ABOVE COUNTER W.P.= WEATHERPROOF
- ⑦ TVSS RECEPTACLE
- ⑧ FLOOR TELEPHONE OUTLET - WALKERBOX - VERIFY FLOOR PLATE TYPE PROVIDE TWO 1" C'S TO ABOVE ACCESSIBLE CEILING OR AS INDICATED
 - FLOOR CONVENIENCE OUTLET- WALKERBOX- VERIFY FLOOR PLATE TYPE
- ⑨ SPECIAL PURPOSE OUTLET -(120/200V) OR AS NOTED
- ⑩ 3/4" COUPLING FLUSH WITH FLOOR, THEN CONNECT WITH EQUIPMENT AS REQUIRED, OR RECEPTACLE
- ⑪ PUSH BUTTON → BELL
- ⑫ TELEVISION OUTLET-PROVIDE RACEWAYS SAME AS FOR TELEPHONE
- ⑬ TELECOMMUNICATION OUTLET(PHONE/TELETYPE) 4X4 B/W SINGLE GANG MUDRING, PLATE AND 3/4" TO ABOVE ACCESSIBLE CEILING PROVIDE WIRING IF INDICATED
- ⑭ VIDEO DISPLAY TERMINAL-SAME AS TELEPHONE
- ⑮ FIRE ALARM HORN/STROBE 80' A.F.F.
- ⑯ FIRE ALARM SPEAKER/STROBE 80' A.F.F.
- ⑰ FIRE ALARM PULL STATION 48' A.F.F.
- ⑱ FIRE ALARM VISUAL (STROBE ONLY) 80' A.F.F.
- ⑲ SMOKE DETECTOR D=DUCT MOUNTED
- ⑳ HEAT DETECTOR
- FAP-----FIRE ALARM PANEL
- ㉑ NURSES CALL EMERGENCY STATION
- ㉒ NURSES CALL STATION (N01= SINGLE BED, 2= TWO BED, 3=STAFF)
- ㉓ NURSES CALL DOME LIGHT

- ☐ PANELS
☐ MOTOR CONNECTION-PROVIDE DISCONNECTING MEANS
☒ SPEAKER OUTLET
☒ MICROPHONE OUTLET ☒ FLOOR ☒ WALL ☒ CEILING
☒ TRANSFORMER
☒ CONDUIT ☒ CEILING OR WALL (CONCEALED)- NEUTRAL, HOT & SWITCH LEG
 CONDUCTORS NOT SHOWN WHERE OBVIOUS. PROVIDE GROUND WIRE IN ALL COND.
 --- CONDUIT ☒ UNDER FLOOR
☒ DISCONNECT SWITCH F=FUSED N=NONFUSED
☒ CONTROLLER OR STARTER
☒ CLOCK OUTLET #6 BELOW CEILING
 T.C. --- TIME CONTROL - PROVIDE 7 DAY 7/C
 P.C. --- PHOTOELECTRIC CELL
 NL. --- NIGHT LIGHT TWO LAMPS ONLY
 SM --- SQ. 'D' MANUAL STARTER TYPE FG-1 OR FG-2, CLASS 2510
 S. --- SINGLE SWITCH- SWITCH EACH ROOM INDEPENDENTLY OF OTHERS
 S₁ --- SINGLE SWITCH- TYPE FOR ALL SWITCHES
 S₂ --- FOUR-WAY SWITCH S₂ --- DOUBLE POLE SWITCH
 S₃ --- KEYED OPERATED SWITCH
 S₄ --- PILOT LIGHT / LIGHTED TOGGLE SWITCH - REFER TO SPECIFICATIONS FOR TYPE
 S₅ --- THREE-WAY SWITCH
 S₆ --- VOLUME CONTROL SWITCH OR INTERCOM CALL BUTTON - SEE RISERS.
 S₇ --- 15 MINUTE WIND UP TIMER 20 (A MARK TIME)
 S₈ --- DIMMER PRESCALITE

FIXTURE SCHEDULE

MARK	MANUFACTURE & CAT. NO.	LAMP	MOUNTING, REMARKS
1			VERIFY, EDGE LIT SINGLE FACE EXIT WITH BATTERY
2			VERIFY, EDGE LIT DOUBLE FACE EXIT WITH BATTERY
3			SURFACE, 16" ROUND 1000 LUMEN LED W/ DIFFUSED LENS
4			RECESSED, 4" 1000 LUMEN LEN W/ DROP OPAL CYLINDRICAL LENS
5			RECESSED, 6" WIDE DIST. 1500 LUMEN LED DOWNLIGHT
6			RECESSED, 6" WALL WASH 1500 LUMEN LED DOWNLIGHT
7			RECESSED, 6" MED DIST. 3000 LUMEN LED 0-10V DIMMING DOWNLIGHT
8			WALL, DECORATIVE BATHROOM SCONCE
9		T5	SURFACE, 3' SINGLE STRIP LIGHT
10		T5	SURFACE, 4' SINGLE STRIP LIGHT
11			SURFACE, OWNER FURNISHED CONTRACTOR INSTALLED CHANDELIER
12		T5	IN COVE, 2' STAGGERED STRIP LIGHT
13		T5	IN COVE, 3' STAGGERED STRIP LIGHT
14		T5	IN COVE, 4' STAGGERED STRIP LIGHT
15			SURFACE, OWNER FURNISHED CONTRACTOR INSTALLED CHANDELIER
16		50W MR16 L.V.	PENDANT, TRACK WITH HEADS
17			CHAIN HUNG, USE SHELL SPACE FIXTURES
18			RECESSED, 25W, 12V REMOTE EMERGENCY HEAD
19			SURFACE / SHELF, 340W, 12V BATTERY FOR TYPE 18 FIXTURES
20			WALL, SELF CONTAINED EMERGENCY LIGHT
21			WALL, EXTERIOR EMERGENCY LIGHT

NOTES:

1. "E" DENOTES BODINE: B 50 WIRED TO HOT SIDE OF SWITCH.
2. SUPPORT ALL LAY-IN FIXTURES BY 2 #12 TIE WIRES TO STRUCTURE.
3. VERIFY COMPATIBILITY OF ALL FIXTURES W/ MOUNTING SURFACE PRIOR TO ORDERING.
4. ALL FIXTURES 120V UNLESS SHOWN OTHERWISE
5. PROVIDE PROGRAM START BALLAST FOR ALL ROOMS WITH OCCUPANCY SENSORS