PROPOSED POND LOCATION SOUTH FRONTAGE DISTRIBUTION CENTER **BUILDING 100** 120,000 SF PROPOSED **POND LOCATION** TRACK COURT NOTE: ARCHITECTURAL SITE PLAN FOR REFERENCE ONLY. SEE CIVIL DRAWINGS FOR OFFICIAL SITE PLAN. 1 SITE PLAN
SCALE: 1" = 40'-0"





SOUTH FRONTAGE
DISTRIBUTION CENTER

**BUILDING 100** 

BILLINGS, MONTANA

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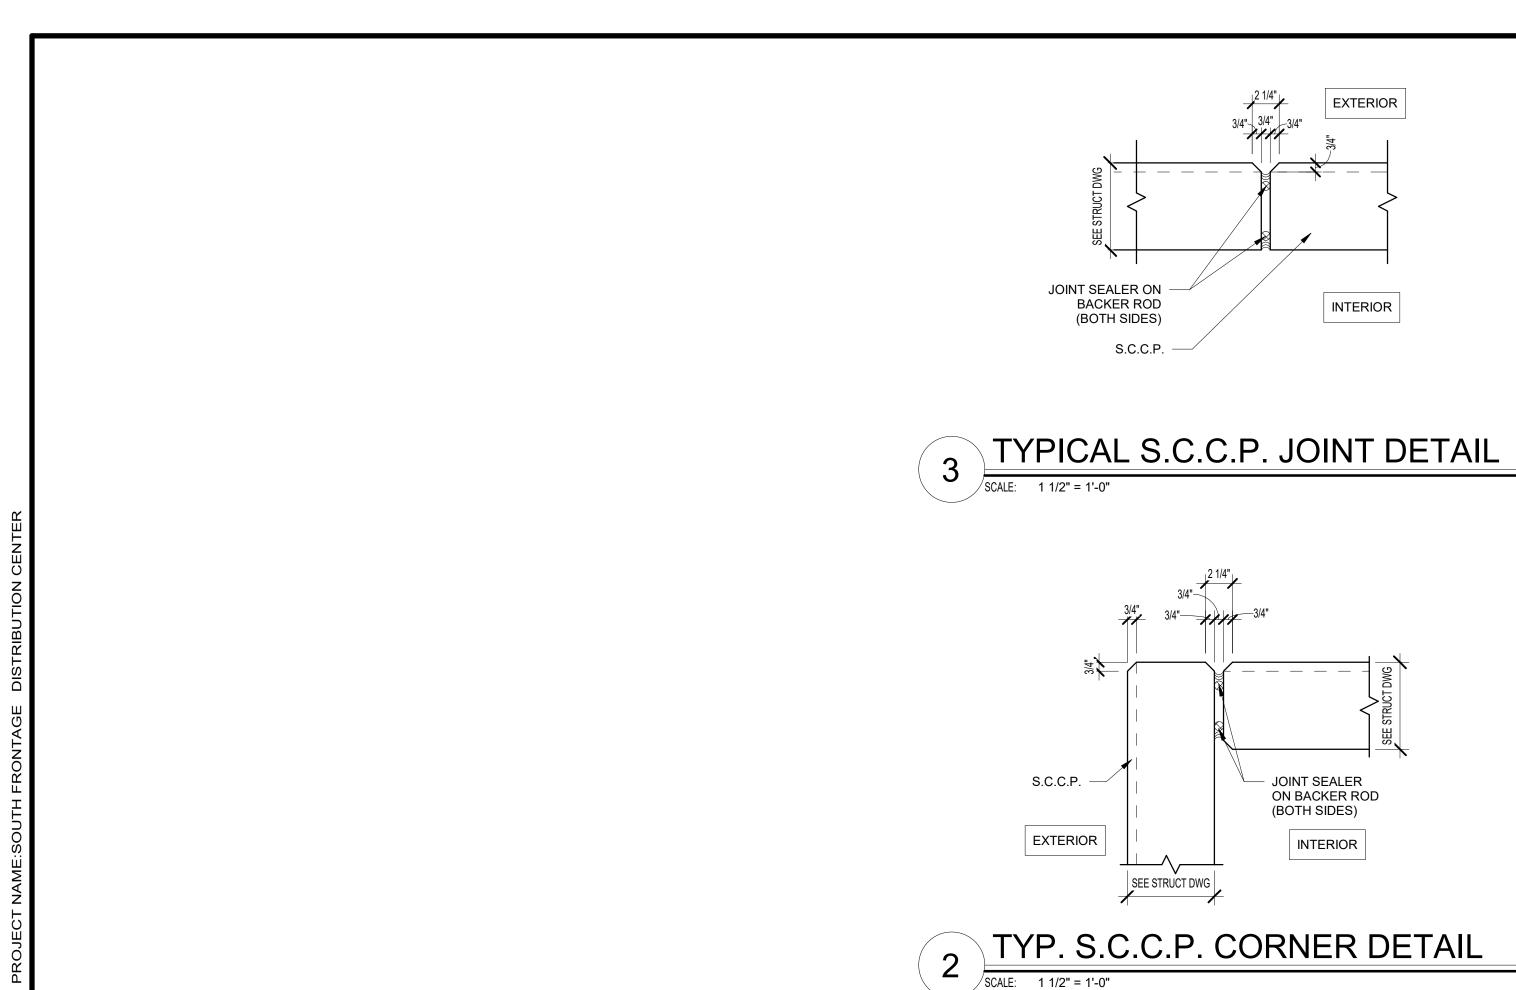
Sheet Title

ARCHITECTURAL SITE PLAN

Sheet No

A.013

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## **KEYNOTES**

- ACCESS LADDER TO CONCRETE ROOF OF ELECTRICAL ROOM SEE ENLARGED PLANS.
- 3'-0" X 3'-0" ROOF HATCH WITH ACCESS LADDER FROM CONCRETE ROOF AT ELECTRICAL ROOF BELOW. G.C. TO COORDINATE WITH STRUCTURE. PAINTED SAFETY
- YELLOW SEE ENLARGED PLANS AND ROOF PLAN.

3 FUTURE TENANT OFFICES

- 4 ELECTRICAL ROOM 1 HOUR RATED
- 5 FIRE PUMP ROOM 1 HOUR RATED

6 RAMP GUARDRAIL - SEE DETAILS 4, 12 & 13 ON A.401

- 5' X 5' CONCRETE PAD, SLOPE AWAY FROM BUILDING AT 1/4" PER FT. MAX.
- 9" X 9" 24 GAUGE METAL DOWNSPOUTS WITH KYNAR FINISH 9 RECESSED CAN LIGHT IN SOFFIT ABOVE. SEE ELECTRICAL
- 10 9' X 10' DOCK DOOR
- 11 12' X 14' DRIVE-IN RAMP DOOR

## **GENERAL NOTES**

- 1. BUILDING TO BE 32' CLEAR JUST PAST THE FIRST COLUMN LINE IN FROM THE DOCK WALL.
- 2. SLAB CONTROL JOINTS TO BE SAWCUT AND NOT TO EXCEED 15' 0" ON CENTER. SEE STRUCTURAL DRAWINGS FOR FLOOR SLAB CONTROL JOINTS. 3. SLAB CONSTRUCTION JOINTS TO HAVE SMOOTH DOWELS AT 24" O.C. OR STEEL DIAMOND PLATES - SEE STRUCTURAL DRAWINGS.
- 4. SLAB WILL BE CURED WITH A WATER-BASED DISSIPATIVE CURING COMPOUND AND WILL RECEIVE ONE COAT SONNEBORNE LAPIDOLITH FLOOR HARDENER. 5. SLAB ON GRADE WILL BE PRE-TREATED WITH TERMITICIDE.

6. 10-MIL VAPOR BARRIER TO BE PROVIDED BELOW THE SLAB ON GRADE THROUGHOUT. ALL SEAMS AND PENETRATIONS TO BE SEALED AND TAPED.

- 7. 6" THICK REINFORCED, 4,000 PSI CONCRETE SLAB BEARING ON 6" GAB. SLAB TO RECEIVE HARD TROWEL FINISH AND LASER SCREED SHALL BE UTILIZED TO ATTAIN MINIMUM LOCAL & OVERALL SLAB TOLERANCE OF FF 40/FL 30. 8. PROVIDE A ESFR SPRINKLER SYSTEM THROUGHOUT.
- 9. PROVIDE PORTABLE FIRE EXTINGUISHERS OF THE QUANTITY AND AT THE LOCATIONS AS INDICATED OR AS REQUIRED BY THE AUTHORITY HAVING JURISDICTION. EXTINGUISHERS SHALL BE EQUAL TO J.L. INDUSTRIES COSMIC 10E, 10 POUND, 4A-60BC. TO BE COORDINATED WITH OWNERS LAYOUT.
- 10. METAL ROOF DECK SHALL BE 1-1/2" TYPE "B" WIDE RIB DECKING SHOP PRIMED WHITE SEE STRUCTURAL DRAWINGS.
- 11. RACKING, FLOOR STORAGE AND EQUIPMENT BY OTHERS. 12. SEE ELEVATIONS FOR GLASS SCHEDULE.
- 13. ALL BOLLARDS TO BE PAINTED SAFETY YELLOW. (PROVIDE BOLLARDS AT ALL DRIVE-IN OVERHEAD DOOR JAMBS, FIRE PROTECTION RISERS, ELECTRICAL TRANSFORMERS AND EXPOSED
- 14. ALL BOLLARDS SHALL BE 6" O.D. SCHEDULE 80 STEEL PIPE SET MINIMUM 2'-0" DEEP IN 2'-0" DIAMETER CONCRETE FOOTING WITH PIPE EXTENDED 4'-0" ABOVE PAVING OR FLOOR. FILL PIPE WITH CONCRETE AND DOME TOP - FOOTING TO BE IN SONOTUBE.
- 15. ROOF ASSEMBLY: SINGLE PLY 45 MIL. WHITE TPO MEMBRANE SYSTEM MECHANICALLY FASTENED OVER R-35 ROOF INSULATIN OVER ENTIRE FROOF OVER 1-1/2" METAL DECK, ROOF DECK WILL BE SHOP PRIMED WHITE, INCLUDING THE EDGES.. 20-YEAR NDL WARRANTY.
- 16. ALL STAIRS AND RAILINGS TO BE GALVANIZED. ALL MISC. STEEL TO BE HD GALVANIZED FOR EXTERIOR APPLICATIONS.
- 17. ALL SITE CAST CONCRETE PANEL WIDTHS ARE TO CENTERLINE OF CONCRETE PANEL VERTICAL JOINT U.N.O.
- 18. ALL TILT WALL PANELS SHALL BE CAULKED TO FULL HEIGHT, BOTH SIDES, WITH MASTERSEAL NP-2 POLYURETHANE SEALANT OR EQUAL WITH BACKER ROD BEHIND THE CAULK. 19. (EXTERIOR) ALL S.C.C.P. SHALL RECEIVE A TEXTURED ACRYLIC COATING SIMILAR TO SHERWIN WILLIAMS ULTRACRETE (MEDIUM TEXTURE) WITH ACCENT STRIPING. SEE ELEVATIONS.
- 20. (INTERIOR) WHERE NO INSULATION S.C.C.P. PANELS WILL BE HARD TROWEL FINISHED WITH CAPPED PICK AND BRACE POINTS AND SHALL RECEIVE ONE COAT OF WHITE LATEX PAINT. 21. PERSONNEL DOORS AND MISC. METALS SHALL RECEIVE ONE (1) PRIMER COAT AND ONE (1) FINISH COAT OF ENAMEL. PROVIDE FIRE DEPARTMENT ACCESS SIGNAGE PER DETAIL 9/A.002 AT EACH

OVERALL FLOOR PLAN

- 22 INTERIOR COLUMNS TO BE PAINTED SAFETY YELLOW TO 12' A.F.F.WITH RED STRIPE ABOVE YELLOW, WHERE FIRE EXTINGUISHERS 23 STEEL GUARDS TO BE PROVIDED AT ALL OVERHEAD DOORS.
- 24 INTERIOR WALLS TO RECEIVE R-19 RIGID INSULATION ENTIRE WALLS ALL WALLS OTHER THAN DOCK WALL WHERE INSULATION WILL BE FROM 10'0" A.F.F. TO DECK



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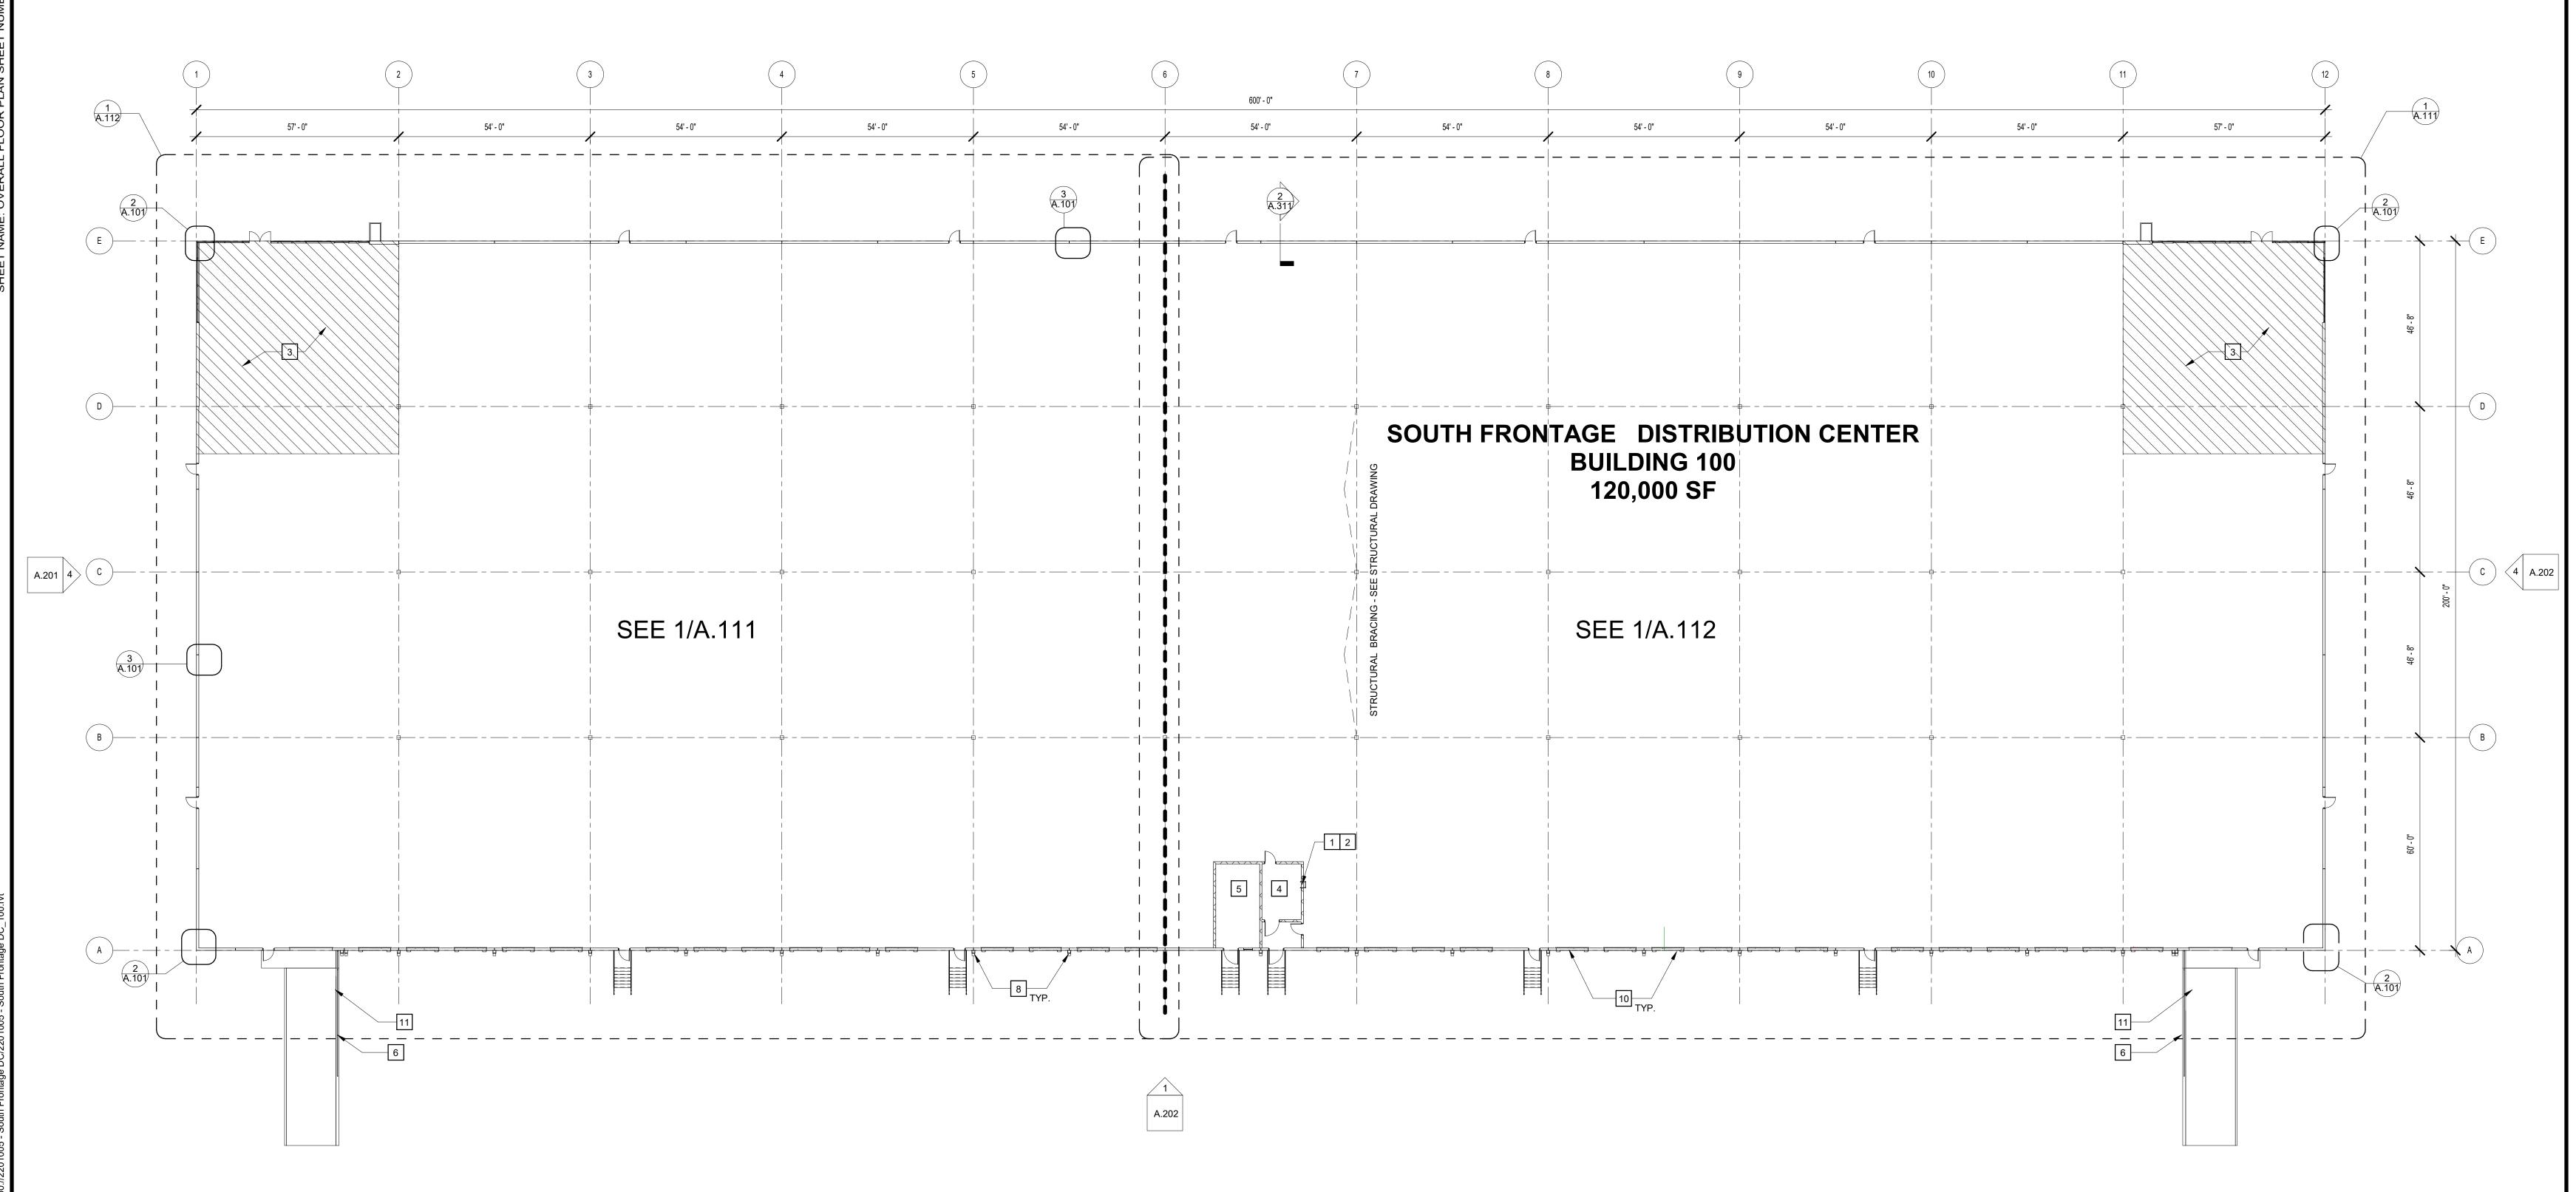
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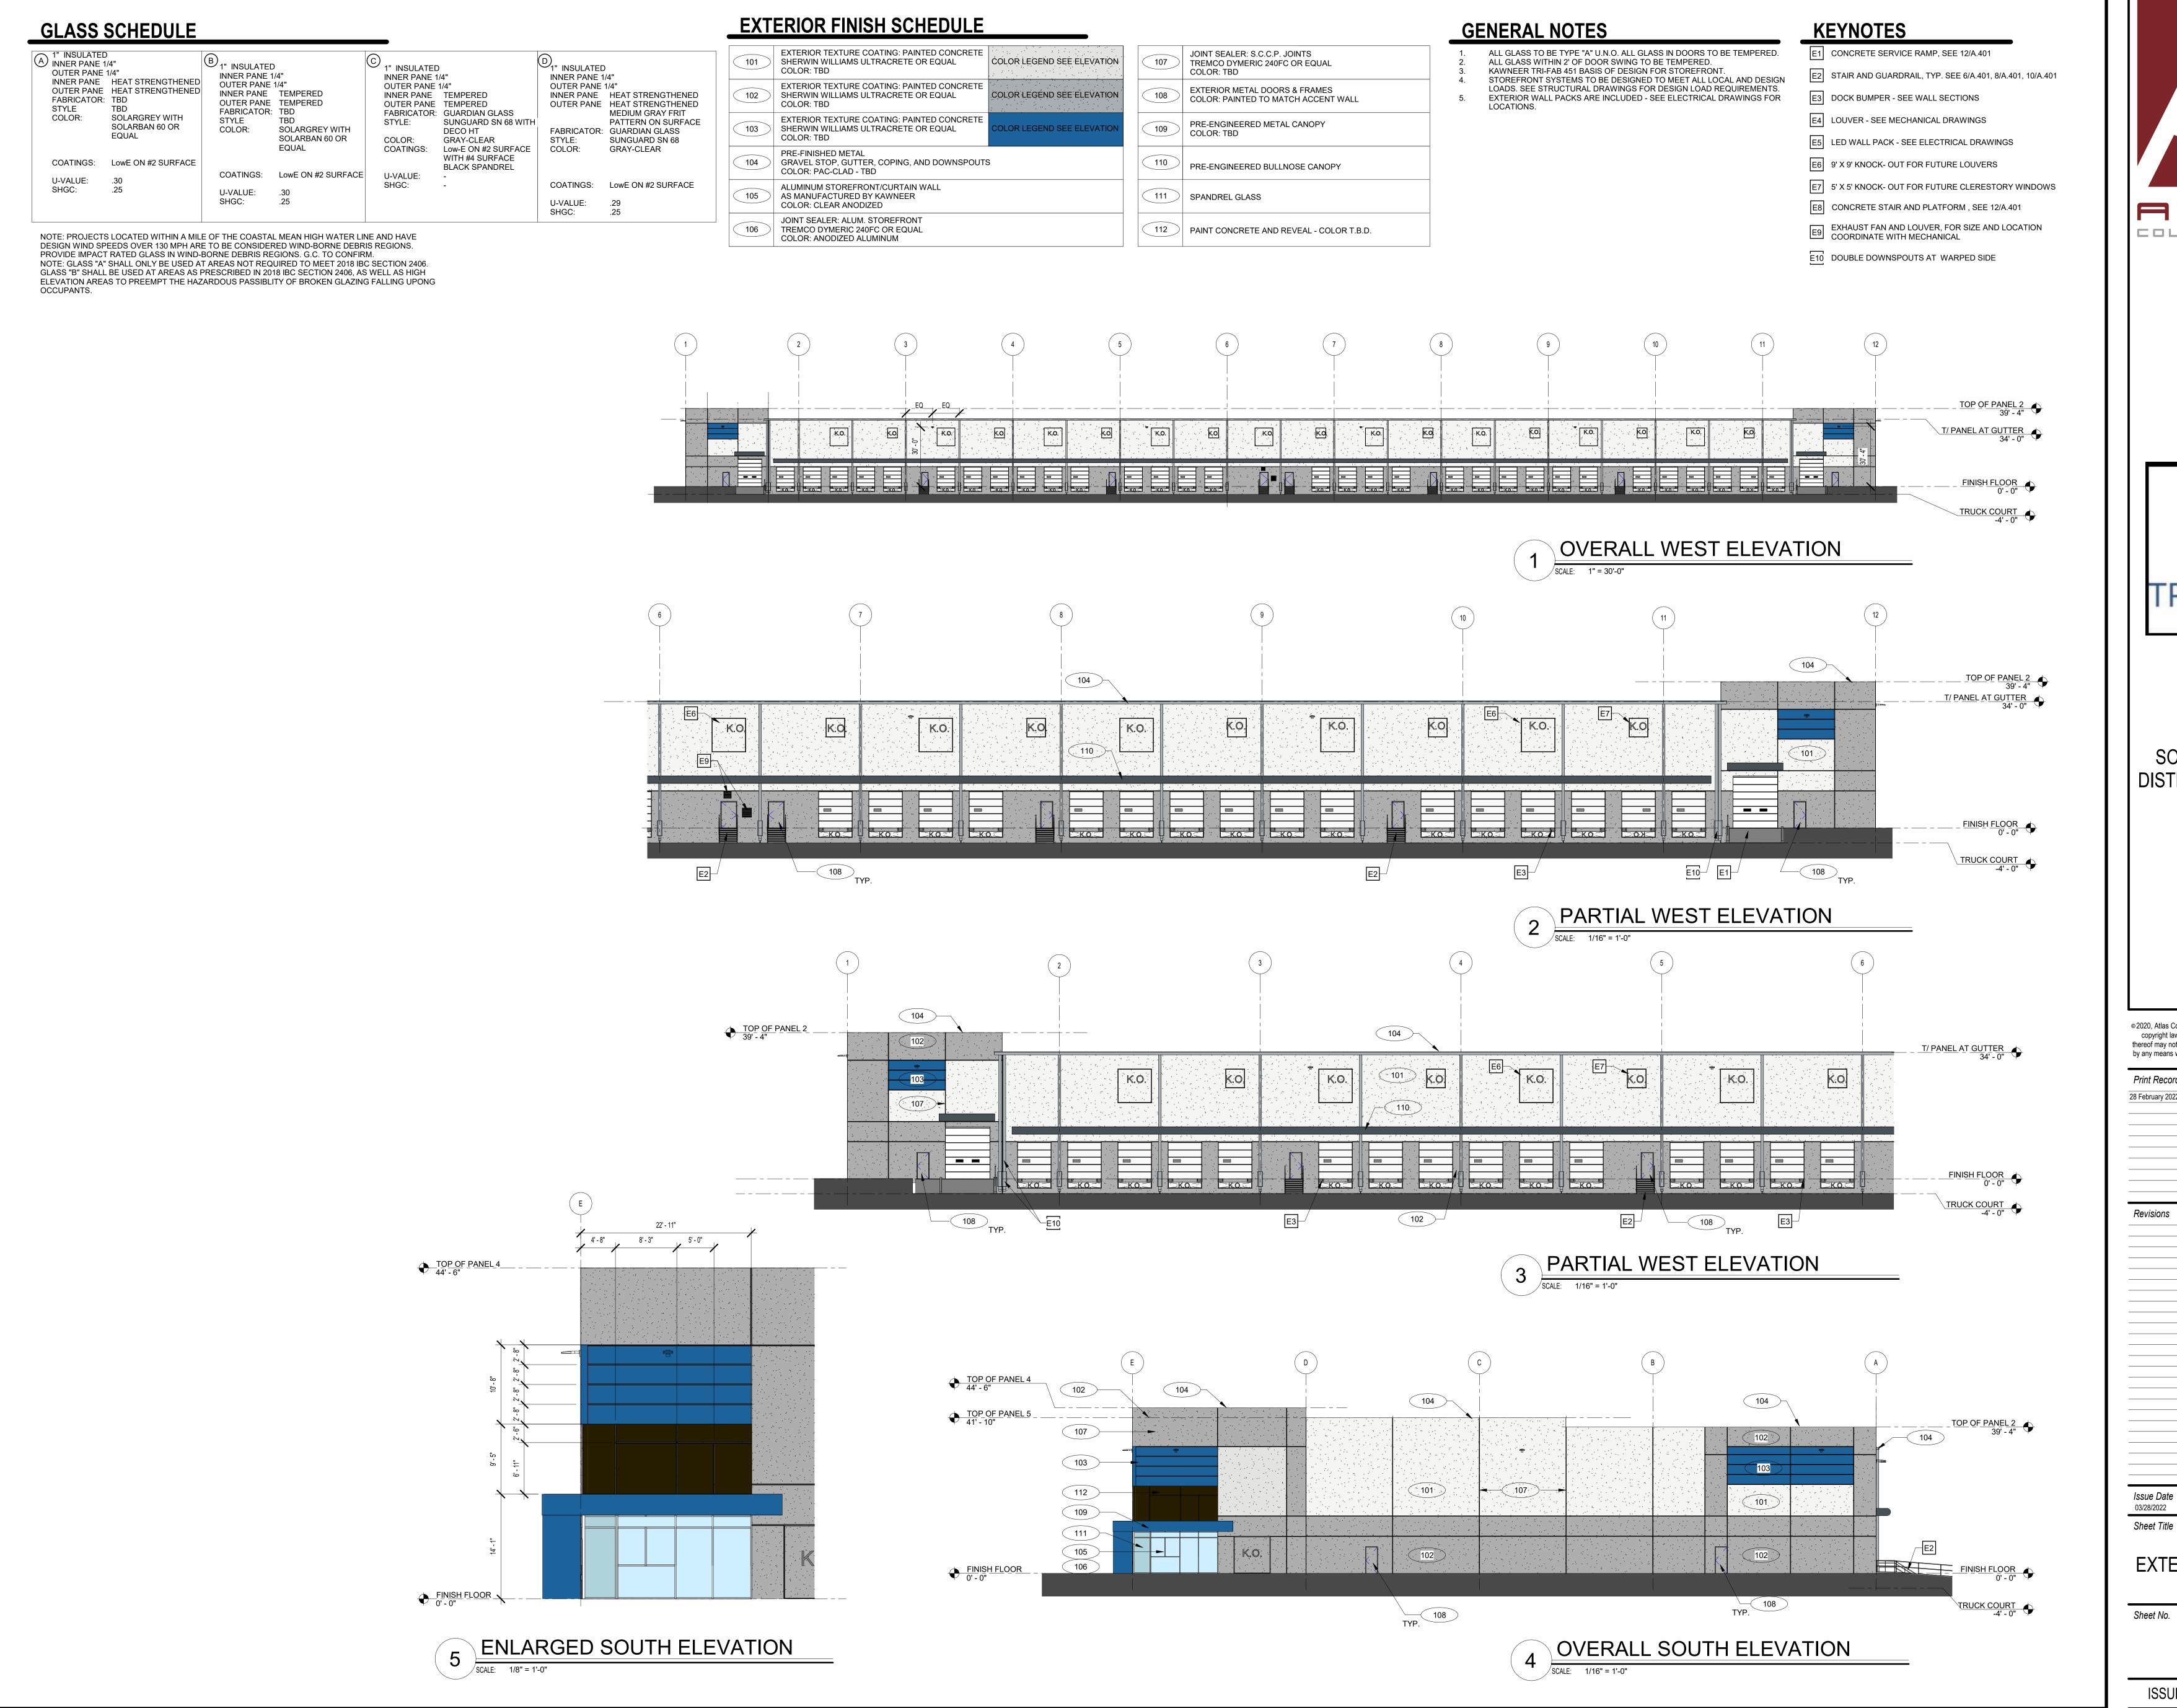
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OVERALL FLOOR PLAN

A.101

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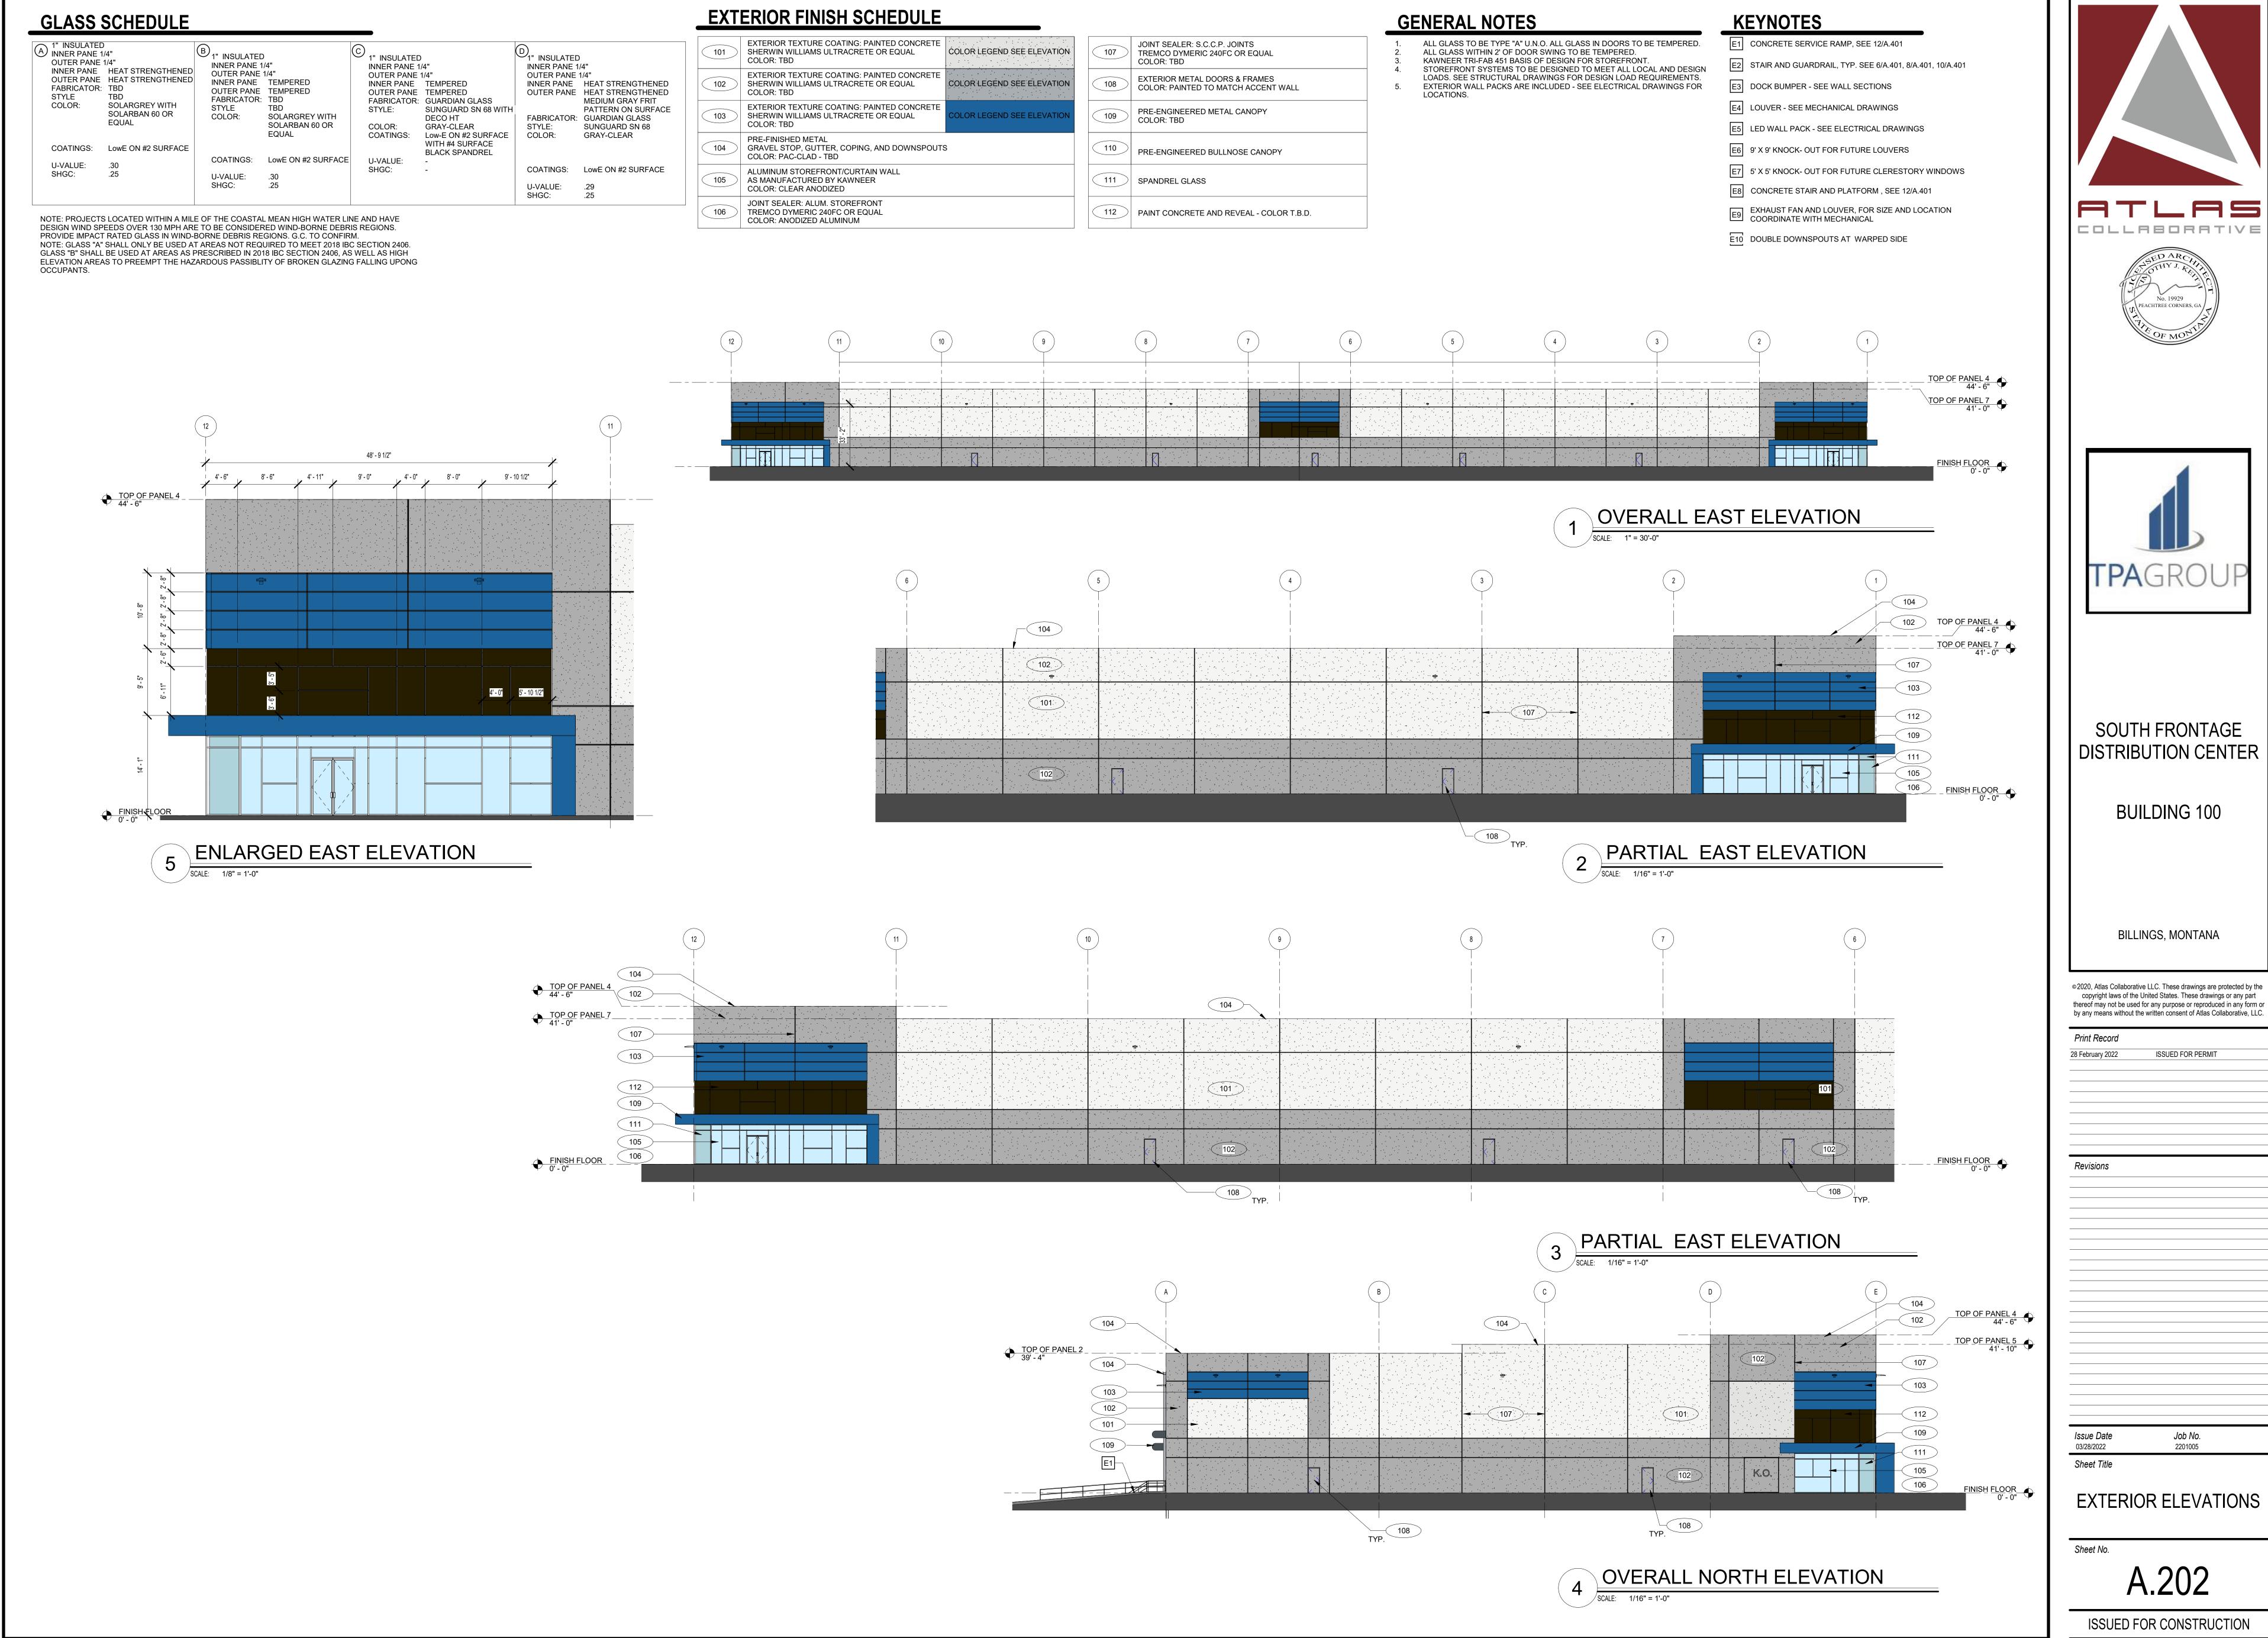
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EXTERIOR ELEVATIONS

A.201

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