



TOP SLAB

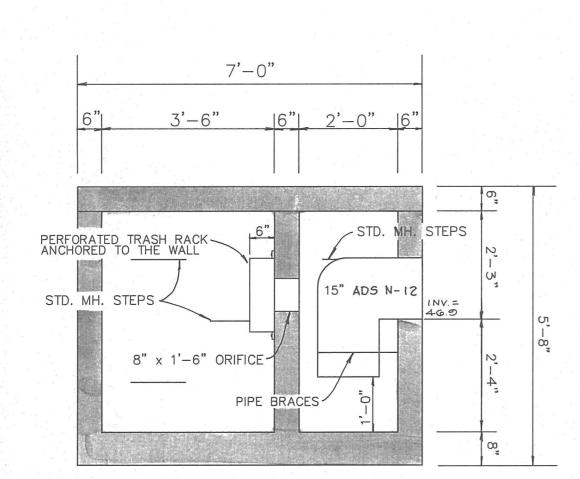

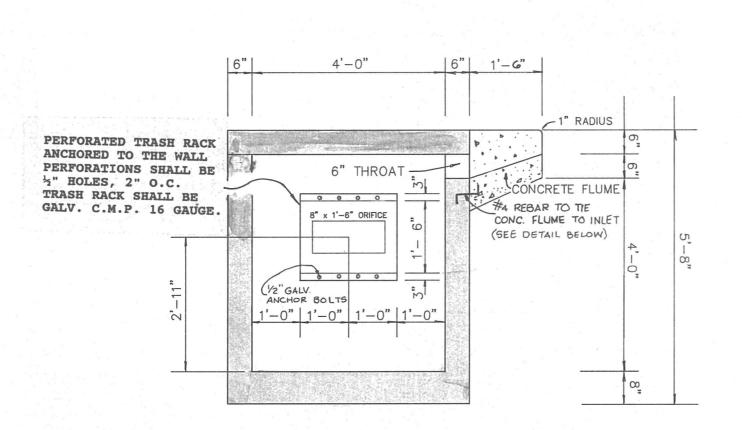

SECTION A-A

• ALL CONCRETE SHALL BE SHA MIX NO.3 • MANUFACTURER OF WATER QUALITY INLET

• SHOP DRAWINGS SHALL BE APPROVED BY

CONSIDERED MINIMUM FOR MANUFACTURER

• WALL THICKNESSES SHOWN ARE TO BE


ATION.

SPECIFICATIONS.

IS TO SPECIFY ALL STEEL REINFORCEMENT.


REGISTERED ENGINEER PRIOR TO INSTALL-

SECTION B-B

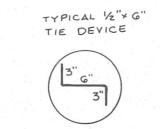


PRECAST



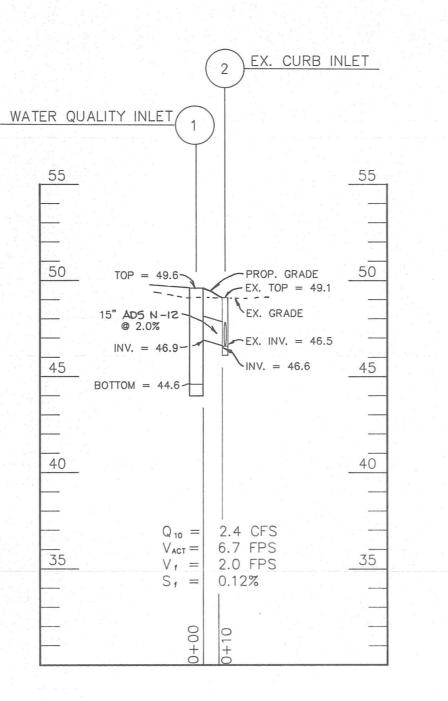

NOTE: PROVIDE WATERTIGHT SEAL CONNECTION WITH NON-SHRINK GROUT AT JUNCTION WITH EX. INLET

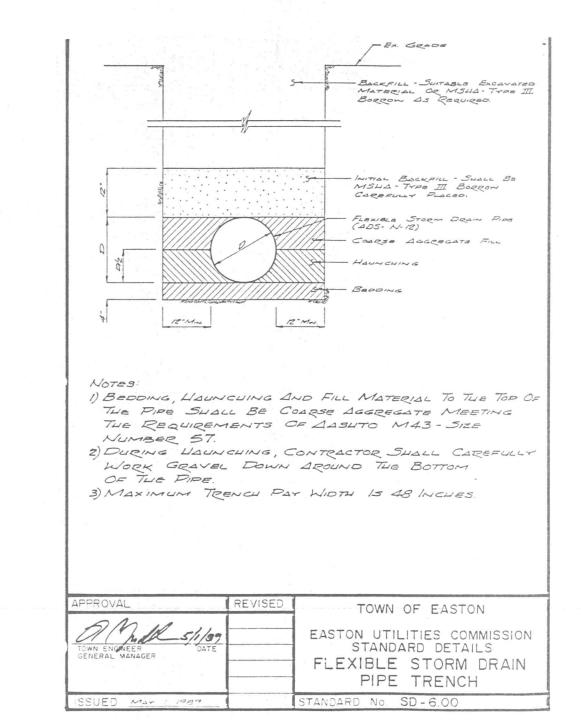



STORM DRAIN PROFILE SCALE: HORZ. 1" = 50' VERT. 1" = 5"

STORM DRAIN COMPUTATION CHART

PROJECT: ST. MICHAEL'S BANK COMP .: PAO DATE: 11-16-93 CHECKED: DEP SHEET # / OF /

1 2 15 ADS N-12 038 038 090 034 034 5

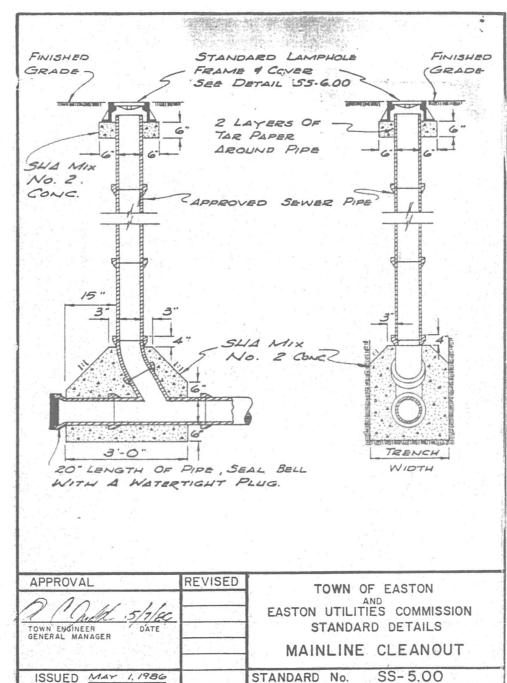

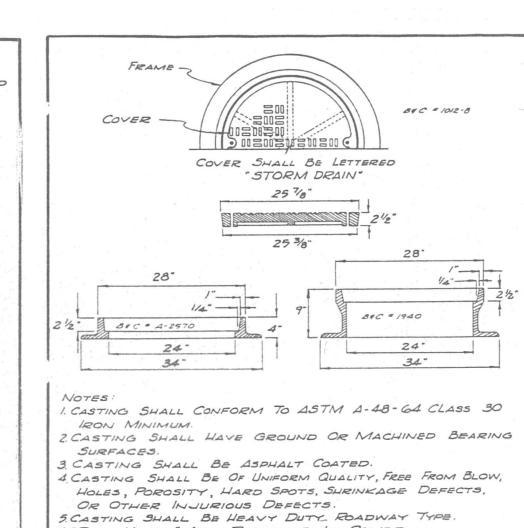

"PICK HOLES" ARE REQUIRED IN COVER. 7. FRAMES & COVER SHALL BE AS INDICATED AND AS SUPPLIED BY BAC UTILITY SUPPLY INC., FINKSBURG, MO, OR AN APPROVED EQUAL.

APPROVAL	REVISED	TOWN OF EASTON
TOWN ENGINEER DATE GENERAL MANAGER		AND
	-	EASTON UTILITIES COMMISSION STANDARD DETAILS
		MANHOLE FRAME & COVER
ISSUED MAY 1, 1986	2.5	STANDARD No. SD-5.00


1551 RAINBOW PLAZA

CHESTER, MARYLAND 21619

PHONE (410) 643-3612

FAX (410) 643-5102

SUITE 2C

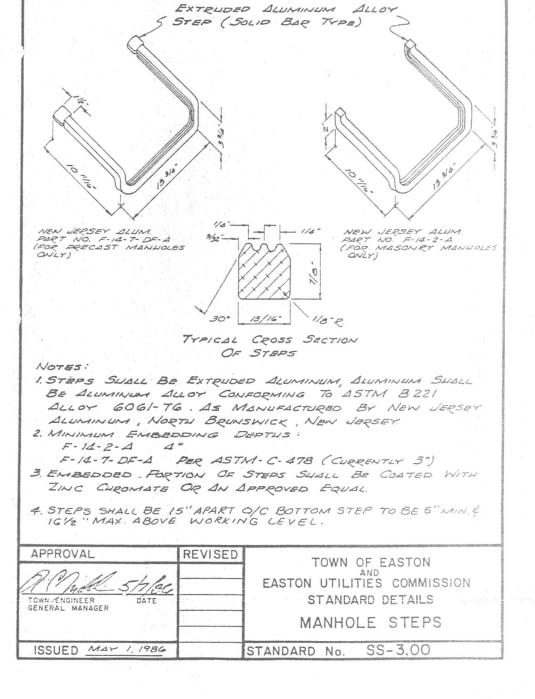



LANDFORM-TECHNICAL STORM DRAIN PROFILES AND DETAILS SERVICES, INC. ENGINEERS, SURVEYORS, LAND PLANNERS POST OFFICE BOX 317

POST OFFICE BOX 608 157 EAST MAIN STREET ELKTON, MARYLAND 21922 PHONE (410) 392-4462


FAX (410) 392-6916

ST. MICHAEL'S BANK

TOWN OF EASTON SCALE 1" = 20' TALBOT COUNTY MARYLAND

DESIGN: PAO AUGUST, 1993 DRAWN: PAO JOB NO: GARD 01-04 SHEET 3 OF 3 CHECKED: DEP



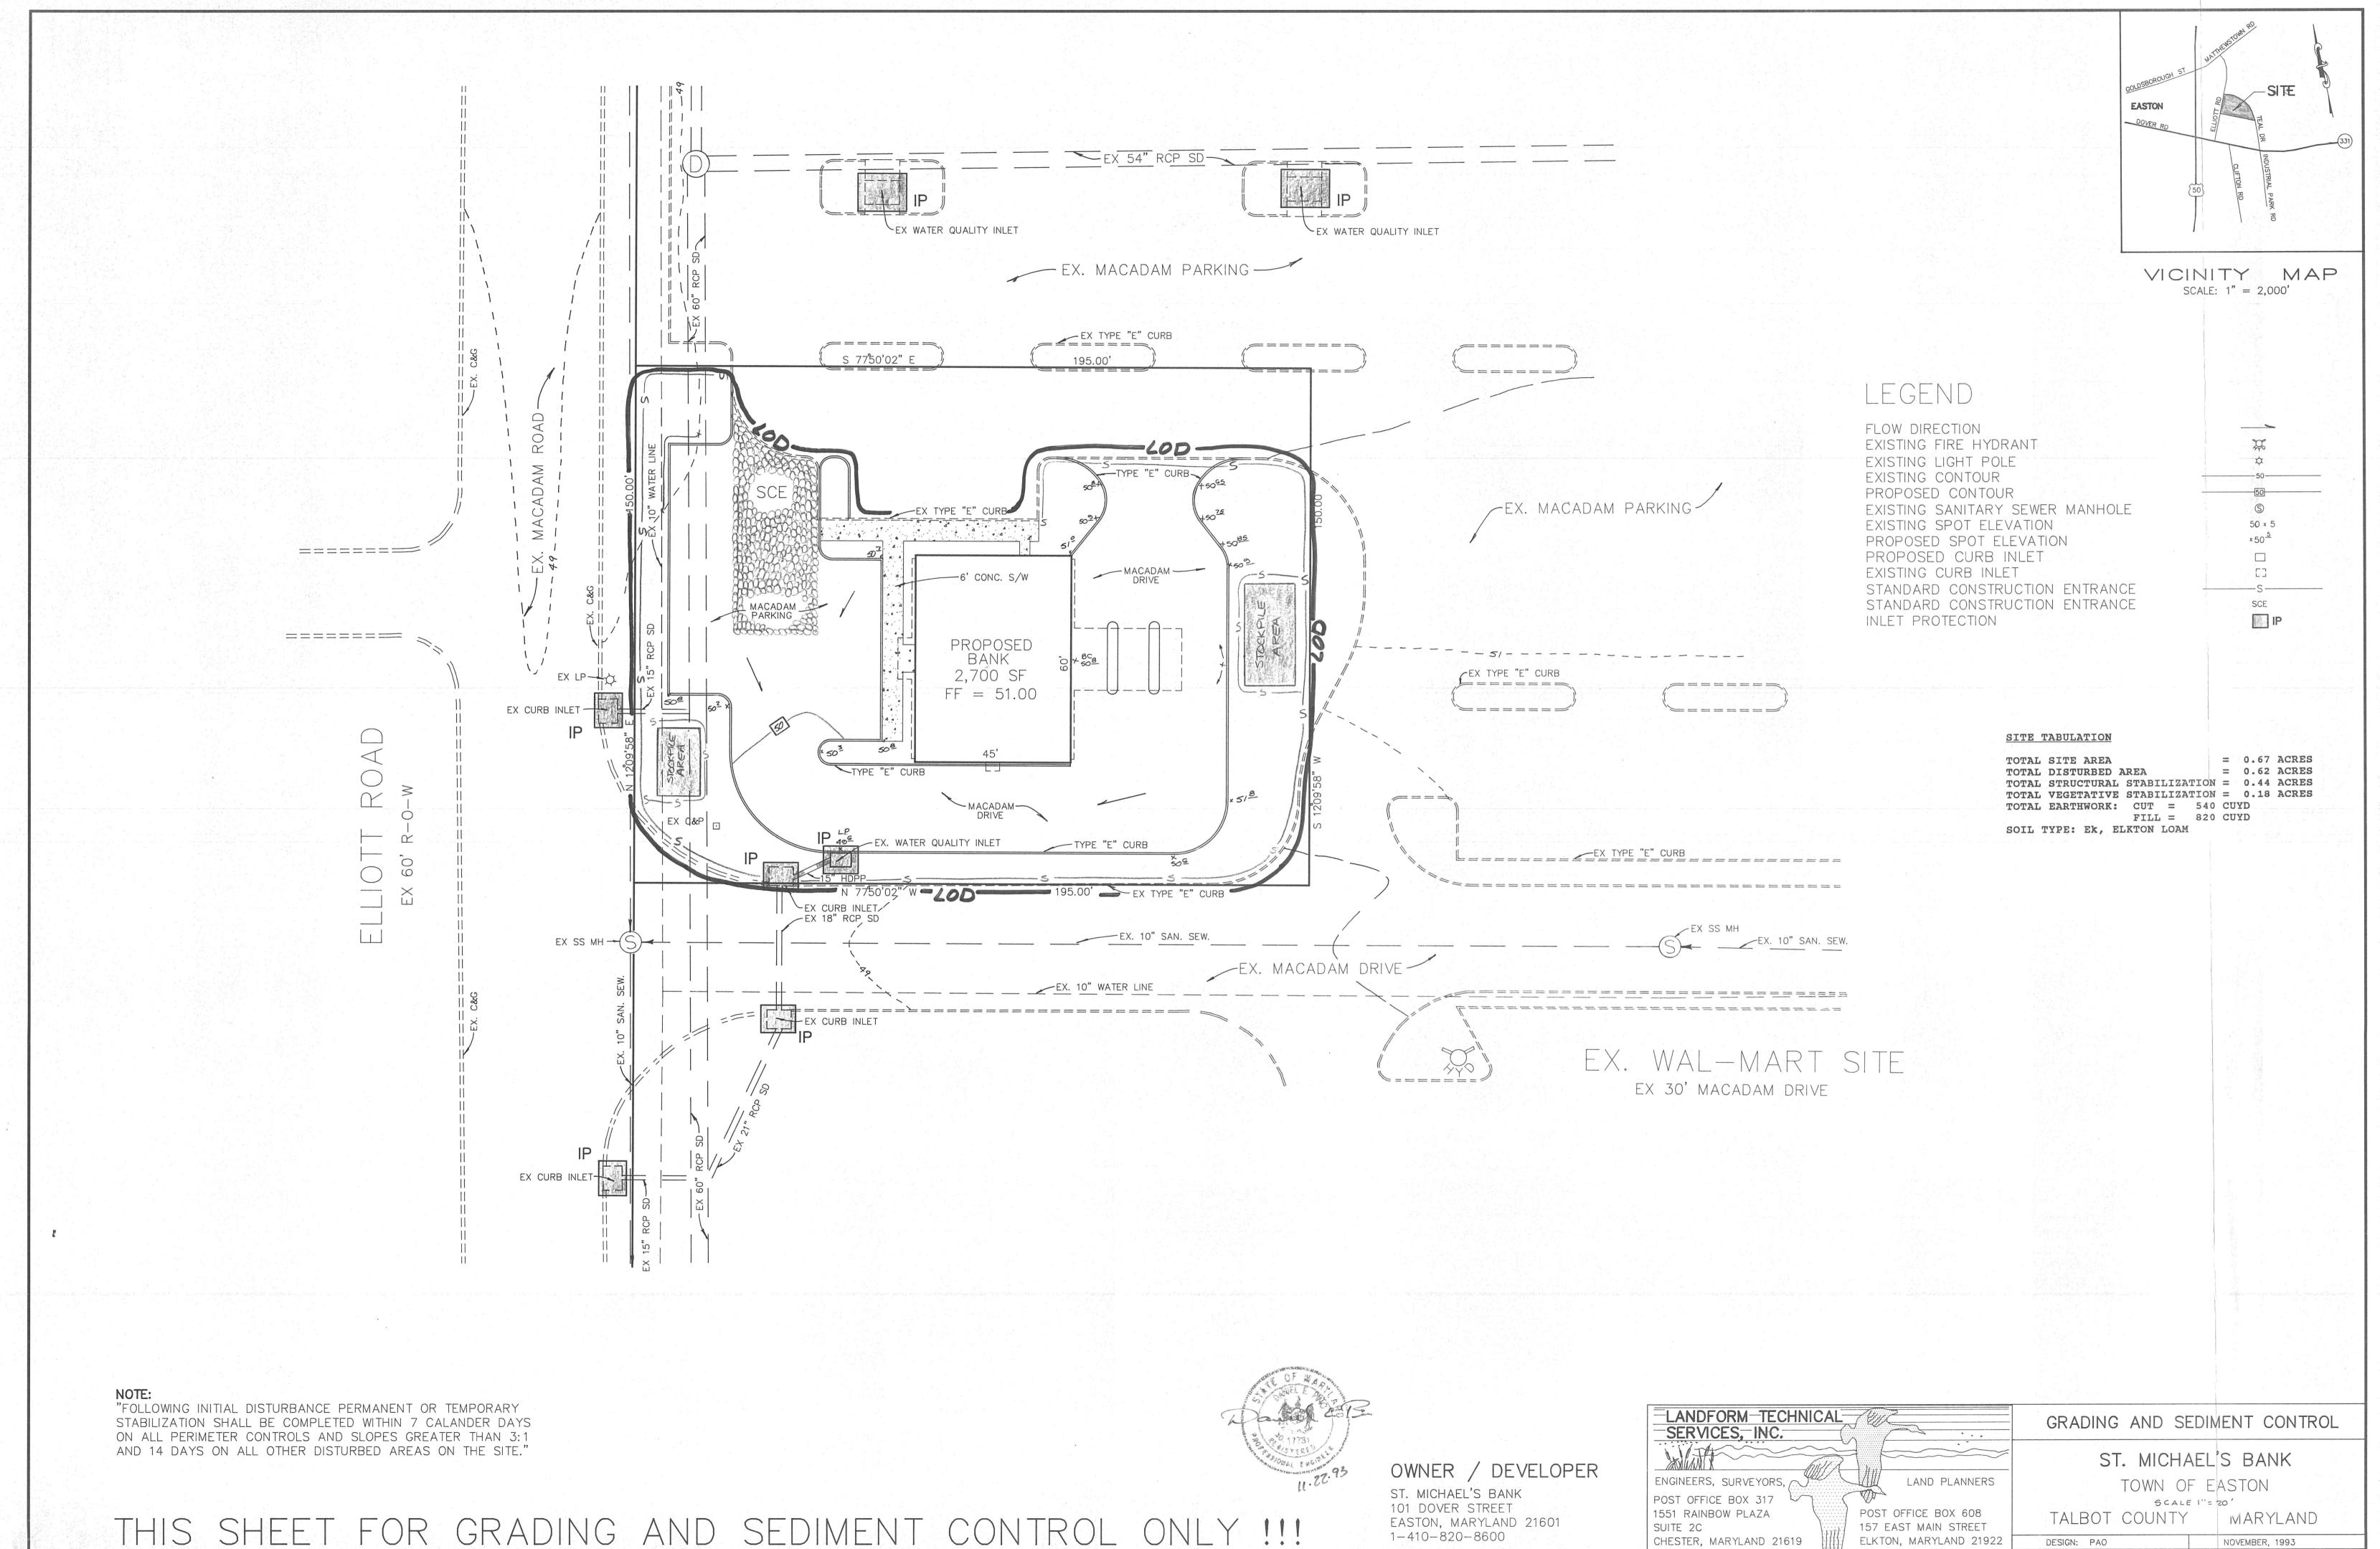

DESIGN: PAO NOVEMBER, 1993

DRAWN: PAO JOB NO: GARDO1-04


CHECKED: DEP SHEET 1 OF 2

PHONE (410) 392-4462

FAX (410) 392-6916

PHONE (410) 643-3612

FAX (410) 643-5102

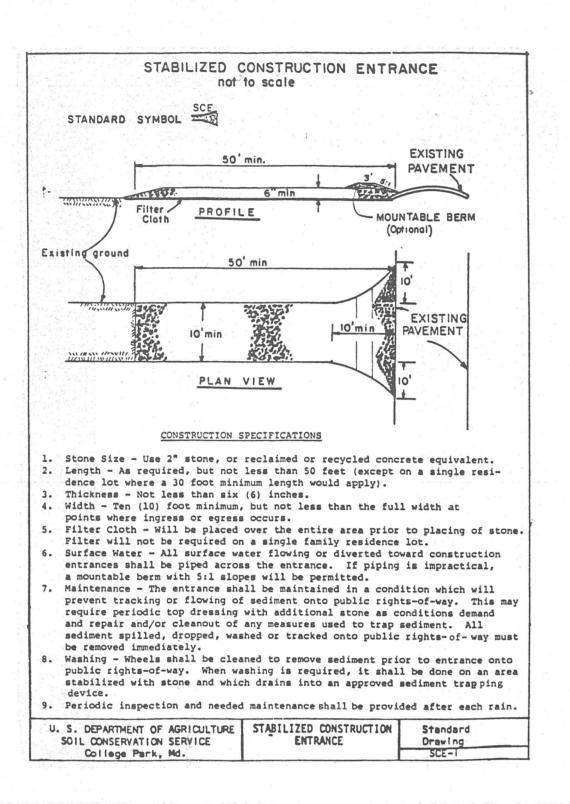

REVIEWED FOR TALBOT SOIL CONSERVATION DISTRICT AND

PROTECTION BECOMES NECESSARY.

U.S. SOIL CONSERVATION DISTRICT SERVICE

BEFORE BEGINNING THE PROJECT.

TALBOT SOIL CONSERVATION DISTRICT

APPROVED:

SIGNATURE

TOR.

MEETS TECHNICAL REQUIREMENTS

THE TALBOT SOIL CONSERVATION DISTRICT RESERVES THE RIGHT

TO ADD, DELETE, MODIFY, OR OTHERWISE ALTER THE EROSION

CONTROL PROVISIONS OF THIS PLAN IN THE EVENT ADDITIONAL

DEVELOPER'S CERTIFICATE

I HEREBY CERTIFY THAT ALL THE DEVELOPMENT AND/OR CONSTRUCTION SHALL BE

1. IT WILL BE THE RESPONSIBILITY OF THE CONTRACTOR OR SUBCONTRACTOR TO

2. ANY RESPONSIBLE PERSONNEL INVOLVED IN THE CONSTRUCTION PROJECT WILL

NOTIFY THE ENGINEER OF ANY DEVIATION FROM THIS PLAN. ANY CHANGE MADE

IN THIS PLAN WITHOUT WRITTEN AUTHORIZATION FROM THE ENGINEER WILL


PLACE RESPONSIBILITY FOR SAID CHANGE ON THE CONTRACTOR OR SUBCONTRAC-

HAVE A CERTIFICATE OF ATTENDANCE AT A DEPARTMENT OF NATURAL RESOURCES

APPROVED TRAINING PROGRAM FOR THE CONTROL OF SEDIMENT AND EROSION

DONE ACCORDING TO THIS PLAN OF EROSION AND SEDIMENT CONTROL.

DATE

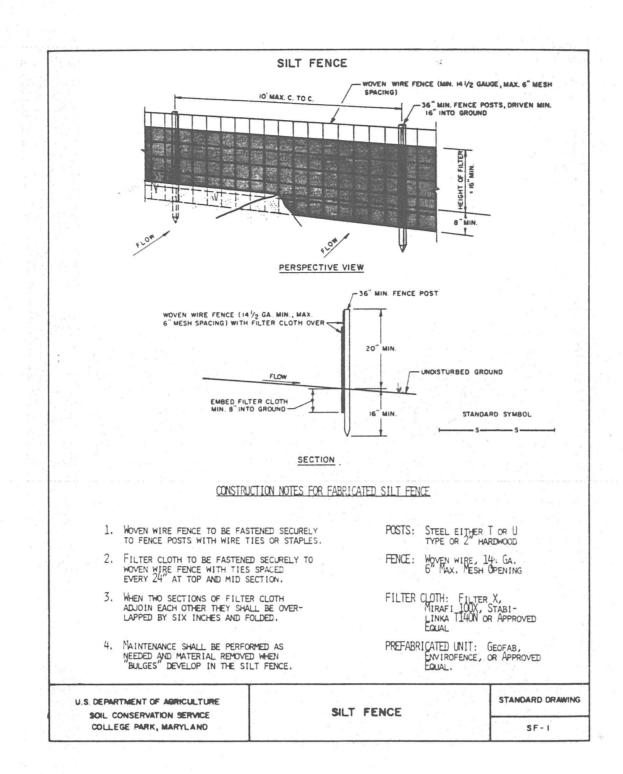

GENERAL NOTES

- EXISTING ZONING: C-6 REQUIRED SETBACKS: FRONT 25 FEET SIDE 15 FEET REAR 15 FEET
- MAXIMUM BUILDING HEIGHT: 50 FEET MAXIMUM LOT COVERAGE BY BUILDINGS: 50% ALL MATERIALS AND METHODS OF CONSTRUCTION SHALL CONFORM TO THE DRAWINGS, SPECIFICATIONS, LOCAL AND STATE BUILDING CODES, AND THE STANDARDS AND SPECIFICATIONS OF TALBOT COUNTY, THE TOWN OF EASTON, TALBOT SOIL CONSERVATION DISTRICT, STATE HIGHWAY ADMINISTRATION (S.H.A.) AND THE EASTON UTILITIES COMMISSION (E.U.C.) UNLESS OTHERWISE NOTED.
- ALL DISTURBED AREAS SHALL BE SMOOTHLY GRADED TO PROMOTE POSITIVE DRAINAGE AND STABILIZED WITH TOPSOIL, SEED AND MULCH & THIS PROCESS SHALL BE REPEATED UNTIL SEDIMENTATION SUBSIDES. (SEE EROSION AND SEDIMENT CONTROL DETAILS AND SPECIFICATIONS.) THE CONTRACTOR SHALL NOTIFY THE FOLLOWING TWO WEEKS PRIOR TO
- THE START OF CONSTRUCTION WITH THE NECESSARY COMPANIES. 1-410-822-2525 TOWN OF EASTON 1-800-441-8355 MISS UTILITIES LANDFORM TECHNICAL SERVICES, INC. 1-410-643-3612 1-410-822-5873 TALBOT COUNTY DEPARTMENT OF PUBLIC WORKS 1-410-822-6110 EASTON UTILITIES COMMISSION
- C&P TELEPHONE COMPANY THE CONTRACTOR ASSUMES ALL RESPONSIBILITY FOR ANY DEVIATION FROM THESE PLANS. THE OWNER IS RESPONSIBLE FOR THE ACQUISITION, ABANDONMENT OR DEDICATION OF ALL EASEMENTS, BOTH TEMPORARY AND PERMANENT.
- 10. THIS PLAN WAS DONE WITHOUT THE BENEFIT OF A TITLE REPORT. TOPOGRAPHY WAS FIELD RUN BY LANDFORM TECHNICAL SERVICES, INC. IN JULY 1993.
- 12. BOUNDARY SURVEY WAS PERFORMED BY LANDFORM TECHNICAL SERVICES, INC. IN MAY 1990. SOILS INVESTIGATION WAS PERFORMED BY JOHN D. HYNES & ASSOCI-
- 1-410-546-6462 ATES, INC., SALISBURY, MARYLAND. 14. ANY UNUSUAL SUBSURFACE CONDITIONS SHALL BE REPORTED IMMEDIATE-LY TO THE ENGINEER. 15. ALL DIMENSIONS, ELEVATIONS, AND LOCATIONS SHALL BE VERIFIED IN
- THE FIELD BY EACH CONTRACTOR PRIOR TO THE BEGINNING OF WORK. 16. THE CONTRACTOR SHALL COORDINATE WITH THE TOWN OF EASTON TO ARRANGE FOR INSPECTIONS BY THE NECESSARY AUTHORITIES. 17. THE CONTRACTOR SHALL EMPLOY EROSION AND SEDIMENT CONTROL
- CONTROL. NO AREA SHALL BE LEFT DENUDED FOR MORE THAN 14 DAYS. 18. CONTRACTOR TO CLEAN UP AND RESTORE ALL DISTURBED AREAS IMMEDIATELY UPON COMPLETION OF UTILITY INSTALLATION IN AFFECTED AREAS. 19. ALL STRUCTURAL FILL SHALL BE COMPACTED TO 95% OF THE STANDARD

DEVICES AS REQUIRED IN ACCORDANCE TO THE CURRENT MARYLAND

STANDARDS AND SPECIFICATIONS FOR SOIL EROSION AND SEDIMENT

- PROCTOR MAXIMUM DRY DENSITY (ASTM D-698). SOILS SHOULD BE COMPACTED WITHIN A PLUS OR MINUS 3 PERCENTAGE POINTS OF OPTIMUM MOISTURE CONTENT.
- 20. ALL PROPOSED STORM DRAINS WILL BE MAINTAINED BY THE OWNER. 21. ALL EXISTING UTILITIES AND TIE-IN AT EXISTING UTILITIES ARE TO BE FIELD VERIFIED BY THE CONTRACTOR PRIOR TO CONSTRUCTION. CONTRACTOR IS TO VERIFY USING TEST PITS. IF ANY CONFLICTS EXIST IT IS THE CONTRACTORS RESPONSIBILITY TO NOTIFY THE ENGINEER IMMEDIATELY.
- 22. STORM DRAIN PIPE SHALL BE AS INDICATED IN THE PROJECT SPECIFI-CATIONS AND AS SHOWN ON PLAN. 23. PIPE FRICTION FACTORS:
- REINFORCED CONCRETE PIPE (R.C.P. & R.C.E.P.) n=0.013 CORRUGATED POLYETHYLENE PIPE (SMOOTH LINED) n=0.012 24. ALL CURB RADII ARE 4.0' UNLESS OTHERWISE NOTED.
- 25. ALL WATER VALVES WILL OPEN TO THE RIGHT. 26. ALL CONCRETE MONUMENTS OR PROPERTY CORNERS DISTURBED DURING CONSTRUCTION SHALL BE REPLACED AT THE CONTRACTORS EXPENSE.

"FOLLOWING INITIAL DISTURBANCE PERMANENT OR TEMPORARY STABILIZATION SHALL BE COMPLETED WITHIN 7 CALANDER DAYS ON ALL PERIMETER CONTROLS AND SLOPES GREATER THAN 3:1 AND 14 DAYS ON ALL OTHER DISTURBED AREAS ON THE SITE.

EROSION AND SEDIMENT CONTROL DETAILS AND SPECIFICATIONS

INLET -

STANDARD DRAWING

IPD-I

STANDARD SYMBOL

INLET PROTECTION

CURB INLET PROTECTION DETAIL

of 2 x 4 spacer

U.S. DEPARTMENT OF AGRICULTURE

SOIL CONSERVATION SERVICE

1-410-820-6306

COLLEGE PARK, MARYLAND

- 1. CONTRACTOR TO INSTALL SOIL EROSION AND SEDIMENT CONTROL DEVICES PRIOR TO ANY GRADING. FOLLOWING INITIAL DISTURBANCE OR REDISTURBANCE, PERMANENT OR TEMPORARY STABILIZATION SHALL BE COMPLETED WITHIN SEVEN CALENDAR DAYS AS TO THE SURFACE OF ALL PERIMETER CONTROLS, DIKES, SWALES, DITCHES, PERIMETER SLOPES GREATER THAN 3 HORIZONTAL TO 1 VERTICAL (3:1) AND FOURTEEN DAYS AS TO ALL OTHER DISTURBED OR GRADED AREAS ON THE PROJECT SITE.
- ALL TEMPORARY EROSION AND SEDIMENT CONTROL DEVICES ARE TO BE PROVIDED AS INDICATED ON THIS PLAN, WITH LOCATION ADJUSTMENTS TO BE MADE IN THE FIELD AS NECESSARY, AND TO BE MAINTAINED AT THE END OF EACH WORKING DAY UNTIL PROJECT COMPLETION. THE MINIMUM AREA PRACTICAL SHALL BE DISTURBED FOR THE MINIMUM AMOUNT OF TIME POSSIBLE.
- CLEARING AND GRUBBING SHALL INCLUDE ALL TREES, BRUSH, DEBRIS, ROOT MAT AND ORGANIC MATERIALS TO BE REMOVED. TEMPORARY SEEDING SHALL BE ACCOMPLISHED BETWEEN FEBRUARY 1ST THROUGH
- APRIL 30TH, OR AUGUST 15TH THROUGH NOVEMBER 1ST. DURING OTHER TIMES, TEMPORARY MULCHING SHALL BE PROVIDED.
- TEMPORARY SEEDING SHALL CONFORM TO THE FOLLOWING APPLICATIONS: 600 LBS. PER ACRE OF 10-10-10; 2000 LBS. PER ACRE OF PULVERIZED DOLOMITIC LIMESTONE, TO BE HARROWED OR DISKED INTO THE SOIL. ITALIAN OR PERENNIAL RYE GRASS SHALL BE APPLIED AT A RATE OF 40 LBS. PER ACRE USING SUITABLE EQUIPMENT. MULCHING SHALL BE ACCOMPLISHED IMMEDIATELY AFTER SEEDING.
- MULCHING SHALL BE UNCHOPPED, UNROTTED, SMALL GRAIN STRAW APPLIED AT A RATE OF 12 TO 2 TONS PER ACRE. ANCHOR MULCH WITH MULCH TOOL ON THE CONTOUR OR WITH ASPHALT TIE DOWN METHOD.
- PERMANENT SEEDING SHALL BE ACCOMPLISHED BETWEEN FEBRUARY 1ST THROUGH APRIL 30TH, OR AUGUST 15TH THROUGH OCTOBER 31ST. SEEDING AT OTHER THAN SPECIFIED TIMES WILL BE ALLOWED ONLY UPON WRITTEN APPROVAL. PERMANENT SEEDING SHALL CONFORM TO THE FOLLOWING APPLICATIONS: 1000 LBS. PER ACRE OF 10-10-10; 2000 LBS. PER ACRE OF PULVERIZED DOLOMITIC LIMESTONE, TO BE HARROWED OR DISKED INTO THE SOIL. KENTUCKY 31 TALL FESCUE SHALL THEN BE APPLIED AT A RATE OF 240 LBS. PER ACRE USING SUITABLE EQUIPMENT. MULCH SHALL BE AS DISCUSSED IN ITEM #6 OF THESE
- ANY SPOIL OR BORROW WILL BE PLACED AT A SITE APPROVED BY THE SOIL CONSERVATION DISTRICT. THE CONTRACTOR OR SUBCONTRACTOR SHALL NOTIFY THE TALBOT SOIL
- CONSERVATION DISTRICT THREE (3) DAYS PRIOR TO COMMENCEMENT OF WORK. ALL AREAS REMAINING OR INTENDED TO REMAIN DISTURBED FOR LONGER THAN FOURTEEN (14) DAYS SHALL BE STABILIZED IN ACCORDANCE WITH THE USDA, SOIL CONSERVATION SERVICE STANDARDS AND SPECIFICATIONS FOR SOIL EROSION AND SEDIMENT CONTROL IN DEVELOPING AREAS FOR CRITICAL AREA STABILIZATION.
- 11. IT WILL BE THE RESPONSIBILITY OF THE CONTRACTOR OR SUBCONTRACTOR TO NOTIFY THE ENGINEER OF ANY DEVIATION FROM THIS PLAN. ANY CHANGE MADE IN THIS PLAN WITHOUT WRITTEN AUTHORIZATION FORM THE ENGINEER WILL PLACE RESPONSIBILITY OF SAID CHANGE ON THE CONTRACTOR OR SUBCONTRAC-

SEQUENCE OF CONSTRUCTION

- 1. CONTRACTOR/DEVELOPER IS TO NOTIFY EASTON UTILITIES COMMISSION ENGINEERING DEPARTMENT AND TOWN ENGINEER @ 410-822-6110, AND MARYLAND DEPARTMENT OF THE ENVIRONMENT @ 410-631-3510 2 WEEKS PRIOR TO COMMENCING WORK FOR A PRE-CONSTRUCTION MEETING.
- 2. INSTALL STABILIZED CONSTRUCTION ENTRANCE (SCE), INLET PROTEC-TION (IP) ON ALL EXISTING INLETS AND SILT FENCE (---S---) AS SHOWN ON THESE PLANS.
- CLEAR AND GRUB SITE AS NECESSARY TO INSTALL STORM DRAIN AND INLET 1. INSTALL INLET PROTECTION ON INLET 1 AS SOON AS IT IS INSTALLED.
- CLEAR AND GRUB REMAINDER OF SITE TO PROVIDE POSITIVE FLOW INTO INLETS.
- INSTALL UTILITIES, BUILDINGS, CURBING, SIDEWALK AND PARKING LOT PAVING. STABILIZE ALL AFFECTED AREAS.
- 6. COMPLETE GRADING ON SITE, LANDSCAPE AND STABILIZE.
- WITH THE APPROVAL OF MARYLAND DEPARTMENT OF THE ENVIRONMENT REMOVE ALL SEDIMENT CONTROL MEASURES AND STABILIZE ANY AFFECTED AREAS.
- 8. CLEAR AREA OF ALL PAPER, TRASH AND DEBRIS.

DETAILS AND SPECIFICATIONS FOR VEGETATIVE ESTABLISHMENT

SITE PREPARATION

TEMPORARY PERIMETER DIKES AND SILT TRAPS, ETC., ARE TO BE PROVIDED AS PER THIS PLAN PRIOR TO GRADING OPERATIONS WITH LOCATION ADJUSTMENTS TO BE MADE IN THE FIELD AS NECESSARY AND TO BE MAINTAINED AT THE END OF WORKING DAY. THE MINIMUM AREA PRACTICAL SHALL BE DISTURBED FOR THE MINIMUM AMOUNT OF TIME POSSIBLE.

- 2. PERMANENT SEEDING: A. SEEDBED PREPARATION: AREA TO BE SEEDED SHALL BE LOOSE AND FRIABLE TO A DEPTH OF AT LEAST 3". THE TOP LAYER SHALL BE LOOSENED BY RAKING, DISKING OR OTHER ACCEPTABLE MEANS BEFORE SEEDING OCCURS. IN LIEU OF SOIL TEST RESULTS, APPLY 100 POUNDS OF DOLOMITIC LIMESTONE AND 25 POUNDS OF 10-10-10 FERTILIZER PER 1,000 SQUARE FEET. HARROW OR DISK LIME AND FERTILIZER INTO THE SOIL TO A DEPTH OF AT LEAST 3" ON SLOPES FLATTER THAN 3:1. NO ATTEMPT SHOULD BE MADE TO DRAG ANY DISKED AREA TO MAKE THE SOIL SURFACE SMOOTH AFTER DISKING.
- B. SEEDING: APPLY 5-6 POUNDS PER 1,000 SQUARE FEET OF KENTUCKY 31 TALL FESCUE BETWEEN FEBRUARY 1 AND APRIL 30 OR BETWEEN AUGUST 15 AND OCTOBER 31. APPLY SEED UNIFORMLY WITH A CYCLONE SEEDED DRILL. CULTIPACKER SEEDER OR HYODROSEEDER (SLURRY INCLUDES SEEDS AND FERTILIZER, RECOMMENDED ON STEEP SLOPES ONLY) ON A MOIST, FIRM SEEDBED. MAXIMUM SEED DEPTH SHOULD BE 1/4" IN CLAYEY SOILS AND 1/2" IN SANDY SOILS WHEN USING OTHER THAN THE HYDROSEEDER METHOD. IRRIGATE IF SOIL MOISTURE IS DEFICIENT TO SUPPORT ADEQUATE GROWTH, UNTIL VEGETATION IS FIRMLY ESTABLISHED.
- MULCHING: MULCH SHALL BE UNCHOPPED, UNROTTED SMALL GRAIN STRAW APPLIED AT A RATE OF 70 TO 90 POUNDS PER 1,000 SQUARE FEET. MULCH MATERIALS SHALL BE RELATIVELY FREE OF ALL KINDS OF WEEDS AND SHALL BE FREE OF PROHIBITED NOXIOUS WEEDS WHICH ARE: CANADA THISTLE, JOHNSONGRASS, AND QUACKGRASS. SPEED MULCH MECHANICALLY OR UNIFORMLY BY HAND: MULCH ANCHORING SHALL BE ACCOMPLISHED IMMEDIATELY AFTER MULCH PLACEMENT TO MINIMIZE LOSS BY WIND OR WATER. THIS MAY BE DONE BY PEG AND TWINE METHOD, MULCH ANCHORING TOOL, NETTING OR LIQUID MULCH BINDERS.

3. TEMPORARY SEEDING

LIME:

MULCH:

50 POUNDS OF DOLOMITIC LIMESTONE PER 1,000 SQUARE FEET FERTILIZER:

25 POUNDS OF 10-10-10 PER 1,000 SQUARE PERENNIAL RYE, ITALIAN RYE - 0.92 POUNDS PER 1,000 SQUARE FEET (FEBRUARY 1 THROUGH APRIL 30 OR AUGUST 15

THROUGH NOVEMBER 1) MILLET - 0.92 POUNDS PER 1,000 SQUARE FEET (MAY 1 THROUGH AUGUST 15)

SAME AS ABOVE (NOVEMBER 2, THROUGH JANUARY 31)

- 4. NO FILLS MAY BE PLACED ON FROZEN GROUND. ALL FILL TO BE PLACED IN APPROXIMATELY HORIZONTAL LAYERS, EACH LAYER HAVING A LOOSE THICKNESS OF NOT MORE THAN 8". ALL FILL IN ROADWAYS AND PARKING AREAS IS TO BE CLASSIFIED TYPE 2 AS PER CECIL COUNTY GRADING ORDINANCE, SECTION 12-2027. AND COMPACTED TO 90% DENSITY; COMPACTION TO BE DETERMINED BY ASTM D-1557 (MODIFIED PROCTOR). ANY FILL WITHIN BUILDING AREA TO BE COMPACTED TO A MINIMUM OF 95% AS DETERMINED BY METHODS PREVIOUSLY MENTIONED. ALL OTHER FILLS SHALL BE COMPACTED SUFFICIENTLY SO AS TO BE STABLE AND PREVENT EROSION AND SLIPPAGE.
- PERMANENT SOD IS TO BE KENTUCKY 31 TALL FESCUE STATE APPROVED SOD: LIME AND FERTILIZER PER PERMANENT SEEDING SPECIFICATIONS AND LIGHTLY IRRIGATE SOIL PRIOR TO LAYING SOD. SOD IS TO BE AID ON THE CONTOUR WITH ALL ENDS LIGHTLY ABUTTING. TO BE STAGGERED BETWEEN ROWS. WATER AND ROLL OR TAMP SOD TO INSURE POSITIVE ROOT CONTACT WITH THE SOIL. ALL SLOPES GREATER THAN 3 TO 1, AS SHOWN, ARE TO BE PERMANENTLY SODDED OR PROTECTED WITH AN APPROVED EROSION CONTROL NETTING. ADDITIONAL WATERING FOR ESTABLISHMENT MAY BE REQUIRED. SOD IS NOT TO BE APPLIED ON FROZEN GROUND.
- THE DEVELOPER IS RESPONSIBLE FOR THE ACQUISITION OF ALL EASEMENTS RIGHTS AND/OR RIGHTS OF WAY THAT MAY BE REQUIRED FOR THE SEDIMENT AND EROSION CONTROL PRACTICES, STORMWATER MANAGEMENT PRACTICES AND THE DISCHARGE AT STORM WATER ONTO OR ACROSS ADJACENT OR DOWNSTREAM PROPERTIES INCLUDED IN THIS PLAN (ALSO SEE B BELOW).
- THE DEVELOPER IS RESPONSIBLE FOR THE ACQUISITION OF ALL EASEMENTS RIGHTS AND/OR RIGHTS OF WAY THAT MAY BE REQUIRED FOR GRADING AND/OR WORK ON ADJACENT PROPERTIES
- INCLUDED IN THIS PLAN. C. THE SEDIMENT CONTROL APPROVALS ON THIS PLAN EXTEND ONLY

TO AREAS AND PRACTICES IDENTIFIED AS PROPOSED WORK.

OWNER / DEVELOPER

ST. MICHAEL'S BANK 101 DOVER STREET EASTON, MARYLAND 21601 1-410-820-8600 ATTN: ANNE M. RAY

LANDFORM—TECHNICAL SERVICES, INC ENGINEERS, SURVEYORS, POST OFFICE BOX 317 1551 RAINBOW PLAZA POST OFFICE BOX 608 157 EAST MAIN STREET SUITE 2C

CHESTER, MARYLAND 21619

PHONE (410) 643-3612

FAX (410) 643-5102

GRADING AND SEDIMENT CONTROL ST. MICHAEL'S BANK LAND PLANNERS TOWN OF EASTON

ELKTON, MARYLAND 21922

PHONE (410) 392-4462

FAX (410) 392-6916

MARYLAND TALBOT COUNTY

DESIGN: PAO NOVEMBER, 1993 DRAWN: PAO

JOB NO: GARDO1-04 CHECKED: DEP SHEET 2 OF 2