/ 1 フ (`() R	STREET	CODE A	ANALYSIS		
				CODE PRESCRIPTIVE / REQUIRED	COMPLIANCE
BINGHAMTON	, NY 13901	CHAPTER 6	G BUILDING CODE OF N	LEVEL 3 ALTERATIONS APPLY WHERE THE WORK AREA EXCEEDS 50 PERCENT OF THE BUILDING AREA.	PROPOSED SCOPE OF WORK INCLUDES THE REPLACEMENT C EXISTING INTERIOR PARTITIONS, PLUMBING, FIXTURES AND FINISHES.
OPE OF WORK			SEC. 604.2	LEVEL 3 ALTERATIONS SHALL COMPLY WITH PROVISIONS OF CHAPTER 7 AND 8, AS WELL AS PROVISIONS OF CHAPTER 8.	
TERATION LEVEL 3 OF A 3-STORY RESIDENTIAL BUILDING, FOR A AL OF 8 DWELLING UNITS (18 BEDROOMS). STING INTERIOR PARTITIONS, PLUMBING, FIXTURES AND FINISHES	PROPERTY DATA ADDRESS: 212 COURT STREET	CHAPTER 7	SEC. 701.2	AN EXISTING BUILDING OR PORTION THEREOF SHALL NOT BE ALTERED SUCH THAT THE BUILDING BECOMES LESS SAFE THAN ITS EXISTING CONDITION.	PROPOSED ALTERATIONS TO BE OF SAME CONFORMANCE.
E REPLACED THROUGHOUT. STING SPRINKLER SYSTEM TO REMAIN.	COUNTY: BROOME STATE: NEW YORK TAX PARCEL NUMBER: 160.34-2-41 PLANNING JURISDICTION: CITY OF BINGHAMTON		SEC. 702.1	NEWLY INSTALLED INTERIOR WALL AND CEILING FINISHES SHALL COMPLY WITH CHAPTER 8 OF THE BUILDING CODE OF NEW YORK STATE.	PROPOSED FINISHES TO COMPLY WITH CHAPTER 8 OF BUILDING CODE OF NEW YORK STATE.
DES IN EFFECT EXISTING BUILDING CODE OF NEW YORK STATE			SEC. 703.1	ALTERATIONS SHALL BE DONE IN A MANNER THAT MAINTAINS THE LEVEL OF FIRE PROTECTION PROVIDED.	EXISTING FIRE SPRINKLER TO REMAIN.
BUILDING CODE OF NEW YORK STATE PLUMBING CODE OF NEW YORK STATE ENERGY CONSERVATION CODE OF NEW YORK STATE	A-00 GENERAL INFO, CODE ANALYSIS		SEC. 704.1	ALTERATIONS SHALL BE DONE IN A MANNER THAT MAINTAINS THE LEVEL OF PROTECTION PROVIDED FOR THE MEANS OF EGRESS.	NO CHANGE IN PROTECTION OF MEANS OF EGRESS.
GTY BROHMTON MUNICIPAL EXDIM	A-01 BASEMENT PLAN A-02 FIRST FLOOR PLAN A-03 SECOND FLOOR PLAN A-04 THIRD FLOOR PLAN A-05 WALL DETAILS, SCHEDULES, SANITARY RISER A-06 REFLECTED CEILING PLANS		SEC. 707.1	LEVEL 1 ALTERATIONS TO EXISTING BUILDINGS OR STRUCTURES DO NOT REQUIRE THE ENTIRE BUILDING OR STRUCTURE TO COMPLY WITH THE ENERGY REQUIREMENTS OF THE ENERGY CONSERVATION CONSTRUCTION CODE OF NEW YORK STATE OR RESIDENTIAL CODE OF NEW YORK STATE. THE ALTERATIONS SHALL CONFORM TO THE ENERGY REQUIREMENTS OF THE ENERGY CONSERVATION CONSTRUCTION CODE OF NEW YORK STATE OR RESIDENTIAL CODE OF NEW YORK STATE AS THEY RELATE TO NEW CONSTRUCTION ONLY.	INSTALLATION OF NEW FURNACE TO COMPLY WITH THE ENERGY CODE CONSERVATION OF NEW YORK STATE.
1100	80 ¹⁷ 0 5 5 5 5 5 5 5 5 5 5 5 5 5 5 5 5 5 5		SEC. 708.1	WHEN ANY WATER CLOSET IS REPLACED, THE REPLACEMENT WATER CLOSET SHALL COMPLY WITH SECTION 604.4 OF THE PLUMBING CODE OF NEW YORK STATE.	PROPOSED TOILETS TO COMPLY WITH SECTION 604.4 OF THE PLUMBING CODE OF NEW YORK STATE.
1 ett uspervereet use	414 500 100 100 100 100 100 100 100	CHAPTER 8	SEC. 801.3	NEW CONSTRUCTION ELEMENTS, COMPONENTS, SYSTEMS AND SPACES SHALL COMPLY WITH EH REQUIREMENTS OF THE BUILDING CODE OF NEW YORK STATE.	PROPOSED CONSTRUCTION TO COMPLY WITH BUILDING CODE OF NEW YORK STATE.
1112 (1004) (100	A1 must num num <td></td> <td>SEC. 804.1</td> <td>CARBON MONOXIDE DETECTION AND NOTIFICATION SHALL BE PROVIDED IN ACCORDANCE WITH SECTIONS 503.15 THROUGH 503.15.1 FOR BUILDINGS THAT UNDERGO AN ALTERATION.</td> <td>CARBON MONOXIDE DETECTORS PROVIDED.</td>		SEC. 804.1	CARBON MONOXIDE DETECTION AND NOTIFICATION SHALL BE PROVIDED IN ACCORDANCE WITH SECTIONS 503.15 THROUGH 503.15.1 FOR BUILDINGS THAT UNDERGO AN ALTERATION.	CARBON MONOXIDE DETECTORS PROVIDED.
num num <td>10 12 45 11 11 12 12 46 12 14 15 12 12 12 12 15 10 12 12 12 12 10 10 48 12 12 10 10 10</td> <td></td> <td>SEC. 807.1</td> <td>NEWLY INSTALLED ELECTRICAL EQUIPMENT AND WIRING RELATING TO WORK DONE IN ANY WORK AREA SHALL COMPLY WITH APPLICABLE REQUIREMENTS OF NFPA 70.</td> <td>PROPOSED ELECTRICAL WORK TO COMPLY WITH NFPA 70.</td>	10 12 45 11 11 12 12 46 12 14 15 12 12 12 12 15 10 12 12 12 12 10 10 48 12 12 10 10 10		SEC. 807.1	NEWLY INSTALLED ELECTRICAL EQUIPMENT AND WIRING RELATING TO WORK DONE IN ANY WORK AREA SHALL COMPLY WITH APPLICABLE REQUIREMENTS OF NFPA 70.	PROPOSED ELECTRICAL WORK TO COMPLY WITH NFPA 70.
$\begin{array}{c ccccccccccccccccccccccccccccccccccc$	N B		SEC. 808.1	RECONFIGURED SPACES INTENDED FOR OCCUPANCY AND SPACES CONVERTED TO HABITABLE OR OCCUPIABLE SPACE IN ANY WORK AREA SHALL BE PROVIDED WITH NATURAL OR MECHANICAL VENTILATION IN ACCORDANCE WITH THE MECHANICAL CODE OF NEW YORK STATE.	PROPOSED HABITABLE SPACES PROVIDED WITH NATURAL VENTILATION.
150 BECOMENT CITY BECOMENT SA CENTER 160.34 200 41 41 41 42 40 41 41 41 41 41 41 41 41 41 41 41 41 41	101-3 101-3 CHAPTER 9	SEC. 901.2	IN ADDITION TO THE PROVISIONS OF THIS CHAPTER, WORK SHALL COMPLY WITH ALL THE REQUIREMENTS OF CHAPTER 7 AND 8.	PROPOSED CONSTRUCTION TO COMPLY WITH EXISTING BUILDING CODE OF NEW YORK; CHAPTER 7, 8 AND 9.
1001 1001 100 10 101 100 10 10 101 100 10 10 101 100 10 10 101 100 10 10 101 100 10 10 101 100 10 10 101 100 10 10 101 100 10 10 101 100 10 10 101 100 10 10 101 100 10 10	15 15 15 15 15 15 15 15 15 15		SEC. 902.2	BOILER AND FURNACE EQUIPMENT ROOMS ADJACENT OR WITHIN GROUP I-1, I-2, I-4, R-1, R-2 AND R-4 OCCUPANCIES SHALL BE ENCLOSED BY 1 HOUR FIRE RESISTANCE RATING.	ENCLOSED MECHANICAL CLOSETS ENCLOSED WITH 1 HOU RATED WALLS.
			SEC. 903.1	EXISTING STAIRWAYS THAT ARE PART OF THE MEANS OF EGRESS SHALL BE ENCLOSED IN ACCORDANCE WITH SECTION 802.2.1.	EXISTING STAIRWAYENCLOSED WITH 1 HOUR RATED WALL
9 E 2 2 2 2 2 2 2 2 2 2 2 2 2 2 2 2 2 2			SEC. 904.2	FIRE ALARM AND DETECTION SHALL BE PROVIDED IN ACCORDANCE WITH SECTION 907 OF THE BUILDING CODE OF NEW YORK STATE AS REQUIRED FOR NEW CONSTRUCTION.	EXISTING STAIRWAYENCLOSED WITH 1 HOUR RATED WALL
			SEC. 905.2	MEANS OF EGRESS SHALL BE PROVIDED WITH ARTIFICIAL LIGHTING WITHIN THE EXIT ENCLOSURE IN ACCORDANCE WITH REQUIREMENTS OF BUILDING CODE OF NEW YORK.	MEANS OF EGRESS PROVIDED WITH ARTIFICIAL LIGHTING AND EMERGENCY LIGHTING.
	40 1112 1		SEC. 905.3	MEANS OF EGRESS SHALL BE PROVIDED WITH EXIT SIGNS IN ACCORDANCE WITH THE REQUIREMENTS OF THE BUILDING CODE OF NEW YORK.	EXIT SIGNS PROVIDED ON EVERY FLOOR NEAR EXIT STAIRW
The second secon	PROJECT LOCATION	2020 BUILDIN CHAPTER 8	IG CODE OF NEW YORK	STATE INTERIOR WALL AND CEILING FINISH MATERIALS SHALL BE CLASSIFIED FOR FIRE PERFORMANCE AND SMOKE DEVELOPMENT IN ACCORDANCE WITH SECTION 803.1.1 OR 803.1.2, EXCEPT AS SHOWN IN SECTIONS 803.1.3 THROUGH 803.15. MATERIALS TESTED IN ACCORDANCE WITH SECTION 803.1.1 SHALL NOT BE REQUIRED TO BE TESTED IN ACCORDANCE WITH SECTION 803.1.2.	PROPOSED INTERIOR WALL AND CEILING FINISHES TO COMPLY WITH REQUIRED FLAME SPREAD INDEX. PROPOSED INTERIOR FLOOR FINISH TO COMPLY WITH REQUIRED MINIMUM CRITICAL RADIANT FLUX.
			SEC. 803.1.2	INTERIOR WALL AND CEILING FINISH MATERIALS SHALL BE CLASSIFIED IN ACCORDANCE WITH ASTM E84 OR UL 723. SUCH INTERIOR FINISH MATERIALS SHALL BE GROUPED IN THE FOLLOWING CLASSES IN ACCORDANCE WITH THEIR FLAME SPREAD AND SMOKE-DEVELOPED INDICES.	
				CLASS A = FLAME SPREAD INDEX 0-25; SMOKE-DEVELOPED INDEX 0-450. CLASS B = FLAME SPREAD INDEX 26-75; SMOKE-DEVELOPED INDEX 0-450. CLASS C = FLAME SPREAD INDEX 76-200; SMOKE-DEVELOPED INDEX 0-450.	
			TABLE 803.13	INTERIOR WALL AND CEILING FINISH SHALL HAVE A FLAME SPREAD INDEX NOT GREATER THAN THAT SPECIFIED IN TABLE 803.13 FOR THE GROUP AND LOCATION DESIGNATED. GROUP ROOMS & ENCLOSED SPACES (SPRINKLERED) R-2 C	
			SEC. 804.4	INTERIOR FLOOR COVERING MATERIALS SHALL COMPLY WITH SECTIONS 804.4.1 AND 804.4.2 AND INTERIOR FLOOR FINISH MATERIALS SHALL COMPLY WITH SECTION 804.4.2.	
			SEC. 804.4.2	IN ALL OCCUPANCIES, INTERIOR FLOOR FINISH AND FLOOR COVERING MATERIALS IN ENCLOSURES FOR STAIRWAYS AND RAMPS, EXIT PASSAGEWAYS, CORRIDORS AND ROOMS OR SPACES NOT SEPARATED FROM CORRIDORS BY PARTITIONS EXTENDING FROM THE FLOOR TO THE UNDERSIDE OF THE CEILING SHALL WITHSTAND A MINIMUM CRITICAL RADIANT FLUX. THE MINIMUM CRITICAL RADIANT FLUX SHALL BE NOT LESS THAN CLASS II IN GROUPS A, B, E, H, I-4, M, R-1, R-2 AND S.	
		2020 PLUMBI CHAPTER 6	NG CODE OF NEW YOR SEC. 604.4	K STATE THE MAXIMUM WATER CONSUMPTION FLOW RATES AND QUANTITIES FOR ALL PLUMBING FIXTURES AND FIXTURE FITTINGS SHALL BE IN ACCORDANCE WITH TABLE 604.4.	PROPOSED PLUMBING FIXTURES TO COMPLY WITH REQUIRED MAXIMUM FLOW RATES.
			TABLE 604.4	PLUMBING FIXTUREMAX. FLOW RATE OR QUANTITYLAVATORY, PRIVATE1.5 GPM AT 60 PSISHOWER HEAD2.0 GPM AT 80 PSISINK FAUCET2.2 GPM AT 60 PSIWATER CLOSET1.28 GALLONS PER FLUSH	
		2020 ENERGY CHAPTER 4	CODE CONSERVATION	OF NEW YORK STATE	PROPOSED GAS FURNACE HAS MINIMUM EFFICIENCY OF 92.1% AFUE

2020 PLUMBIN	NG CODE OF NEW YORK	STATE
CHAPTER 6	SEC. 604.4	THE MAXIMU QUANTITIES F FITTINGS SHA
	TABLE 604.4	PLUMBING FIX
		LAVATORY, PF SHOWER HEA SINK FAUCET WATER CLOSE
2020 ENERGY	CODE CONSERVATION (OF NEW YORK S
CHAPTER 4	TABLE C403.3.2(4)	EQUIPMENT T
		WARM-AIR FL

GENERAL NOTES

1. THESE NOTES ARE PART OF THE PLANS AND SPECIFICATIONS AND ARE TO BE COMPLIED WITH IN ALL RESPECTS. MORE RESTRICTIVE NOTES MENTIONED ELSEHWERE ARE TO TAKE PRECEDENCE OVER THE FOLLOWING.

2. THE CONTRACTOR SHALL DIRECT AND SUPERVISE THE WORK. THE CONTRACTOR SHALL BE SOLELY RESPONSIBLE FOR ALL CONSTRUCTION MEANS, METHODS, TECHNIQUES, SEQUENCES, PROCEDURES, AND SHALL COORDINATE THE WORK.

3. THE CONTRACTOR SHALL BE HELD TO HAVE VISITED THE SITE SO THAT HE MAY DETERMINE THE DIFFICULTIES HE MAY ENCOUNTER DURING CONSTRUCTION. 4. THE CONTRACTOR SHALL VERIFY ALL EXISTING CONDITIONS AND DIMENSIONS IN THE FIELD PRIOR TO COMMENCING WORK, AND SHALL IMMEDIATELY REPORT ANY DISCREPANCIES BETWEEN DRAWINGS AND FIELD CONDITIONS TO THE ARCHITECT.

5. BEFORE COMMENCING WORK, THE CONTRACTOR SHALL FILE ALL REQUIRED CERTIFICATES OF INSURANCE WITH THE BUILDING DEPARTMENT, OBTAIN ALL REQUIRED PERMITS AND PAY ALL FEES REQUIRED BY GOVERNING LOCAL AGENCIES.

6. ALL WORK SHALL COMPLY WITH THE REGULATIONS OF THE GOVERNMENTAL AUTHORITIES HAVING JURISDICTION. THE NOTES SHALL BE SUPPLEMENTAL TO ALL LAWS AND CODE OF GOVERNMENTAL REGULATING BODIES RELATING TO BUILDINGS AND ALL APPLICABLE REQUIREMENTS SPECIFIED IN THESE REGULATIONS SHALL BE FOLLOWED AS THOUGH SPECIFICALLY NOTED IN THE NOTES OR DRAWINGS.

7. MINOR DETAILS NOT USUALLY SHOWN OR SPECIFIED, BUT NECESSARY FOR PROPER CONSTRUCTION OF ANY PART OF THE WORK SHALL BE INCLUDED AS THEY WERE INDICATED IN THE DRAWINGS.

8. THE CONTRACTOR SHALL COORDINATE ALL WORK PROCEDURES WITH REQUIREMENTS OF LOCAL AUTHORITIES AND BUILDING MANAGEMENT.

9. THE CONTRACTOR SHALL BE RESPONSIBLE FOR THE PROTECTION OF ALL CONDITIONS AND MATERIALS WITHIN THE PROPOSED CONSTRUCTION AREA. THE CONTRACTOR SHALL DESIGN AND INSTALL ADEQUATE SHORING AND BRACING FOR ALL STRUCTURAL OR REMOVAL TRADES. THE CONTRACTOR SHALL HAVE SOLE RESPONSIBILITY FOR ANY DAMAGE OR INJURIES CAUSED BY OR DURING THE EXECUTION OF THE WORK.

IO. THE CONTRACTOR SHALL LAY OUT HIS OWN WORK, AND SHALL PROVIDE ALL DIMENSIONS REQUIRED FOR OTHER TRADES (PLUMBING, ELECTRICAL, ETC.). 11. PLUMBING AND ELECTRICAL WORK SHALL BE PERFORMED BY PERSONS LICENSED IN THEIR TRADES, WHO SHALL ARRANGE FOR AND OBTAIN INSPECTIONS AND

REQUIRED SIGN-OFFS. 12. THE CONTRACTOR SHALL DO ALL CUTTING, PATCHING, REPAIRING AS REQUIRED TO PERFORM ALL OF THE WORK INDICATED ON THE DRAWINGS, AND ALL OTHER

WORK THAT MAY BE REQUIRED TO COMPLETE THE JOB.

14. THE CONTRACTOR, UPON COMPLETION OF THE WORK, SHALL ARRANGE FOR DEPARTMENT OF BUILDINGS INSPECTIONS AND SIGN-OFFS REQUIRED TO COMPLETE THE JOB AND PROVIDE ALL CONTROLLED INSPECTIONS AS REQUIRED BY THE BUILDING DEPARTMENT FOR THIS PROJECT.

15. THE CONTRACTOR SHALL SUBMIT SHOP DRAWINGS SHOWING LAYOUT, PROFILES, METHODS OF JOINING AND ANCHORAGE DETAILS, INCLUDING MAJOR FINISHING AND TRIM UNITS. PROVIDE LAYOUTS AT 1/4" SCALE AND DETAILS AT 3" SCALE.

16. DIMENSIONS GOVERN - DRAWINGS ARE NOT TO BE SCALED.

13. ALL PIPING AND WIRING SHALL BE REMOVED TO A POINT OF CONNECTION AND SHALL BE PROPERLY CAPPED OR PLUGGED.




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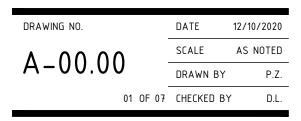
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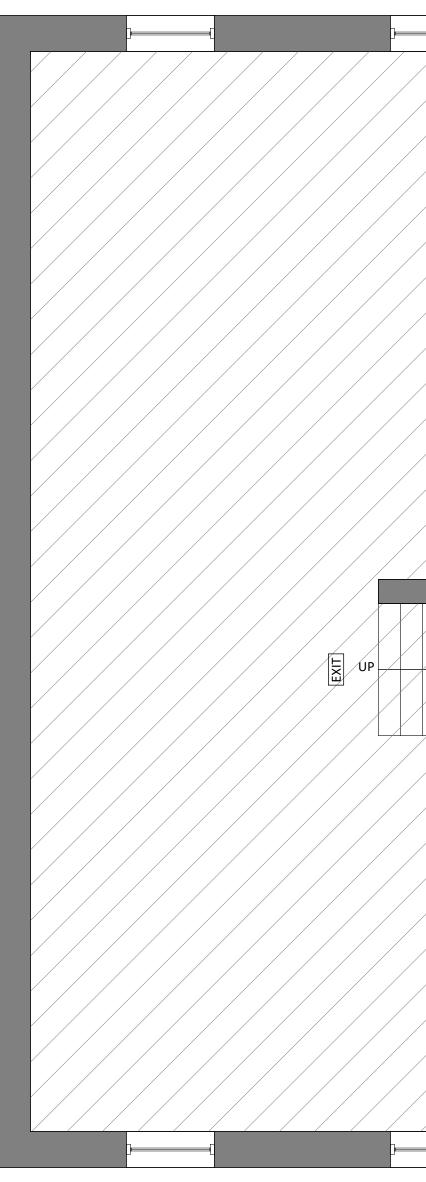
DRAWING TITLE


GENERAL INFORMATION & CODE ANALYSIS



	PROPERTY LINE
	INTERIOR PARTITIONS
● _{S/C}	SMOKE/CARBON MONOXIDE DETECTOR
CFM	MECHANICAL VENTILATION
EXIT	EXIT SIGN
EM.	EMERGENCY LIGHTING
X	DOOR TYPE
×	WALL TYPE
X	EQUIPMENT TYPE

SMOKE ALARM NOTE: AS PER BCNYS 907.2.10, SMOKE ALARMS WITHIN A DWELLING UNIT SHALL BE INTERCONNECTED IN SUCH A MANNER THAT THE ACTIVATION OF ONE ALARM WILL ACTIVATE ALL OF THE ALARMS IN THE INDIVIDUAL UNIT. SMOKE ALARMS SHALL RECEIVE THEIR PRIMARY POWER FROM THE BUILDING WIRING WHERE SUCH WIRING IS SERVED FROM A COMMERCIAL SOURCE AND SHALL BE EQUIPPED WITH A BATTERY BACKUP. SMOKE ALARMS SHALL EMIT A SIGNAL WHEN THE BATTERIES ARE LOW. WIRING SHALL BE PERMANENT AND WITHOUT A DISCONNECTING SWITCH OTHER THAN AS REQUIRED FOR OVERCURRENT PROTECTION.

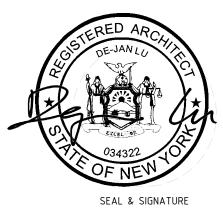

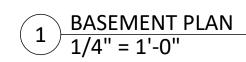

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● _{S/C}	
	2 1 S MECHANICAL VENTS TO ROOF
	NEW GAS FURNACES TO BE INSTALLED, SEÉ EQUIPMENT SCHEDULE
	NOT IN SCOPE

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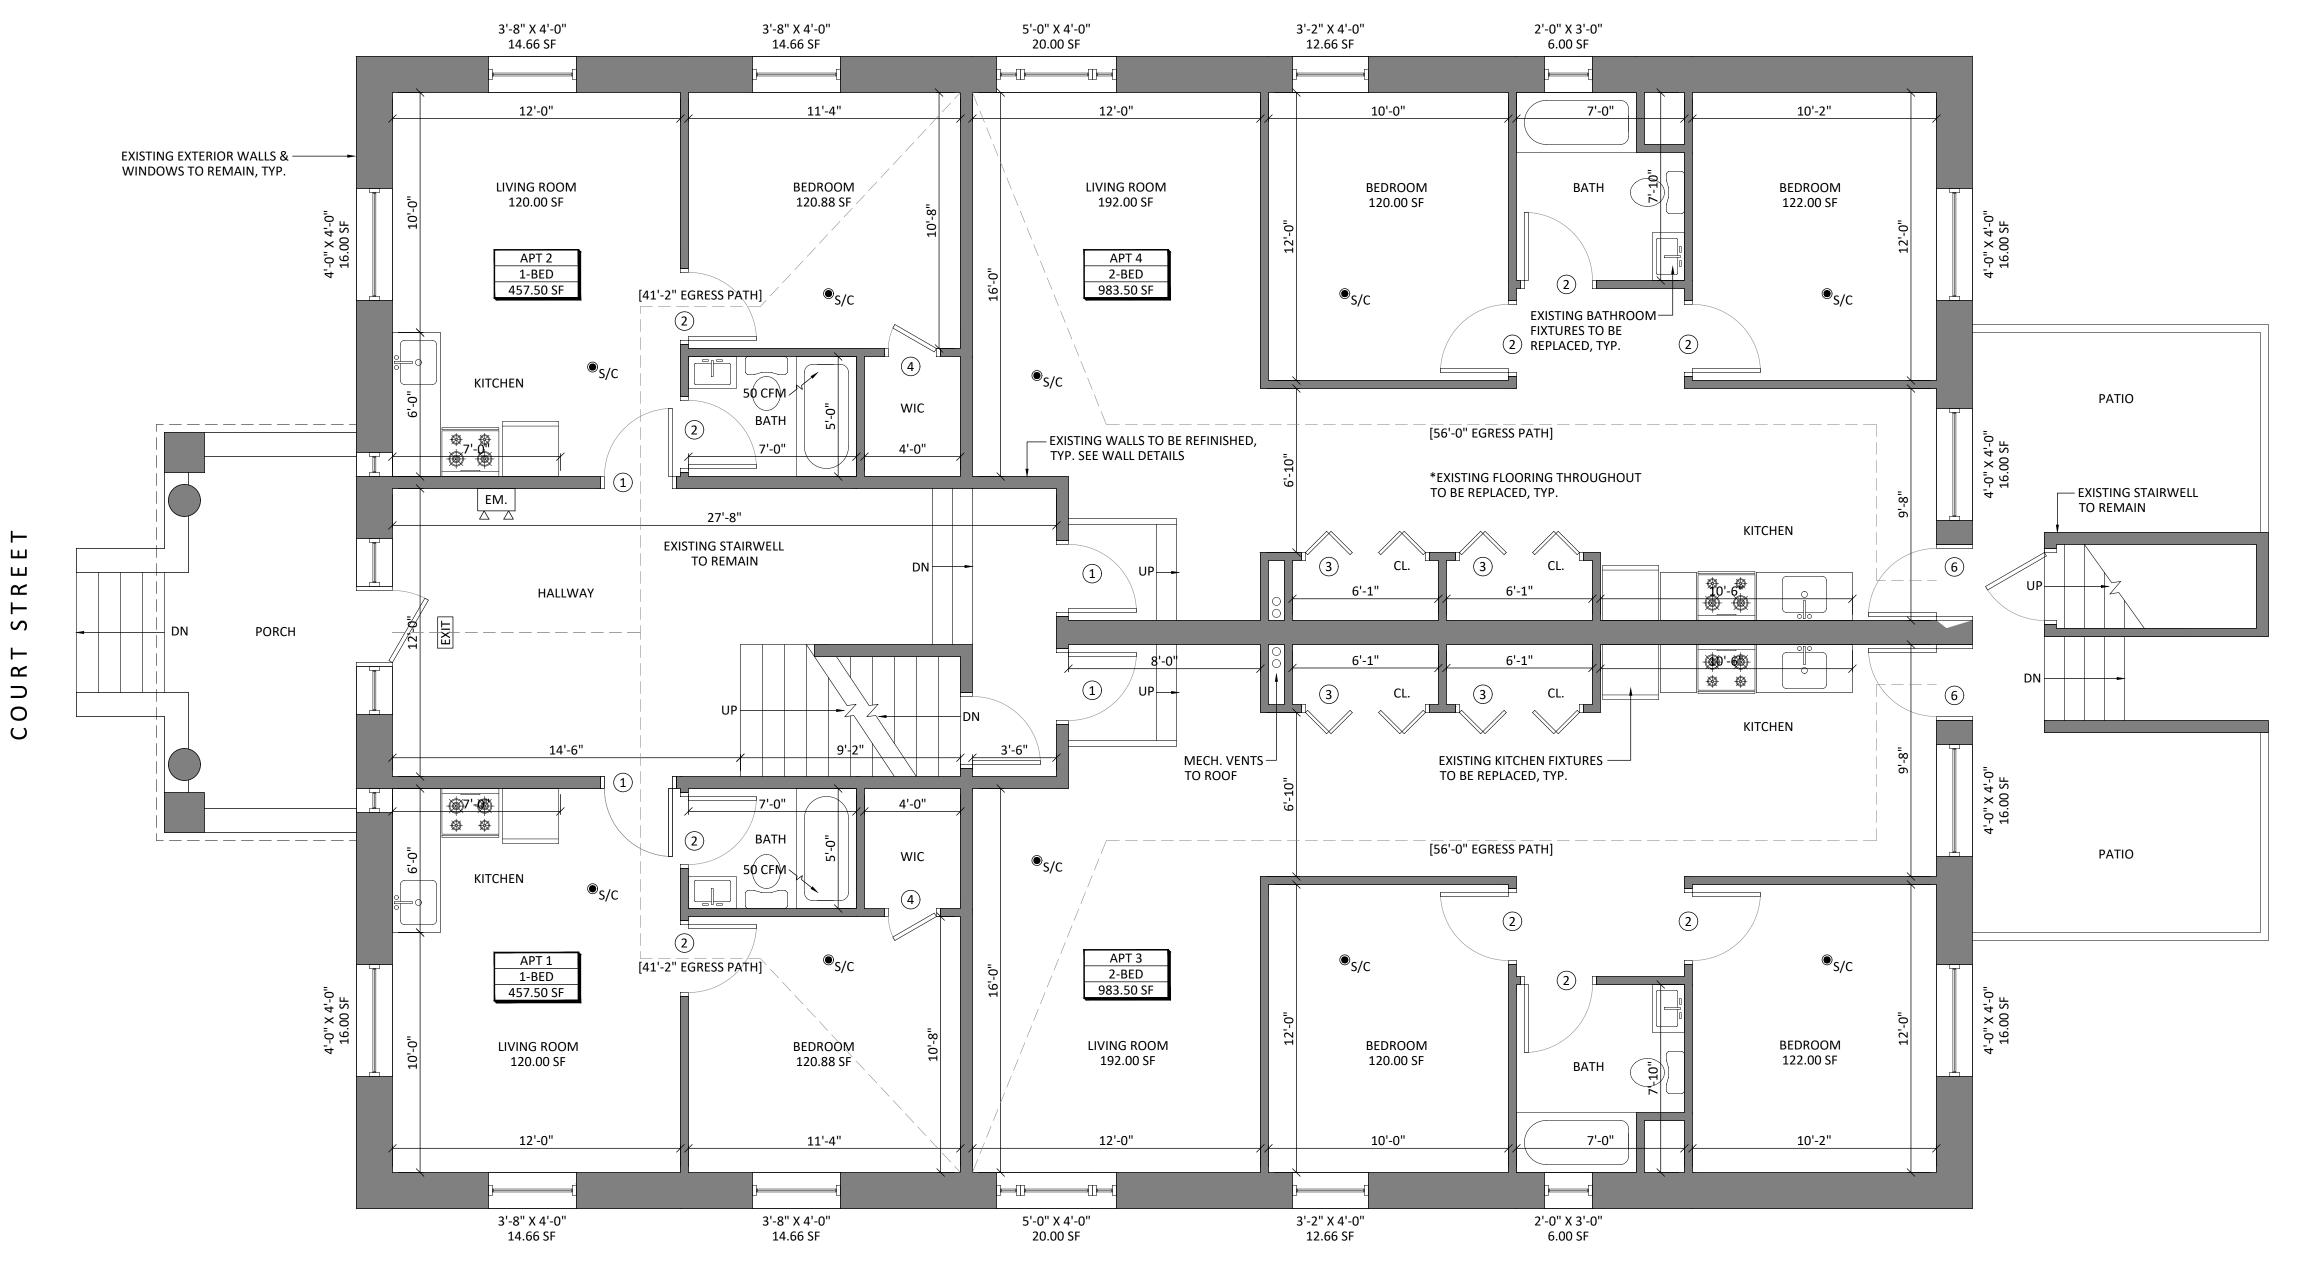


DRAWING TITLE

DRAWING NO.	DATE	12/10/2020
A-01.00	SCALE	AS NOTED
A-01.00	DRAWN BY	Ϋ́Ρ.Ζ.
02 OF 07	CHECKED B	Y D.L.

	PROPERTY LINE
	INTERIOR PARTITIONS
● _{S/C}	SMOKE/CARBON MONOXIDE DETECTOR
CFM	MECHANICAL VENTILATION
EXIT	EXIT SIGN
EM.	EMERGENCY LIGHTING
X	DOOR TYPE
\mathbf{x}	WALL TYPE
X	EQUIPMENT TYPE

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1 <u>1/4" = 1'-0"</u>



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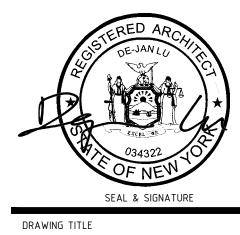
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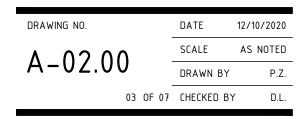
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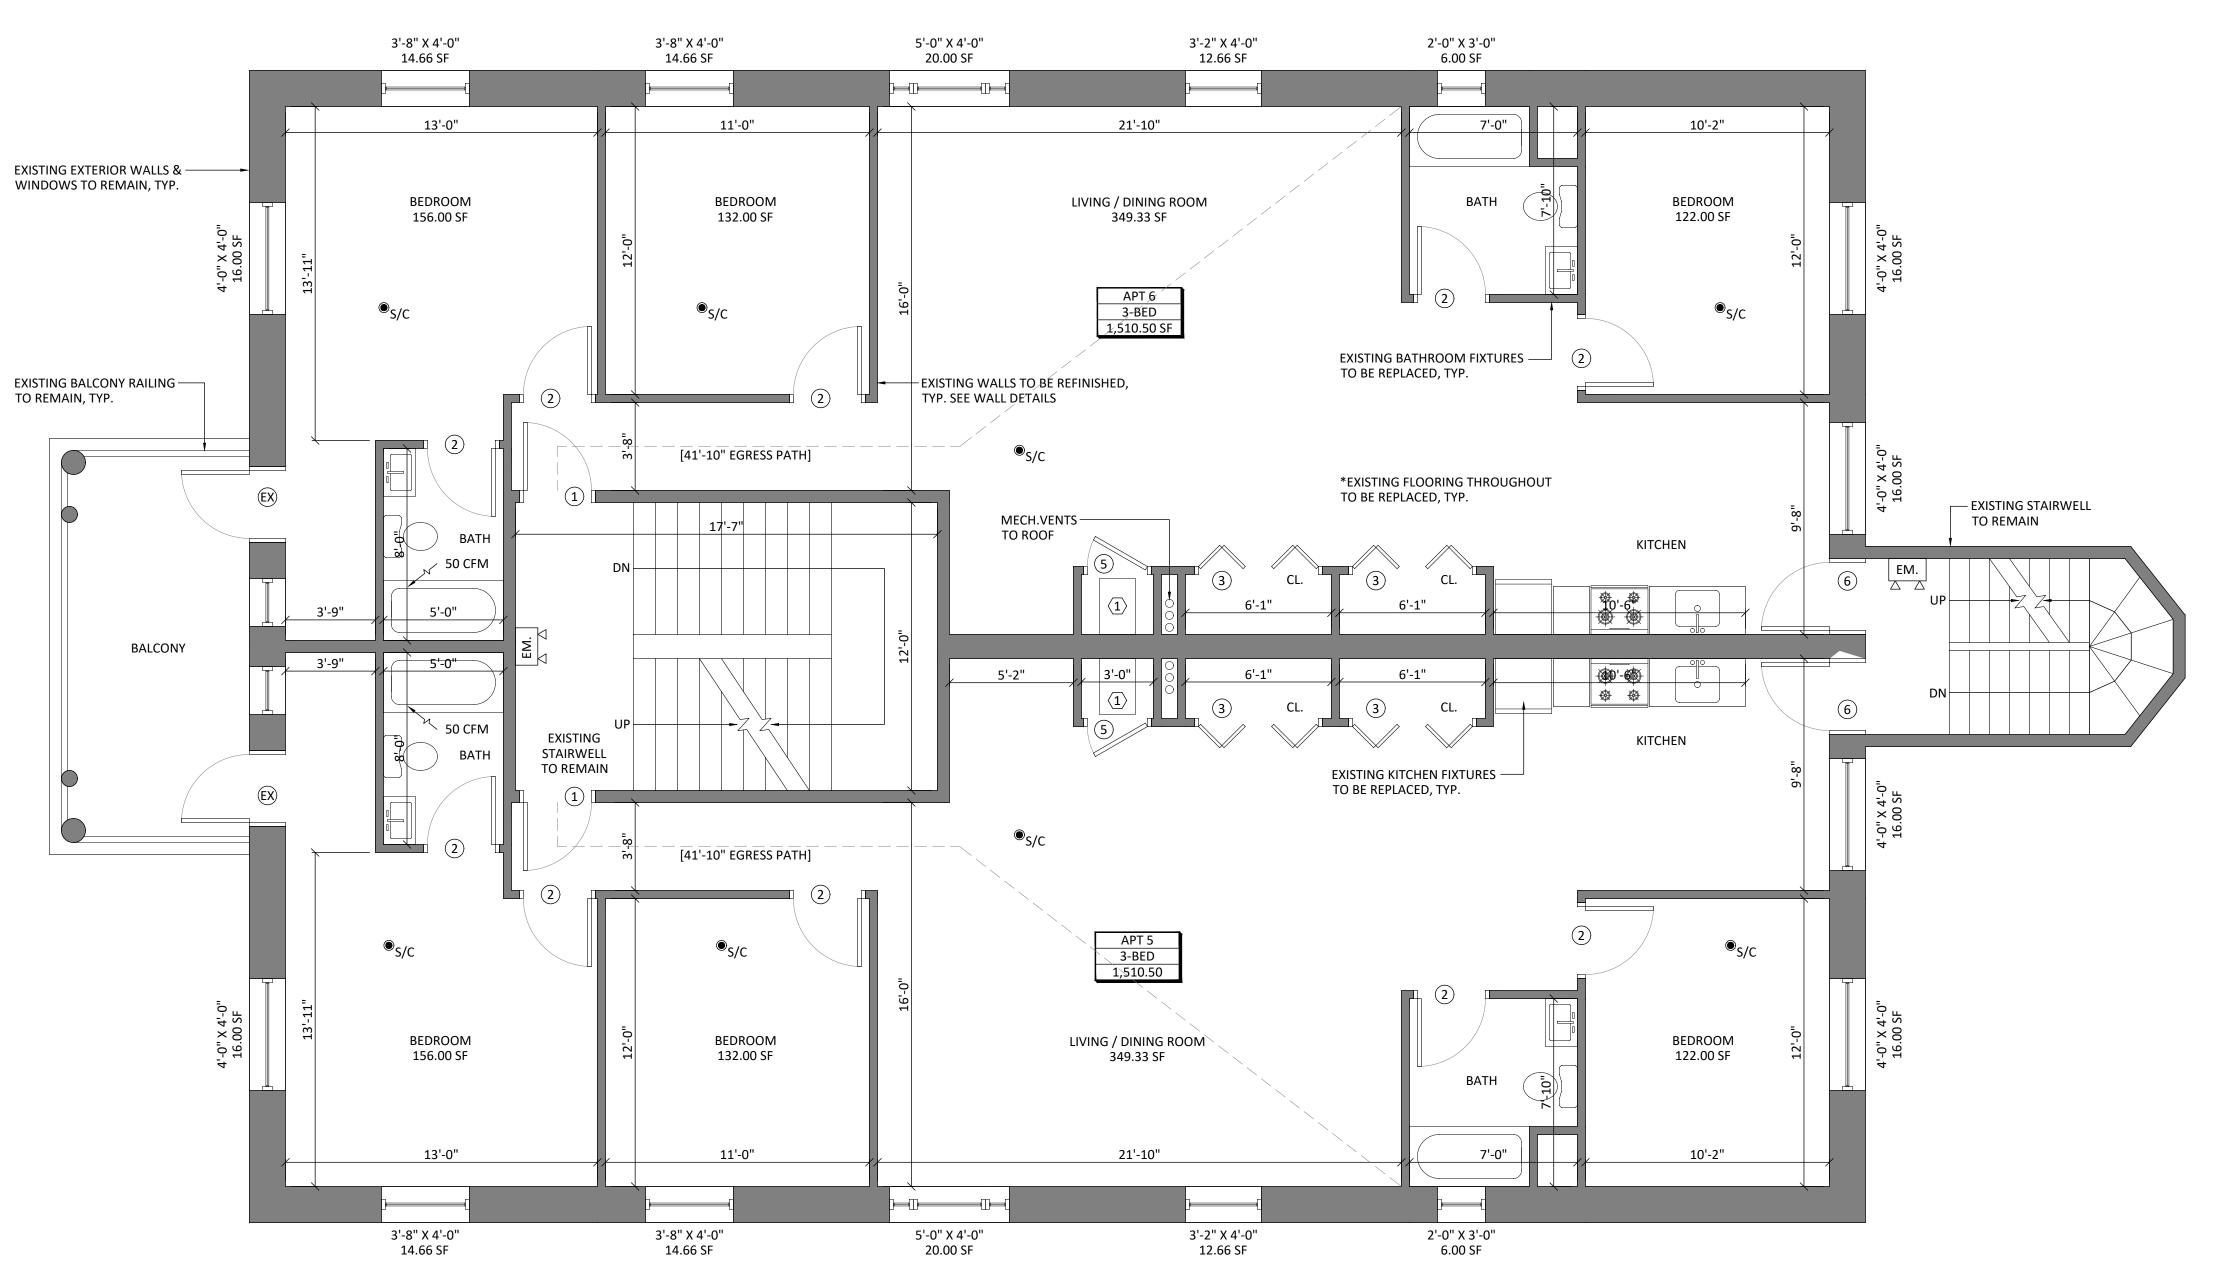


FIRST FLOOR PLAN



	PROPERTY LINE
	INTERIOR PARTITIONS
● _{S/C}	SMOKE/CARBON MONOXIDE DETECTOR
CFM	MECHANICAL VENTILATION
EXIT	EXIT SIGN
EM.	EMERGENCY LIGHTING
X	DOOR TYPE
X	WALL TYPE
X	EQUIPMENT TYPE

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1 2ND FLOOR PLAN 1/4" = 1'-0"

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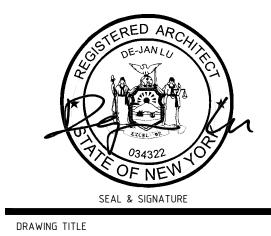
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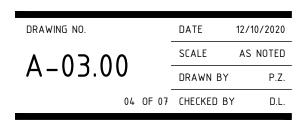
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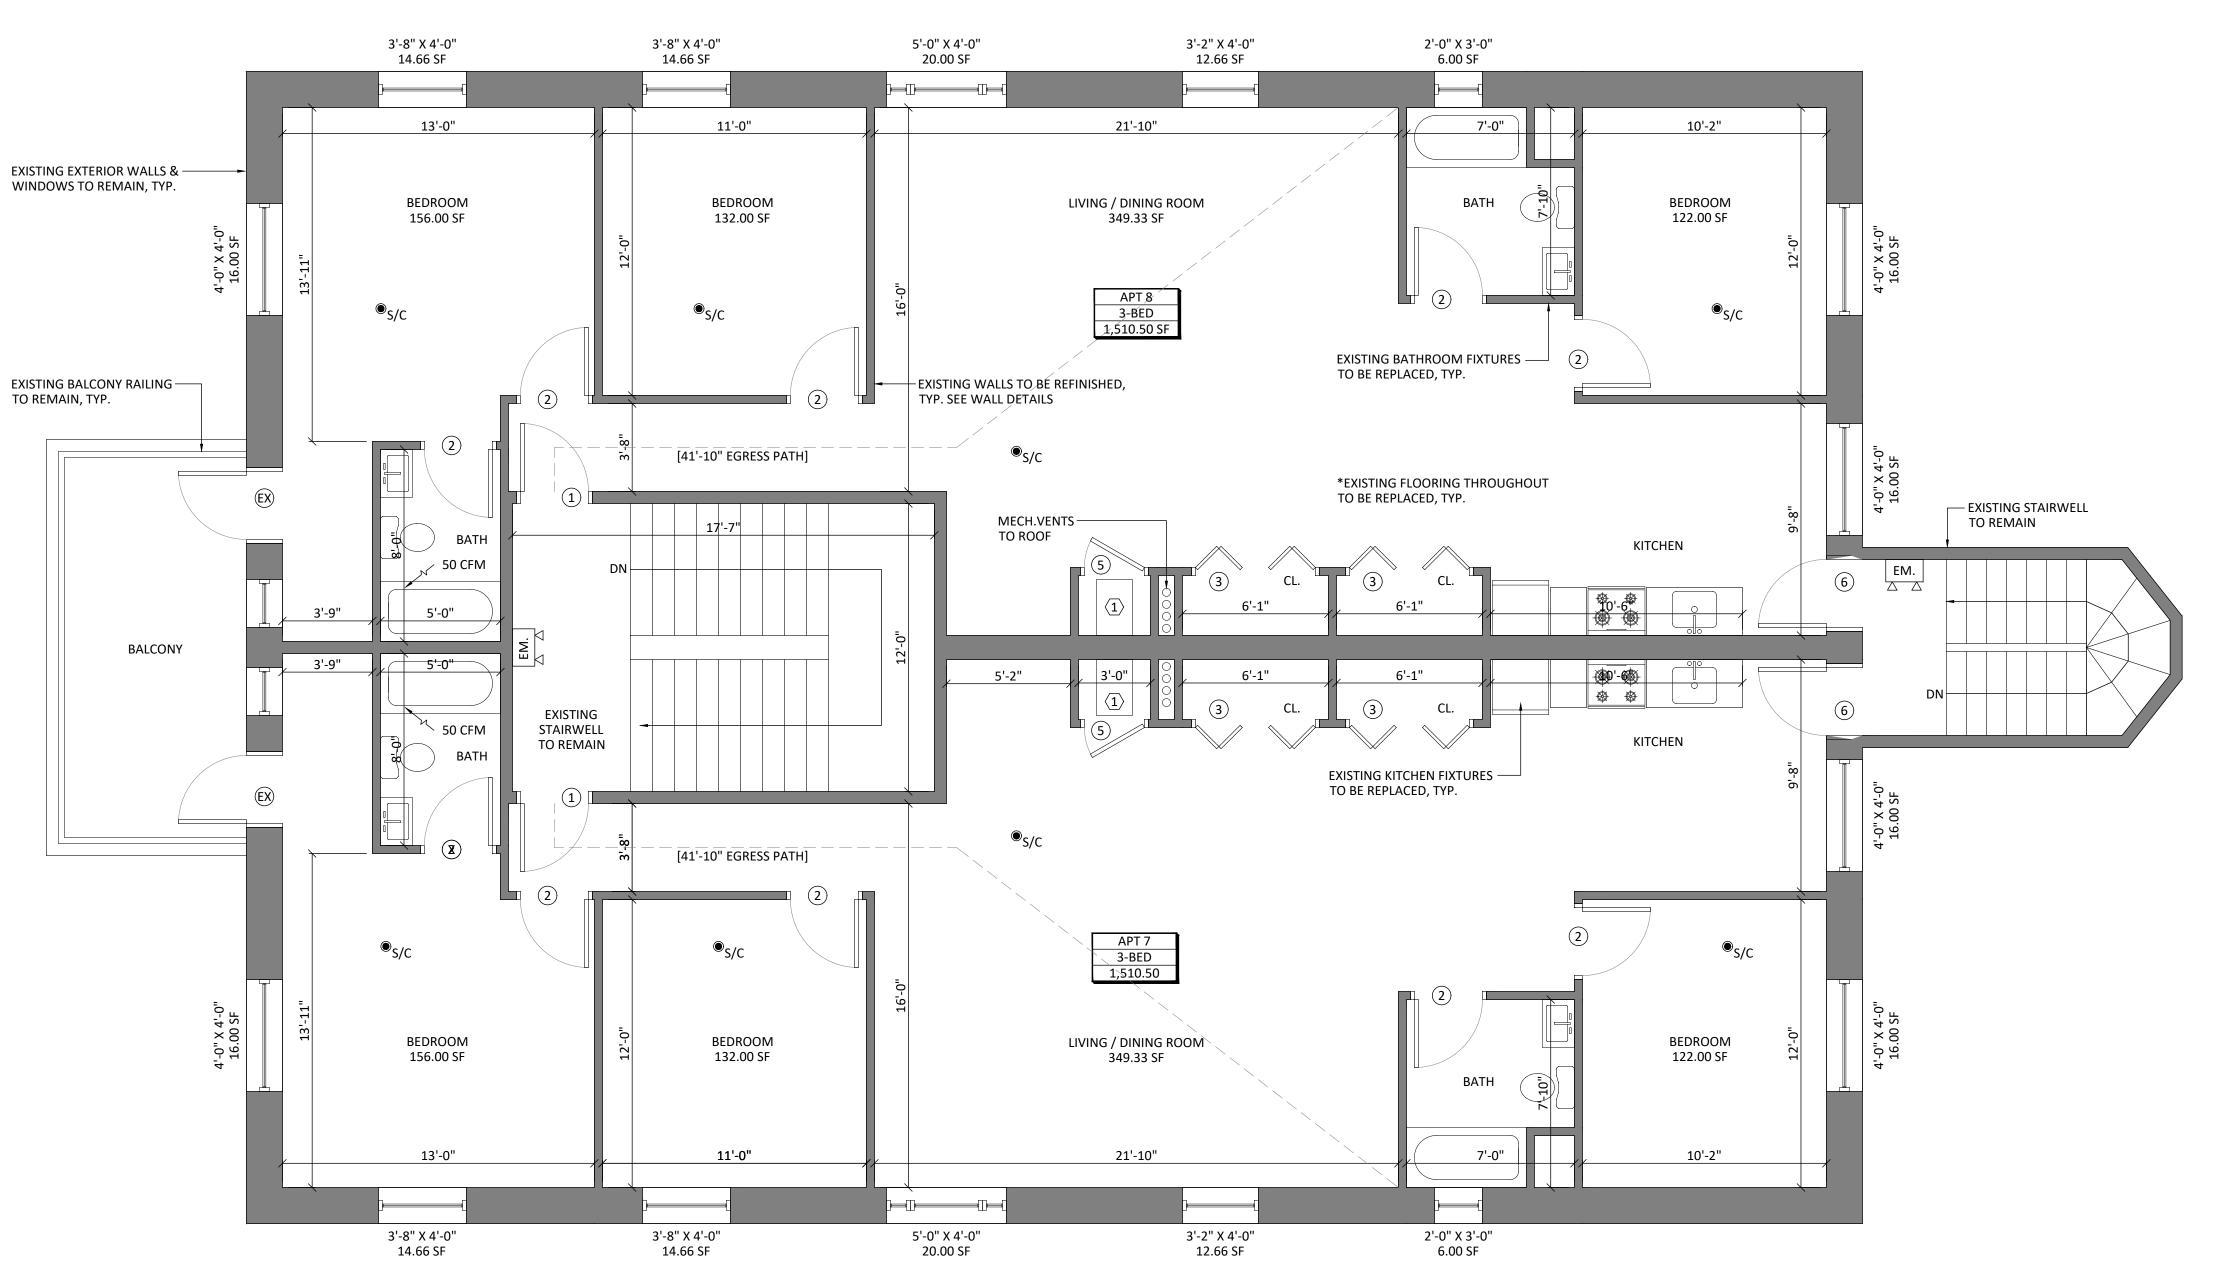


SECOND FLOOR PLAN



	PROPERTY LINE
	INTERIOR PARTITIONS
● _{S/C}	SMOKE/CARBON MONOXIDE DETECTOR
CFM	MECHANICAL VENTILATION
EXIT	EXIT SIGN
EM.	EMERGENCY LIGHTING
X	DOOR TYPE
\mathbf{x}	WALL TYPE
X	EQUIPMENT TYPE

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1 3RD FLOOR PLAN 1/4" = 1'-0"

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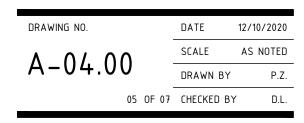
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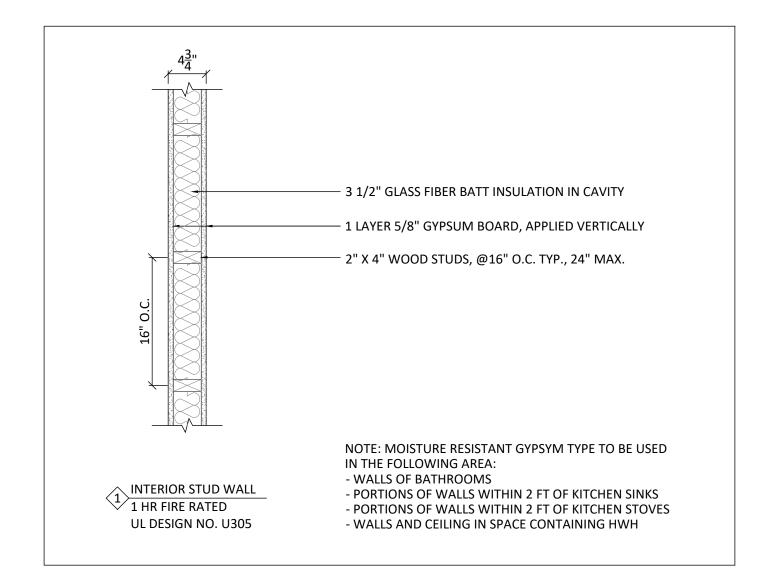
THIRD FLOOR PLAN




	DOOR SCHEDULE							
TAG	LOCATION	DOOR SIZE	DOOR MAT.	SWING	FRAME	FIRE RATING	SADDLE	REMARKS
	APARTMENT ENTRANCE	2'-10" X 7'-4"	H.M.	SINGLE	H.M.	3/4 HR	ALUM.	FPSC
2	BEDROOM & BATHROOM	2'-10" X 6'-8"	W.D.	SINGLE	W.D.		MARBLE	SADDLE AT BATH
3	CLOSET	(2) 2'-6" X 6'-8"	W.D.	DBL. BI-FOLD	W.D.			
4	WALK IN CLOSET	2'-0" X 6'-8"	W.D.	SINGLE	W.D.			
5	HVAC CLOSET	2'-6" X 6'-8"	W.D.	SINGLE	W.D.			
6	EXTERIOR DOOR	2'-10" X 7'-4"	H.M.	SINGLE	H.M.			FPSC, U-FACTOR = 0.61

EQUIPMENT SCHEDULE

TAG	MANUFACTURER	MODEL NUMBER	DIMENSION	QUANTITY	CAPACITY	EFFICIENCY
$\langle 1 \rangle$	GIBSON	KG7SC054DT24B1	34-1/2 X 17-1/2 X 28"	6	54,000 BTU/h	92.1% AFUE
2	GIBSON	KG7SC038DT23A1	34-1/2 X 17-1/2 X 28"	2	38,000 BTU/h	92.1% AFUE



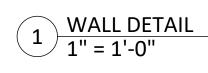


1 SANITARY RISER 1/4" = 1'-0"

C.O.

4" VTR |||

_____ _ _ _____

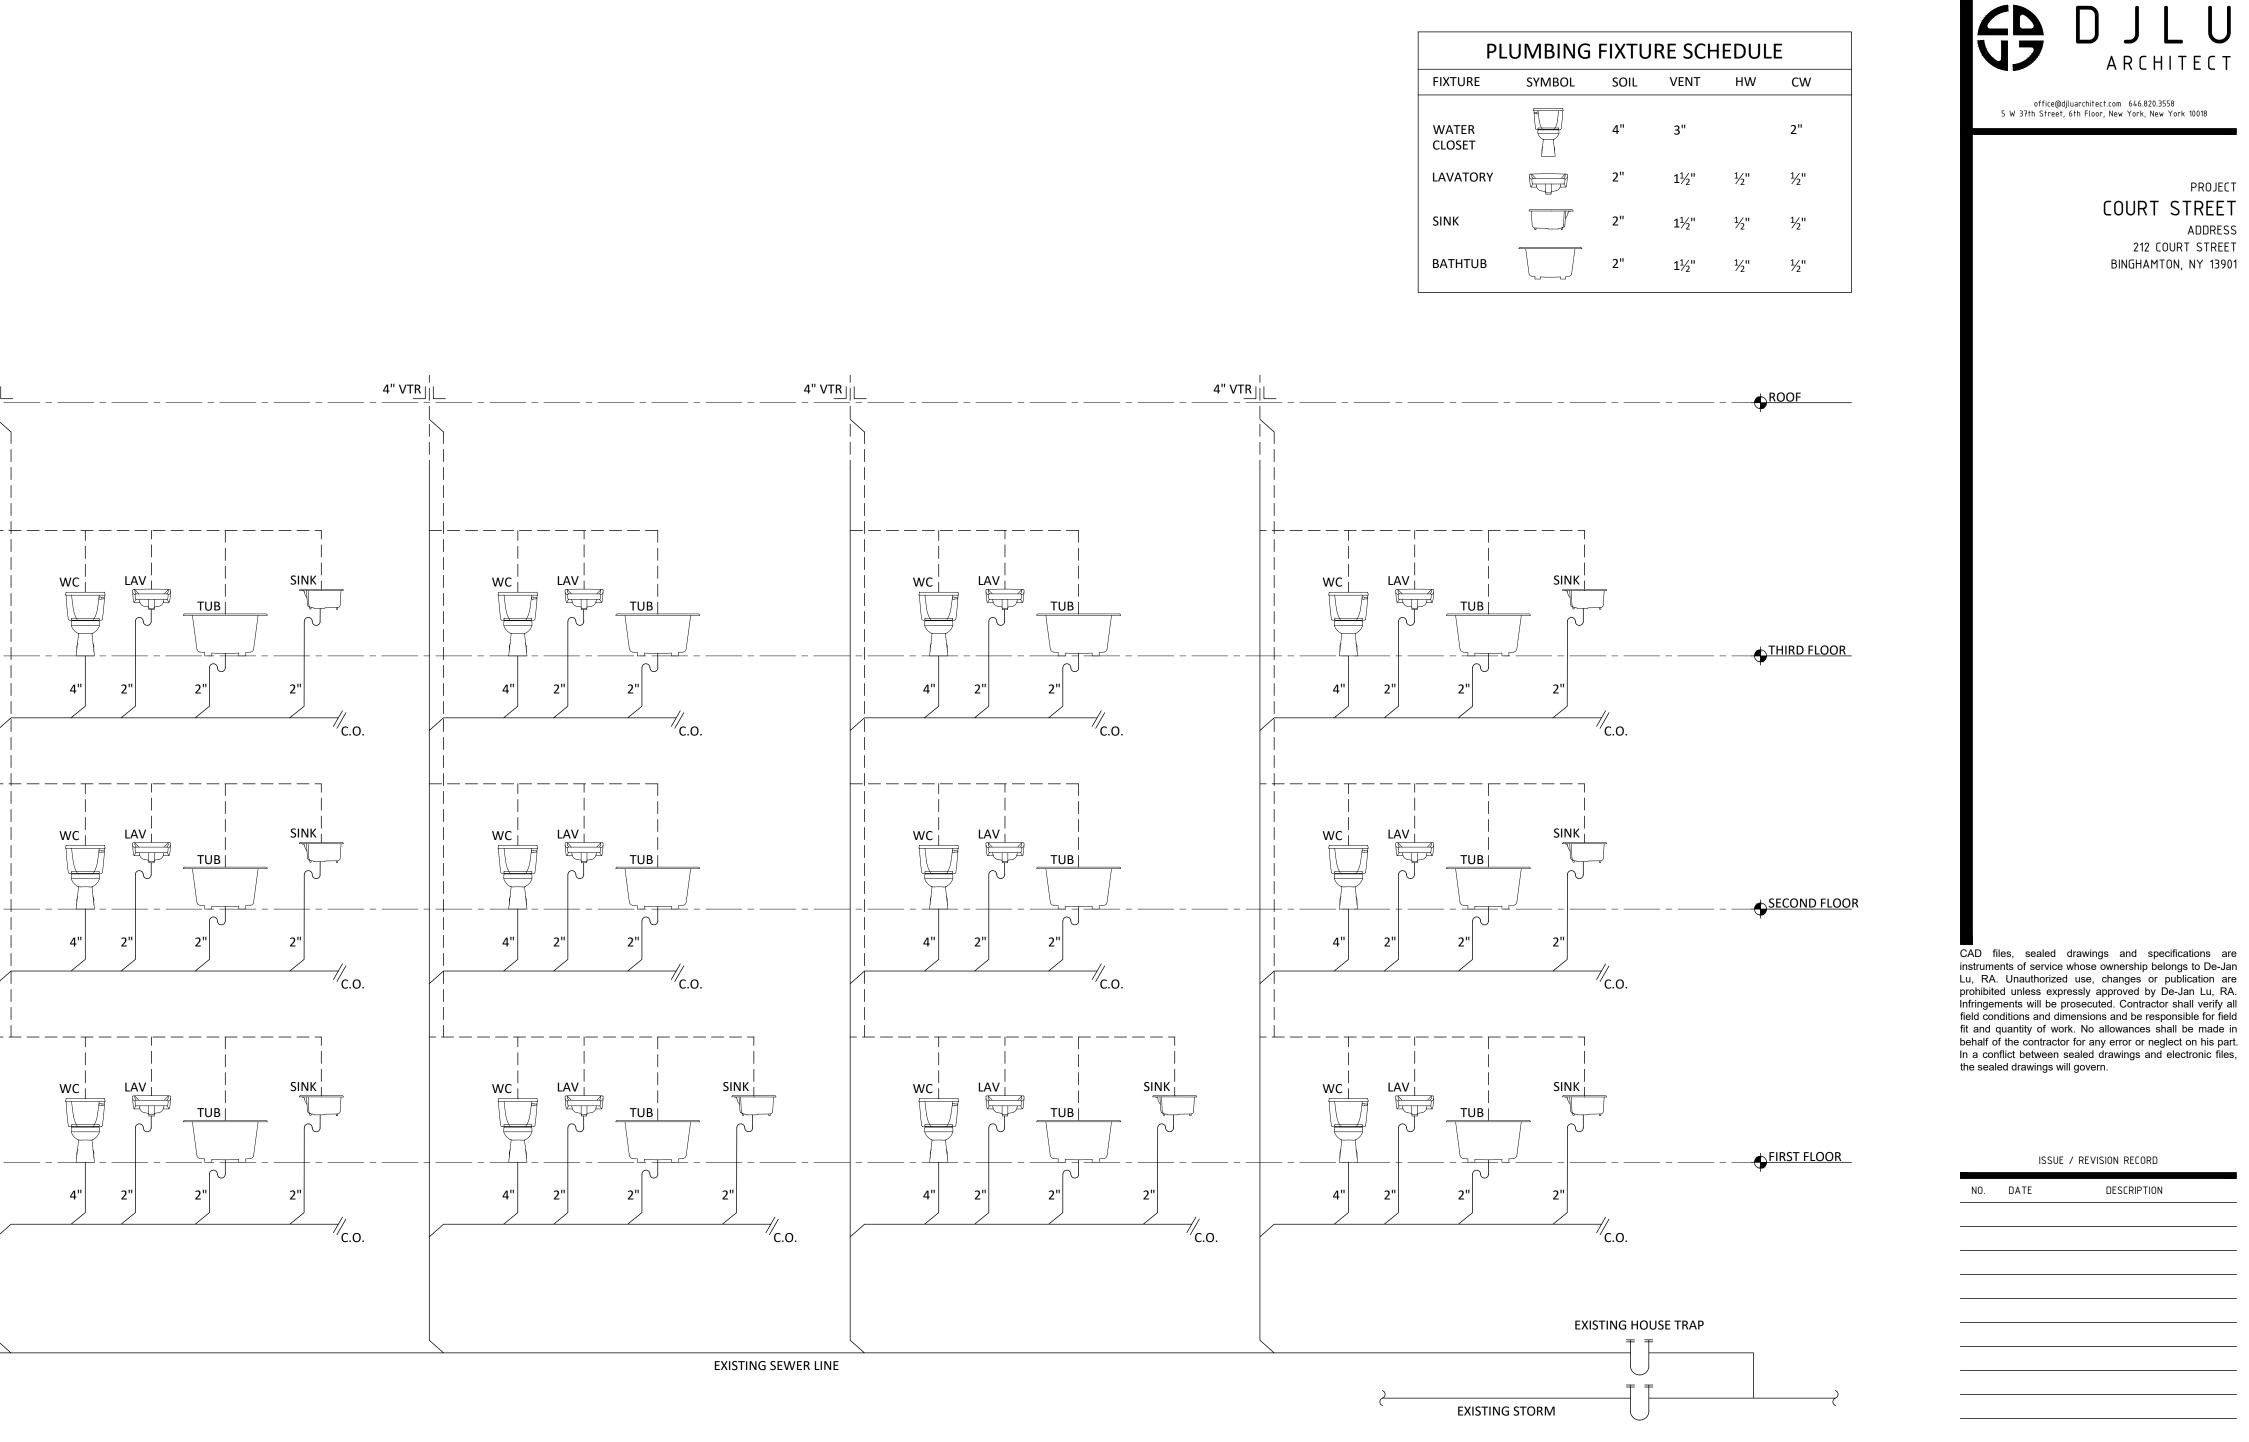




DRAWING TITLE WALL DETAILS, SCHEDULES, AND SANITARY RISER


DRAWING NO.		DATE	12/10/2020
A-05.00	SCALE	AS NOTED	
A-05.00	-	DRAWN BY	P.Z.
06 OF	07	CHECKED BY	′ D.L.



2 2ND FLOOR PLAN 1/8" = 1'-0"

1 <u>1/8" = 1'-0"</u>

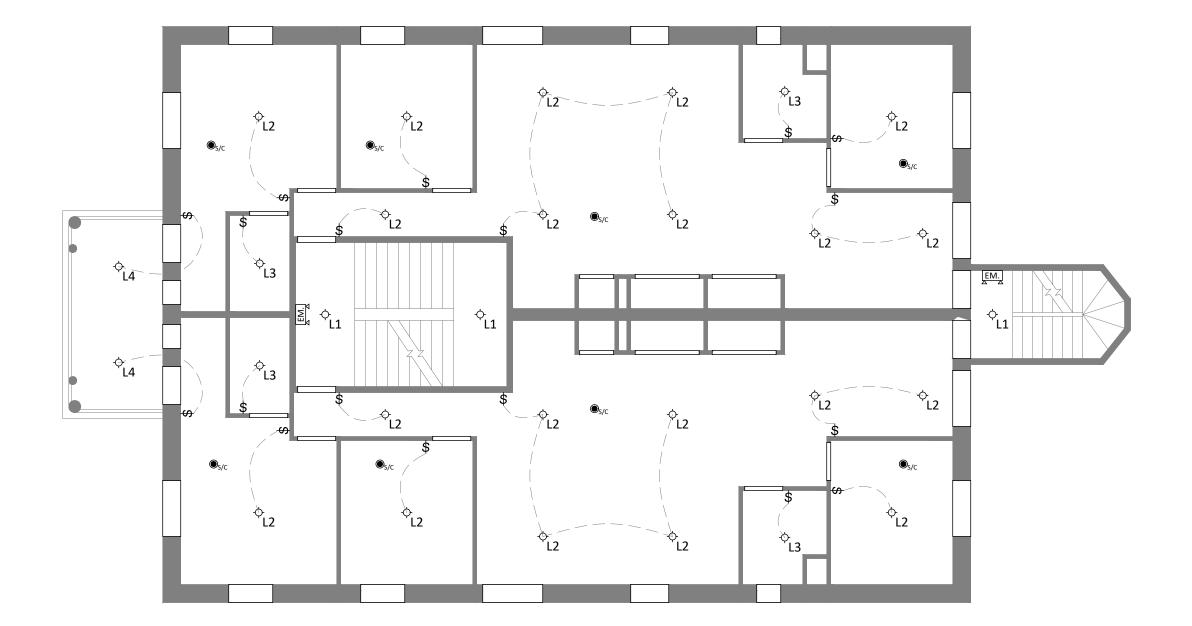

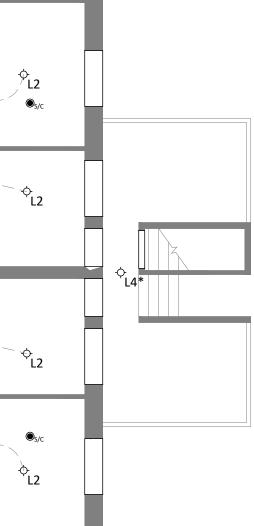

LEGEND

- (-	LIGHTING FIXTURE; SEE SCHEDULE
\$	ELECTRICAL SWITCH
● _{S/C}	SMOKE/CARBON MONOXIDE DETECTOR
♦EXIT	EMERGENCY EXIT SIGN
	EMERGENCY LIGHTING FIXTURE


LIGHTING SCHEDULE

	FIXTURE TYPE			
		BULB	WATTAGE	
L1	CEILING MOUNTED DOWN LIGHTING	2 X SELF-BALLASTED CFL	46W	
L2	CEILING MOUNTED DOWN LIGHTING	SELF-BALLASTED CFL	23W	
L3	CEILING MOUNTED DOWN LIGHTING	SELF-BALLASTED CFL	13W	
L4*	EXTERIOR LIGHTING	INTEGRATED LED	13W	
EXIT SIGN			5W	

LIGHTING NOTES: - 2020 ECCCNYS R404.1: NOT LESS THAN 90 PERCENT OF THE PERMANENTLY INSTALLED LIGHTING FIXTURES SHALL CONTAIN ONLY HIGH-EFFICACY LAMPS. - 2020 BCNYS 1204.3: ALL SPACES SHALL HAVE AN AVERAGE ILLUMINATION OF 10 FOOTCANDLES OVER THE AREA OF THE ROOM AT A HEIGHT OF 30 INCHES ABOVE THE FLOOR LEVEL. - 2020 BCNYS 1204.4: EXTERIOR STAIRWAYS SERVING A DWELLING UNIT SHALL HAVE A ILLUMINATION LEVEL

ON TREAD RUNS OF NOT LESS THAN 1 FOOTCANDLES.

*DAYLIGHT SHUTOFF: LIGHTS SHALL BE AUTOMATICALLY TURNED OFF WHEN DAYLIGHT IS PRESENT AND SATISFIES LIGHTING NEEDS.

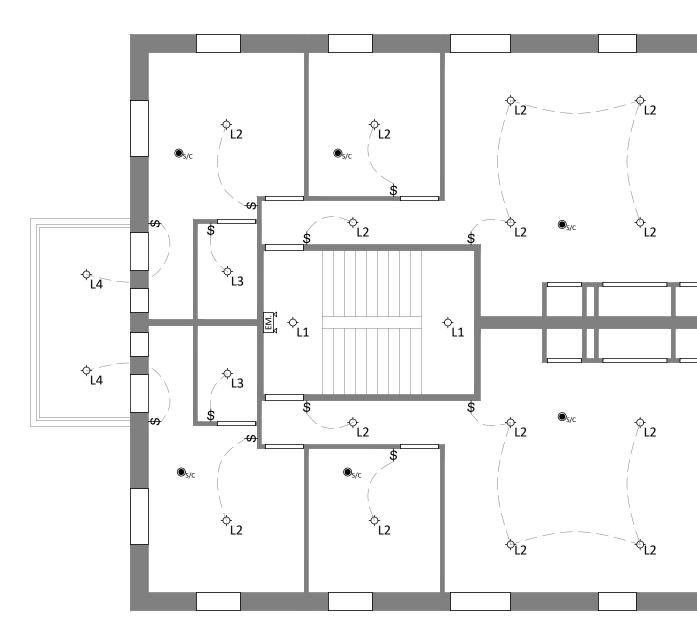

3 3RD FLOOR PLAN 1/8" = 1'-0"

LU ARCHITECT

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¢L3 ⁹L2 ●_{S/C} ¢_____¢__2 EM. ●_{S/C} °≎ L2 ^фіз

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ISSUE / REVISION RECORD

NO. DATE DESCRIPTION



REFLECTED CEILING PLANS

