



3 ENLARGED PLAN - NURSES STATION
Scale: 3/8" = 1'-0"

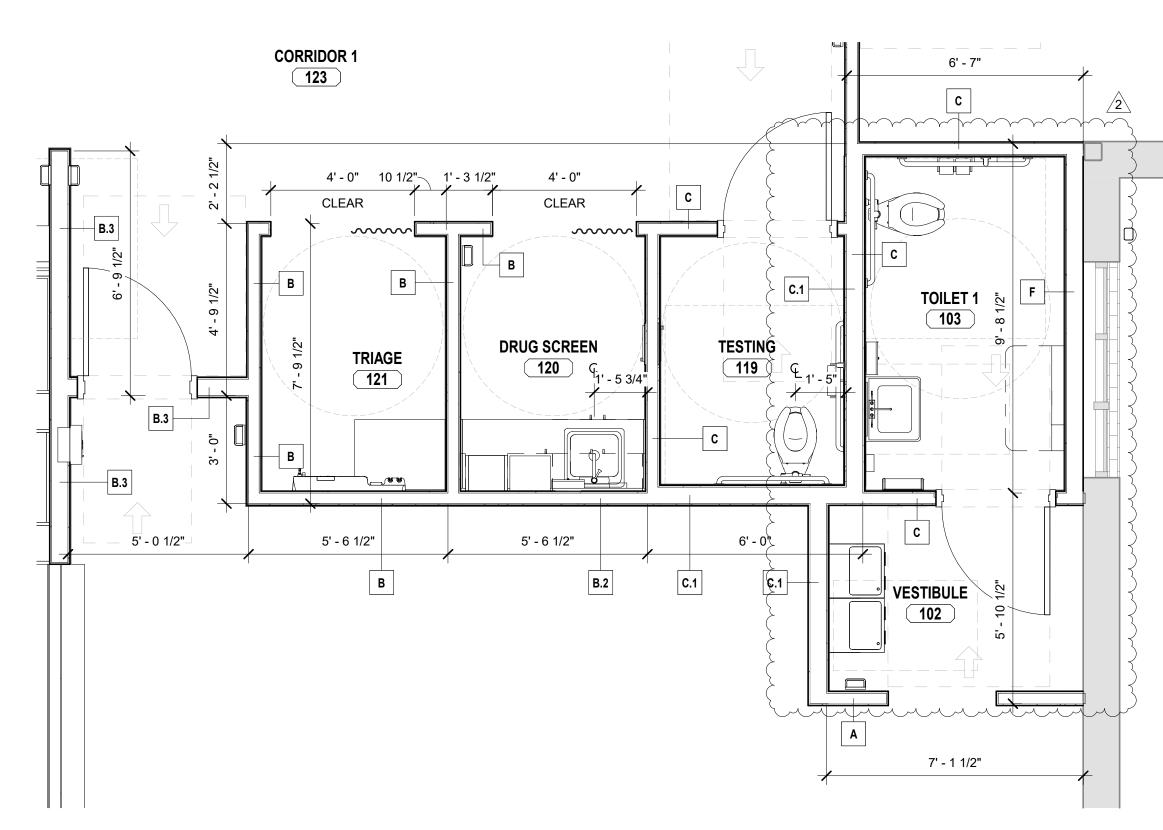

2 ENLARGED PLAN - 121, 120, 119
Scale: 3/8" = 1'-0"

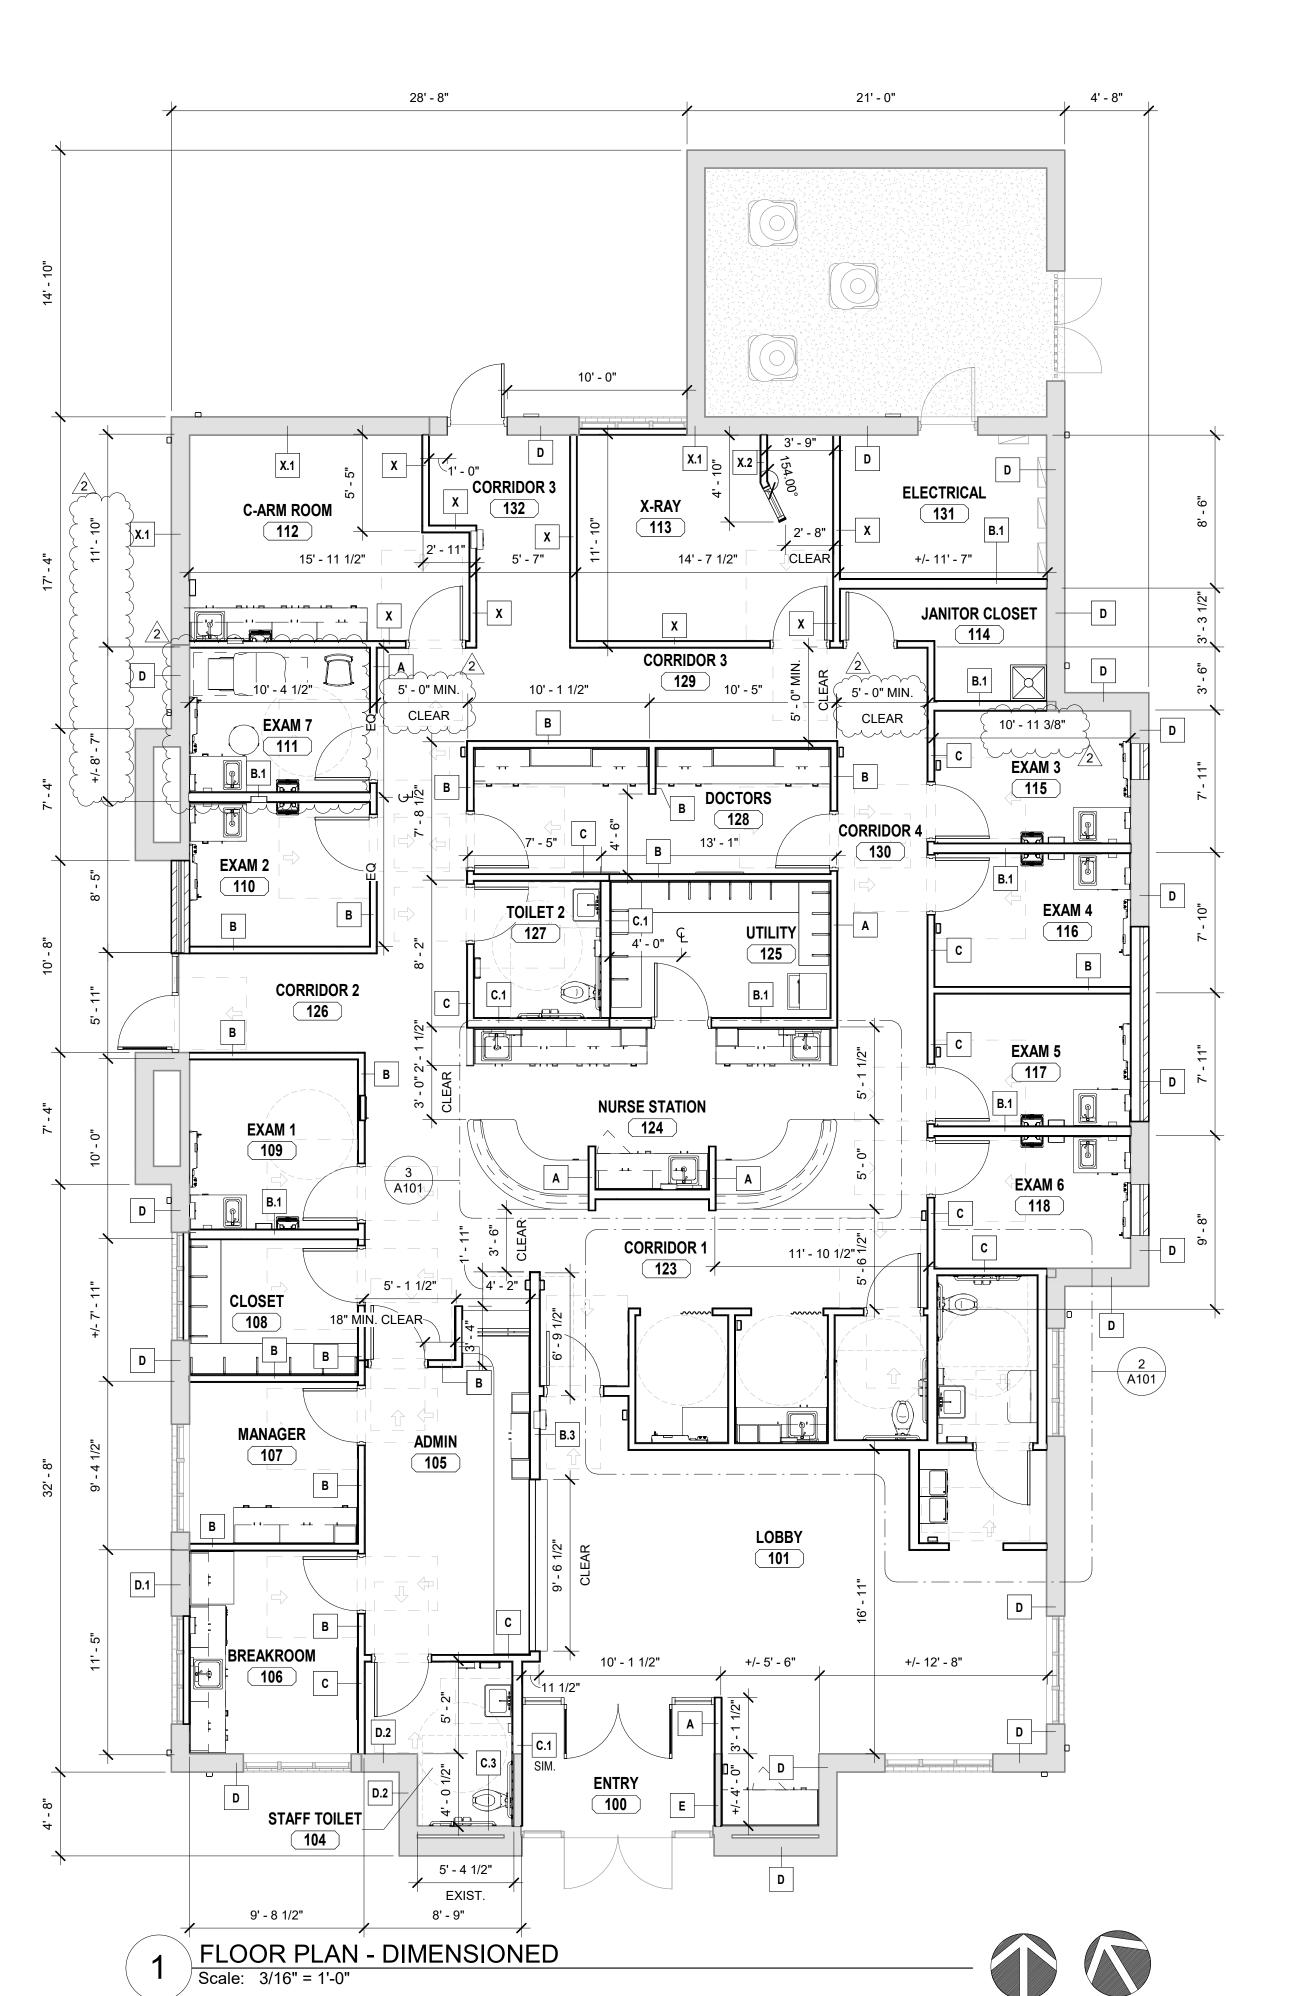


DIMENSION NOTES

- 1. THE CONTRACTOR SHALL TAKE FIELD MEASUREMENTS TO VERIFY FIELD CONDITIONS AND SHALL CAREFULLY COMPARE SUCH FIELD MEASUREMENTS, CONDITIONS, AND OTHER INFORMATION KNOWN TO THE CONTRACTOR WITHIN THE CONTRACT DOCUMENTS BEFORE COMMENCING ACTIVITIES. ERRORS, INCONSISTENCIES OR OMISSIONS DISCOVERED SHALL BE REPORTED TO THE ARCHITECT AT ONCE.
- 2. THE CONTRACTOR SHALL NOT SCALE THE DRAWINGS. DIMENSIONS ARE NOT ADJUSTABLE UNLESS NOTED WITH A PLUS/MINUS TOLERANCE.
- 3. "ALIGN" MEANS ALIGNMENT OF SIMILAR COMPONENTS OF CONSTRUCTION (I.E. WALLS, JAMBS, ETC.) WHICH ARE ADJACENT OR IN LINE WITH EACH OTHER ACROSS VOIDS.
- 4. "TYPICAL" (TYP.) MEANS IDENTICAL FOR ALL CONDITIONS WHICH MATCH THE ORIGINAL CONDITION INDICATED UNLESS OTHERWISE NOTED.
- 5. "SIMILAR" (SIM) MEANS COMPARABLE CHARACTERISTICS FOR THE CONDITION NOTED. VERIFY DIMENSIONS AND ORIENTATION OF CONDITIONS WHICH MAY VARY FROM TYPICAL OR SIMILAR
- 6. "OPPOSITE HAND" (OPH) MEANS CONDITION NOTED IS THE MIRROR IMAGE OF THE DETAIL
- 7. ALL ROUGH OPENING DIMENSIONS FOR WINDOWS AND DOORS SHALL BE FIELD VERIFIED PRIOR TO UNIT FABRICATION OR INSTALLATION.
- 8. CASEWORK DIMENSIONS SHALL BE FIELD VERIFIED BEFORE UNIT FABRICATION OR
- 9. ALL FLOOR TO FLOOR AND CEILING HEIGHTS ARE DIMENSIONED FROM FINISHED FLOOR.
- 10. REFERENCE CIVIL TO COORDINATE EXTERIOR SPOT ELEVATIONS AT EGRESS.
- 11. COORDINATE WITH SECTIONS, ELEVATIONS, DETAILS AND MANUFACTURER'S INSTALLATION CRITERIA TO PROVIDE ADDITIONAL BLOCKING IN WALLS AS NECESSARY.
- 12. DOORS ARE TO BE INSTALLED 4" FROM HINGE EDGE TO NEAREST INTERSECTING WALL -TYPICAL U.N.O.
- 13. ALL INT

CONDITIONS INDICATED.

14. PROVID MOUNTED 7 EQUIPMEN7

	ACCESSIBLE GRAB BARS, MILLWORK, WALL ACCESSORIES AS WELL AS WALL MOUNTED
	WALL TYPE LEGEND
А	INTERIOR WALL - 2 X 4 STUDS AT 16" O.C. MAX WITH 5/8" PTD GWB ON EACH SIDE. EXTEND 4" ABOVE CEILING, BRACE TO UNDERSIDE OF WOOD TRUSSES ABOVE.
В	INTERIOR WALL - 2 X 4 STUDS AT 16" O.C. MAX WITH 5/8" PTD GWB ON EACH SIDE AND SOUND ATTENUATION BATT INSULATION. EXTEND WALL 4" ABOVE CEILING, BRACE TO UNDERSIDE OF WOOD TRUSSES ABOVE.
B.1	B.1 SIMILAR TO B WITH 2 X 6 STUD WALL AND MOISTURE RESISTANT 5/8" GWB AT WET WALL.
B.2	B.2 SIMILAR TO B WITH MOISTURE RESISTANT 5/8" GWB AT WET WALL.
B.3	B.3 SIMILAR TO B WITH 2 X 6 STUD WALL.
С	INTERIOR WALL - 2 X 4 STUDS AT 16" O.C. MAX. WITH 5/8" PTD GWB ON NON-RESTROOM SIDE. ON RESTROOM SIDE, WALL TILE UP TO APPROX. 4' - 11" A.F.F. (SEE FINISH PLANS) - PROVIDE 5/8" TILE BACKER BOARD UP TO TOP OF TILE, MOISTURE RESISTANT 5/8" PTD GWB ABOVE TILE. PROVIDE SOUND ATTENUATION BATT INSULATION AT ALL WALL CAVITIES.
C.1	C.1 SIMILAR TO C WITH 2 X 6 STUDS (EXISTING STUDS @ SIM.)
C.2	C.2 SAME AS C WITH WALL TILE UP TO APPROX. 4' - 11" A.F.F., PROVIDE 5/8" TILE BACKER BOARD UP TO TOP OF TILE, MOISTURE RESISTANT 5/8" PTD GWB ABOVE TILE, BOTH SIDES OF WALL
C.3	C.3 SIMILAR TO C WITH 2 X 6 STUDS AND NO GWB ON NON-RESTROOM SIDE.
D	EXISTING 2 X 6 EXTERIOR WOOD STUD WALL. INFILL CAVITY WITH R-19 BATT INSULATION FOR AREAS WHERE MISSING. PROVIDE 5/8" GWB TO BOTTOM OF HARD LID CEILING OR 4" ABOVE DROP CEILING.
D.1	D.1 SIMILAR TO D WALL WITH MOISTURE RESISTANT 5/8" GWB AT WET WALL.
D.2	D.2 SIMILAR TO D WALL. INSTALL WALL TILE UP TO APPROX. 4'-11" A.F.F., PROVIDE 5/8" TILE BACKER BOARD UP TO TOP OF TILE, MOISTURE RESISTANT 5/8" PTD. GWB ABOVE TILE
Е	EXISTING WOOD STUD WALL. PROVIDE 5/8" PTD GWB BOTH SIDES
F	EXISTING 2 X 6 EXTERIOR STUD WALL WITH NEW INTERIOR 2 X 6 STUD FUR-OUT. INFILL CAVITY IN EXTERIOR STUD WITH R-19 BATT INSULATION WHERE MISSING. INSTALL WALL TILE UP TO APPROX. 4'-11" A.F.F., PROVIDE 5/8" TILE BACKER BOARD UP TO TOP OF TILE, MOISTURE RESISTANT 5/8" PTD GWB ABOVE TILE.
X	INTERIOR WALL - 2 X 4 STUDS AT 16" O.C. MAX. WITH 5/8" PTD GWB ON EACH SIDE AND 3-1/2" SOUND ATTENUATION BATT INSULATION. EXTEND WALL 4" ABOVE CEILING, BRACE TO UNDERSIDE OF WOOD TRUSSES ABOVE. PROVIDE 1/16" LEAD SHEET LINING TO 7'-0" HIGH A.F.F. AT INTERIOR SIDE OF WALL UNDER GWB.
X.1	X-1 SAME AS X WITH EXISTING STUD WALL TO REMAIN.
X.2	X-2 SAME AS X WITH 1/8" LEAD SHEET LINING.

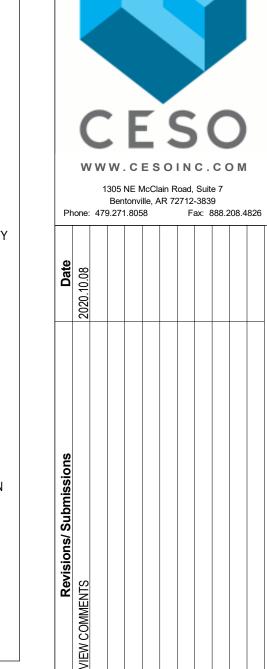

David Heard 10/19/2020 Final Approval Subject to Field Inspect

REVISION 1 AND 2

PHARETTA


DIMENSIONED FLOOR PLAN -GROUND **FLOOR**

757942-01

2020.10.08

As indicated MRC, AHS

A101

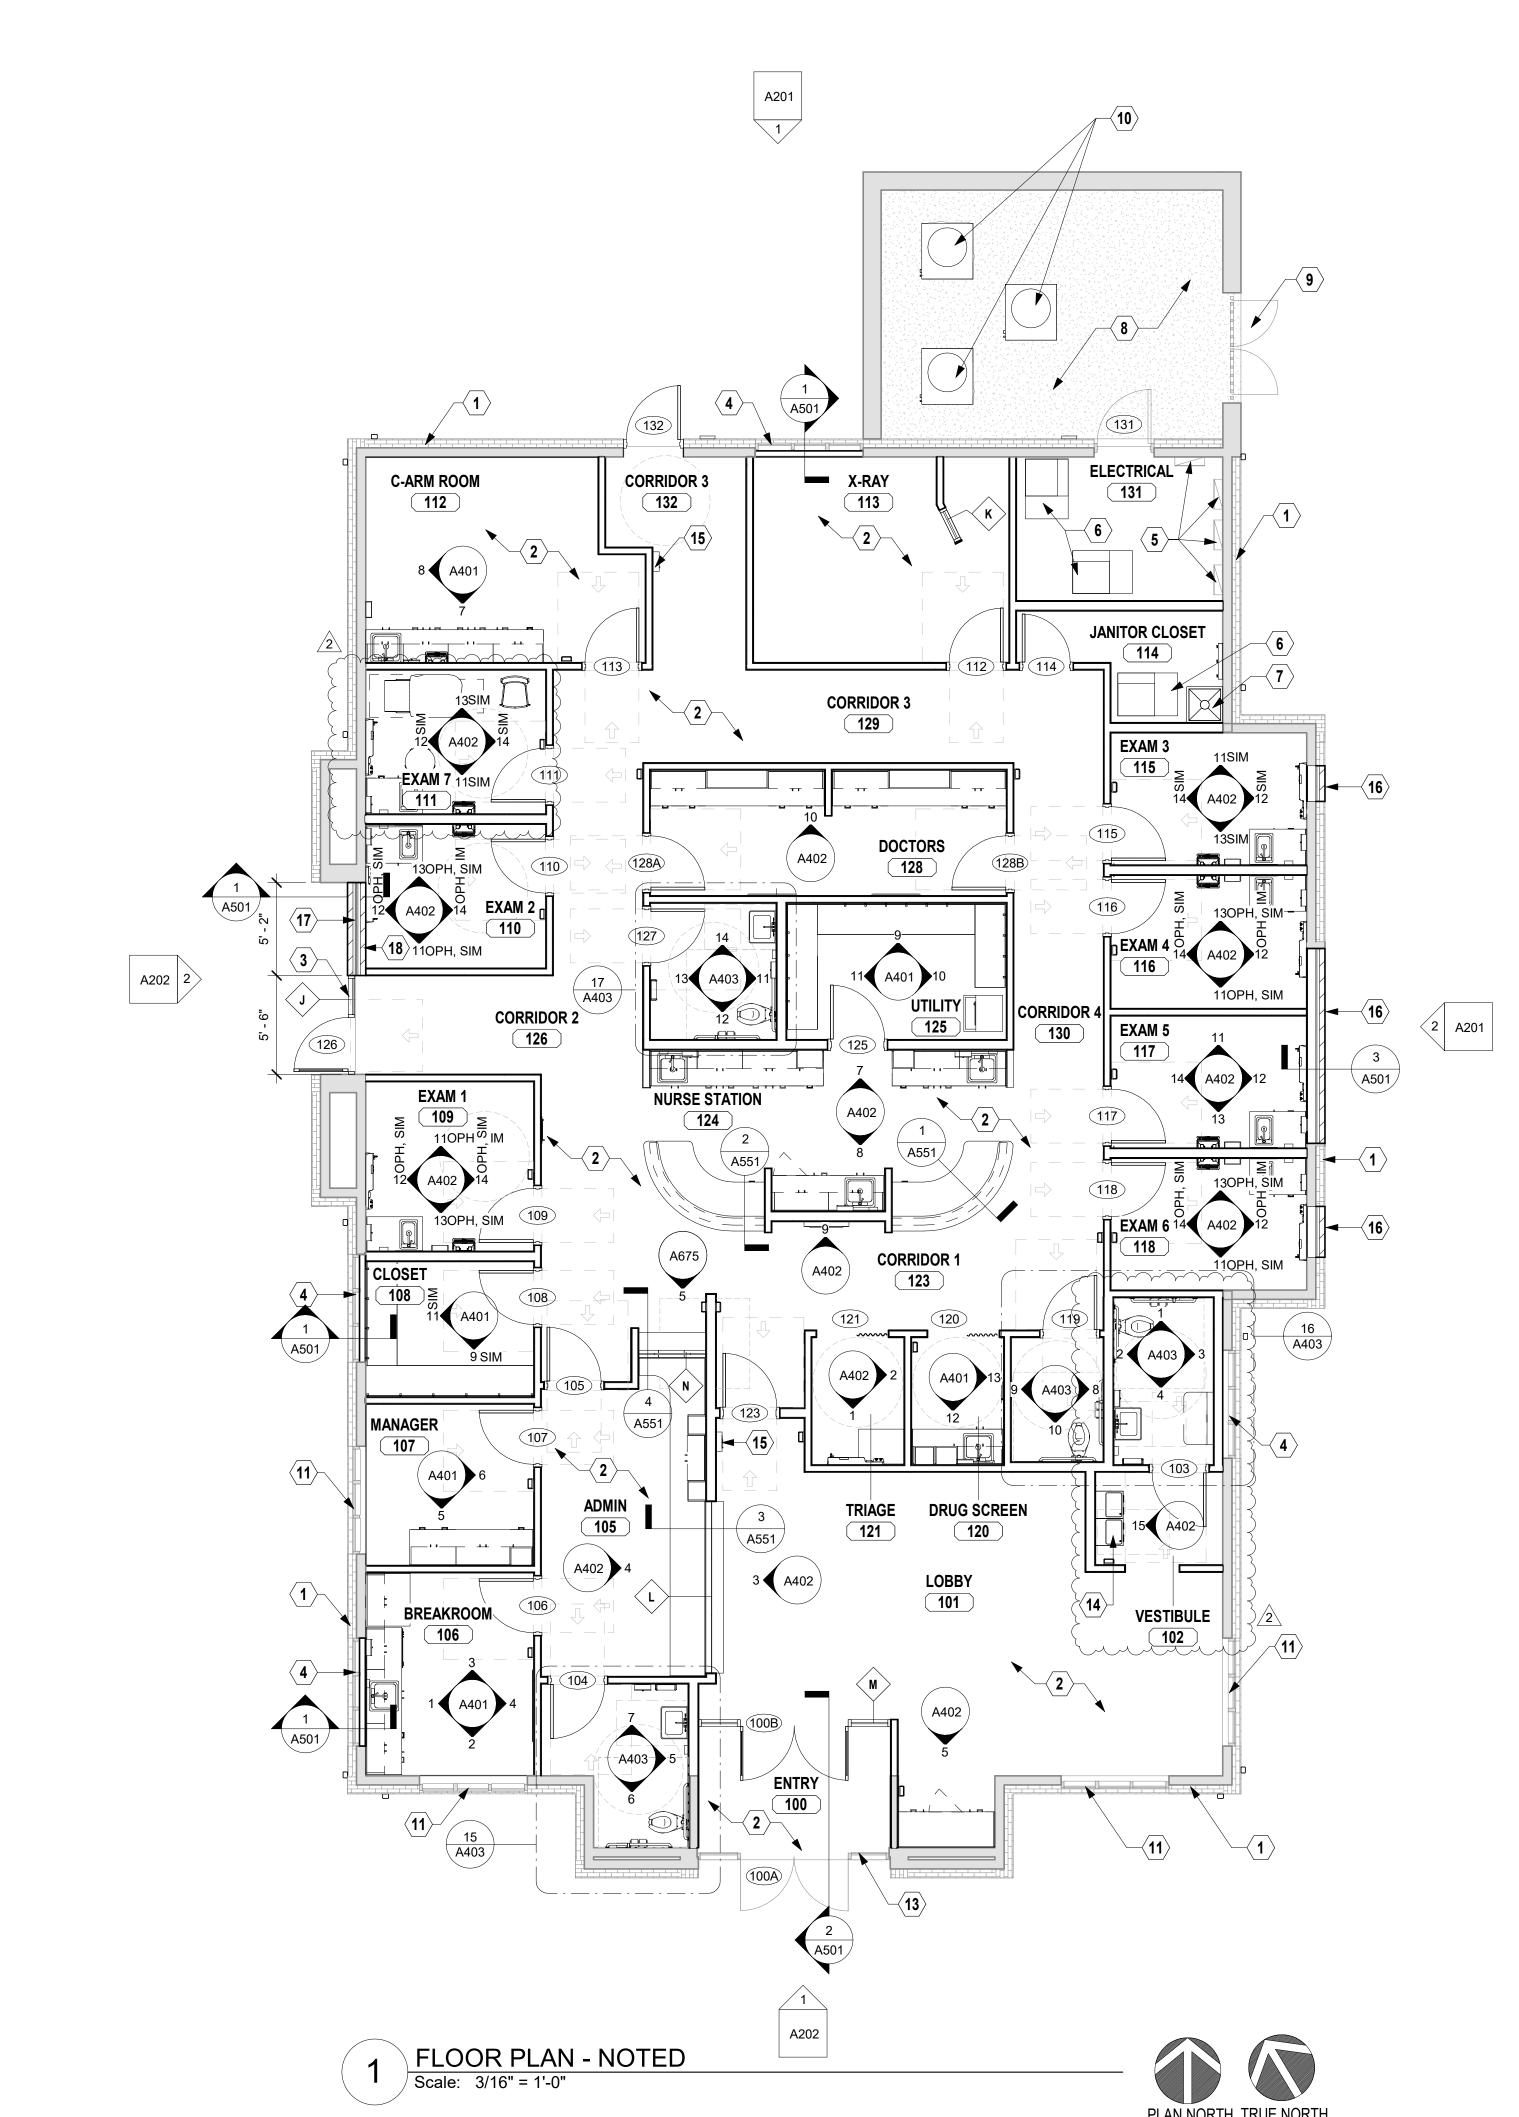



DOOR MARK TAG

REFER TO SHEET A651 FOR DOOR SCHEDULE WALL TYPE TAG

REFER TO SHEET A*** FOR WALL SCHEDULE WINDOW TYPE TAG

REFER TO SHEET A651 FOR WINDOW SCHEDULE CODED NOTE

TYPICAL ROOM TAG REFER TO SHEET A701 FOR FINISHES

FLOOR PLAN KEY NOTES

1 EXISTING EXTERIOR WALL

- EXISTING CONCRETE SLAB TO BE LEVELED AND PREPARED FOR NEW FLOORING. CAP 2 AND FILL OLD STUB UPS FOR ELECTRICAL AND PLUMBING ETC. AND INFILL AS REQUIRED
- FOR FLOORING TYP. NEW EXTERIOR STOREFRONT DOOR AND SIDE LITE TO MATCH EXISTING WINDOW SYSTEM
- SEE DOOR AND WINDOW SCHEDULE. PROVIDE BLACK OUT WINDOW TINT ON EXISTING WINDOW, VENT WINDOW CAVITY TO
- 4 PLENUM SPACE ABOVE. PROVIDE NEW FURRING INFILL AT INTERIOR SIDE. SEE DETAIL
- 5 EXISTING ELECTRICAL PANELS SEE ELECTRICAL.
- NEW MECHANICAL UNITS SEE MECHANICAL NEW MOP SINK WITH FRP FROM TOP EDGE TO 96" A.F.F. X 24" WIDE AT BOTH WET WALLS WITH WATER HEATER ABOVE - SEE PLUMBING.
- 8 EXISTING MECHANICAL YARD TO REMAIN.
- 9 EXISTING WROUGHT IRON FENCE TO REMAIN. RE-PAINT TO MATCH EXISTING COLOR.
- 0 NEW MECHANICAL CONDENSING UNIT SEE MECHANICAL.
- 1 EXISTING WINDOW TO REMAIN.
- 13 EXISTING ENTRY TO REMAIN.
- 14 HI LO WATER COOLER, REFER TO PLUMBING DRAWINGS 15 SEMI RECESSED FIRE EXTINGUISHER CABINET
- NEW FRAMED WALL INFILL WITH BATT INSULATION AND EXTERIOR BRICK WALL INFILL AT
- PREVIOUSLY REMOVED EQUIPMENT. TOOTH-IN ALL BRICK INFILL NEW FRAMED WALL INFILL WITH BATT INSULATION AND EXTERIOR BRICK WALL INFILL AT PORTION OF DEMOLISHED WINDOW. TOOTH-IN ALL BRICK INFILL.
- 18 FURR OUT INTERIOR WALL TO MATCH ADJACENT

FLOOR PLAN GENERAL NOTES

- A. INTERIOR WALL DIMENSIONS ARE FROM THE FACE OF STUD, U.N.O.
- B. EXTERIOR WALL DIMENSIONS ARE FROM INTERIOR FACE OF GYPSUM BOARD OR THE EXTERIOR FACE OF PLYWOOD.
- C. ALL GYPSUM BOARD BELOW FINISHED CEILING HEIGHT IS TO BE PREPARED FOR PAINTING OR WALL COVERINGS AS INDICATED ON INTERIOR ELEVATIONS AND FINISH SCHEDULE.
- D. REFER TO FINISH SCHEDULE, FINISH PLAN AND ELEVATIONS FOR APPLIED
- E. SEE STRUCTURAL PLANS FOR CONCRETE INFILL AND DOWEL REQUIRMENTS AT SEWER LINES.



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David Heard 10/19/2020

Final Approval Subject to Field Inspection

10/9/20	
Project nun	nber: 757942-01
Scale:	As indicated
Drawn:	MRC, AHS
Checked:	ВТВ
Date:	2020.10.08
Issue:	REVISION 1 AND 2

NOTED FLOOR PLAN -GROUND FLOOR

A102